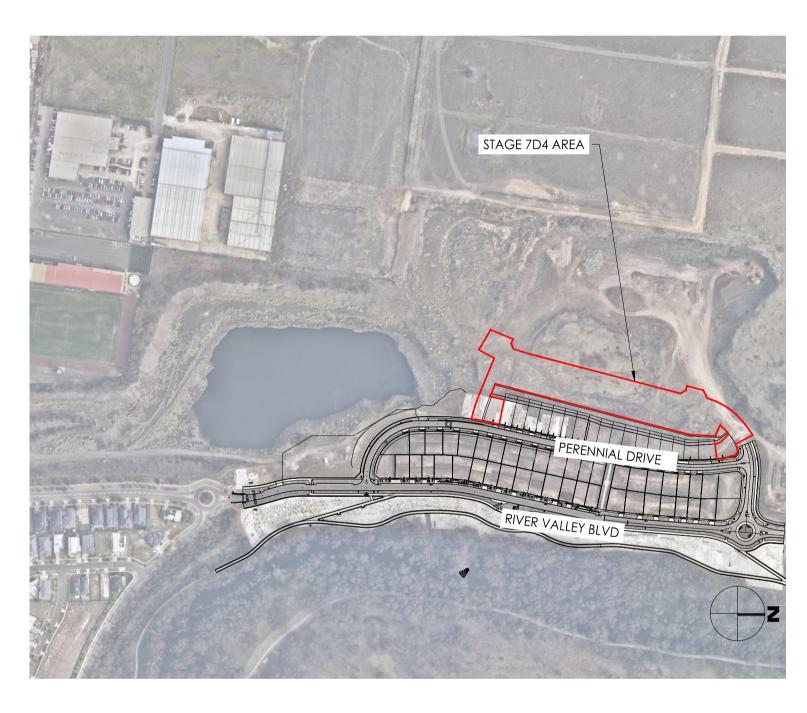
RIVER VALLEY - STAGE 7D4


MINERAL TERRACE, SUNSHINE NORTH, VIC

CIVIL SITEWORKS



LOCATION PLAN (N.T.S)

	DRAWING SCHEDULE
Sheet Number	Sheet Title
I 5006-CJA-7D4-00-DR-C-0000	TITLE SHEET AND DRAWING SCHEDULE
15006-CJA-7D4-00-DR-C-0000 15006-CJA-7D4-00-DR-C-0001	NOTES PAGE
15006-CJA-7D4-00-DR-C-0001 15006-CJA-7D4-00-DR-C-0100	EXISTING CONDITIONS PLAN
15006-CJA-7D4-00-DR-C-0200	STAGING PLAN
15006-CJA-7D4-00-DR-C-1000	OVERALL LAYOUT PLAN
15006-CJA-7D4-00-DR-C-1050	DRAFT SUBDIVISION LAYOUT PLAN
15006-CJA-7D4-00-DR-C-1100	DETAILED LAYOUT PLAN (SHEET 1 OF 2)
15006-CJA-7D4-00-DR-C-1101	DETAILED LAYOUT PLAN (SHEET 2 OF 2)
15006-CJA-7D4-00-DR-C-2000	TYPICAL SECTION - WHOLE SITE
15006-CJA-7D4-00-DR-C-2001	TYPICAL SECTION - SITE SECTIONS (SHEET 1 OF 2)
5006-CJA-7D4-00-DR-C-2002	TYPICAL SECTION - SITE SECTIONS (SHEET 2 OF 2)
15006-CJA-7D4-00-DR-C-2100	TYPICAL ROAD CROSS SECTIONS (SHEET 1 OF 2)
15006-CJA-7D4-00-DR-C-2101	TYPICAL ROAD CROSS SECTIONS (SHEET 2 OF 2)
15006-CJA-7D4-00-DR-C-2102	CRITICAL SECTION CALCULATION (SHEET 1 OF 2)
5006-CJA-7D4-00-DR-C-2103	CRITICAL SECTION CALCULATION (SHEET 2 OF 2)
15006-CJA-7D4-00-DR-C-2104	HYDROLOGY CATCHMENT REPORT
I 5006-CJA-7D4-00-DR-C-2105	HGL PIPE CAPACITY REPORT
I 5006-CJA-7D4-00-DR-C-4000	LONG SECTION - CONCRETE SLEEPER WALL (SHEET 1 OF 3)
15006-CJA-7D4-00-DR-C-4001	LONG SECTION - CONCRETE SLEEPER WALL (SHEET 2 OF 3)
I 5006-CJA-7D4-00-DR-C-4002	LONG SECTION - CONCRETE SLEEPER WALL (SHEET 3 of 3)
15006-CJA-7D4-00-DR-C-5000	ROAD LONG SECTION - MINERAL TERRACE (SHEET 1 OF 4)
15006-CJA-7D4-00-DR-C-5001	ROAD LONG SECTION - MINERAL TERRACE (SHEET 2 OF 4)
15006-CJA-7D4-00-DR-C-5002	ROAD LONG SECTION - MINERAL TERRACE (SHEET 3 OF 4)
	ROAD LONG SECTION - PARKSIDE CIRCUIT (SHEET 4 OF 4)
15006-CJA-7D4-00-DR-C-5003	,
15006-CJA-7D4-00-DR-C-5100	CROSS SECTIONS - MINERAL TERRACE (SHEET 1 OF 15)
15006-CJA-7D4-00-DR-C-5101	CROSS SECTIONS - MINERAL TERRACE (SHEET 2 OF 15)
15006-CJA-7D4-00-DR-C-5102	CROSS SECTIONS - MINERAL TERRACE (SHEET 3 OF 15)
15006-CJA-7D4-00-DR-C-5103	CROSS SECTIONS - MINERAL TERRACE (SHEET 4 OF 15)
15006-CJA-7D4-00-DR-C-5104	CROSS SECTIONS - MINERAL TERRACE (SHEET 5 OF 15)
I 5006-CJA-7D4-00-DR-C-5105	CROSS SECTIONS - MINERAL TERRACE (SHEET 6 OF 15)
I 5006-CJA-7D4-00-DR-C-5106	CROSS SECTIONS - MINERAL TERRACE (SHEET 7 OF 15)
15006-CJA-7D4-00-DR-C-5107	CROSS SECTIONS - MINERAL TERRACE (SHEET 8 OF 15)
15006-CJA-7D4-00-DR-C-5108	CROSS SECTIONS - MINERAL TERRACE (SHEET 9 OF 15)
15006-CJA-7D4-00-DR-C-5109	CROSS SECTIONS - MINERAL TERRACE (SHEET 10 OF 15)
15006-CJA-7D4-00-DR-C-5110	CROSS SECTIONS - MINERAL TERRACE (SHEET 11 OF 15)
15006-CJA-7D4-00-DR-C-5111	CROSS SECTIONS - MINERAL TERRACE (SHEET 12 OF 15)
I 5006-CJA-7D4-00-DR-C-5112	CROSS SECTIONS - MINERAL TERRACE (SHEET 13 OF 15)
I5006-CJA-7D4-00-DR-C-5113	CROSS SECTIONS - MINERAL TERRACE (SHEET 14 OF 15)
15006-CJA-7D4-00-DR-C-5114	CROSS SECTIONS - MINERAL TERRACE (SHEET 15 OF 15)
15006-CJA-7D4-00-DR-C-5200	INTERSECTION PLANS
15006-CJA-7D4-00-DR-C-5201	TYPICAL RAISED INTERSECTION DETAILS
	PROPOSED STORMWATER LONG SECTIONS (SHEET 1 OF 3)
15006-CJA-7D4-00-DR-C-6100	PROPOSED STORMWATER LONG SECTIONS (SHEET 2 OF 3)
15006-CJA-7D4-00-DR-C-6101	,
15006-CJA-7D4-00-DR-C-6102	PROPOSED STORMWATER LONG SECTIONS (SHEET 3 OF 3)
15006-CJA-7D4-00-DR-C-6103	BEDDING DETAILS - STORMWATER
5006-CJA-7D4-00-DR-C-8000	CONSTRUCTION DETAILS - PAVEMENTS & KERBS
5006-CJA-7D4-00-DR-C-8005	CONSTRUCTION DETAILS - FENCING
5006-CJA-7D4-00-DR-C-8020	CONSTRUCTION DETAILS - RETAINING WALLS (SHEET 1 OF 2)
15006-CJA-7D4-00-DR-C-8021	CONSTRUCTION DETAILS - RETAINING WALLS (SHEET 2 OF 2)
15006-CJA-7D4-00-DR-C-8100	CONSTRUCTION SETOUT - HV KIOSK (SHEET 1 OF 2)
15006-CJA-7D4-00-DR-C-8101	CONSTRUCTION SETOUT - HV KIOSK (SHEET 2 OF 2)
I 5006-CJA-7D4-00-DR-C-8500	SIGNAGE AND LINEMARKING PLAN - (SHEET 1 OF 2)
I 5006-CJA-7D4-00-DR-C-8501	SIGNAGE AND LINEMARKING PLAN - (SHEET 2 OF 2)
I 5006-CJA-7D4-00-DR-C-9050	SERVICES & STREETSCAPE CO-ORDINATION PLAN (SHEET 1 OF 2)
15006-CJA-7D4-00-DR-C-9051	SERVICES & STREETSCAPE CO-ORDINATION PLAN (SHEET 2 OF 2)
15006-CJA-7D4-00-DR-C-9200	SUBDIVISION PLAN (SHEET 1 OF 4)
15006-CJA-7D4-00-DR-C-7200 15006-CJA-7D4-00-DR-C-9201	SUBDIVISION PLAN (SHEET 2 OF 4)
	SUBDIVISION PLAN (SHEET 3 OF 4)
15006-CJA-7D4-00-DR-C-9202	, ,
15006-CJA-7D4-00-DR-C-9203	SUBDIVISION PLAN (SHEET 4 OF 4)
15006-CJA-7D4-00-DR-C-9900	FILL LAYOUT PLAN - (SHEET 1 OF 2)
15006-CJA-7D4-00-DR-C-9901	FILL LAYOUT PLAN - (SHEET 2 OF 2)
15006-CJA-7D-XX-DR-EW-1000	STAGE 7D BULK EARTHWORKS - CUT AND FILL PLAN
15006-CJA-7D-DR-C-9600	STORMWATER CATCHMENT PLAN SOUTHERN CATCHMENT

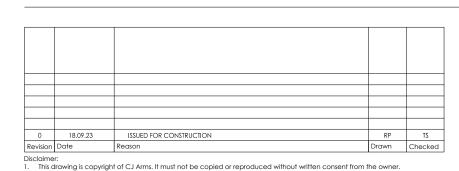

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FOR CONSTRUCTION







7D4

15006 CJA

GENERAL BRIMBANK CITY COUNCIL NOTES

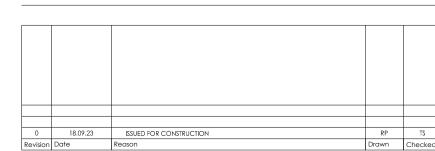
- 1. ALL WORKS TO BE CARRIED OUT IN ACCORDANCE WITH THE SPECIFICATIONS APPROVED BY THE BRIMBANK CITY COUNCIL, BRIMBANK CITY COUNCIL STANDARD DRAWINGS AND TO THE SATISFACTION OF THE SURVEILLANCE COORDINATOR OR HIS REPRESENTATIVE.
- 2. NO TREES AND SHRUBS ARE TO BE REMOVED UNLESS PRIOR APPROVAL HAS BEEN OBTAINED FROM THE RELEVANT AUTHORITY.
- 3. WHERE WORKS ARE IN THE VICINITY OF EXISTING SERVICES, THESE SERVICES ARE TO BE LOCATED PRIOR TO THE COMMENCEMENT OF WORKS.
- 4. ALL VEHICLE CROSSINGS, DRAINAGE PITS, PRAM RAMPS, BOLLARDS ETC SHALL BE CONSTRUCTED AS PER COUNCILS STANDARD DRAWINGS UNLESS OTHERWISE
- COUNCIL'S SURVEILLANCE COORDINATOR MUST BE NOTIFIED IN WRITING, NO LESS
- THAN SEVEN (7) DAYS PRIOR TO THE COMMENCEMENTS OF WORKS. SUBMIT APPLICATION FOR CONSTRUCTION ACCESS TO SITE FOR APPROVAL BY COUNCIL'S SURVEILLANCE COORDINATOR BEFORE COMMENCEMENT OF ANY
- 7. CONTRACTORS ARE RESPONSIBLE WITH RESPECT TO SAFETY OF WORK ON SITE AND APPROPRIATE LEGISLATION.
- 8. FOOTPATHS ARE TO BE OFFSET 25mm FROM THE PROPERTY LINE AND
- CONSTRUCTED AS PER BRIMBANK STANDARD DRAWING \$350. 9. VICROADS' ROADWORK SIGNING CODE OF PRACTICE WHICH COMPLIES WITH AUSTRALIAN STANDARD 1742.3-2002 IS TO BE ADHERED TO DURING CONSTRUCTION WORKS (OR ANY SUBSEQUENT LATER VERSION).
- 10. WHERE DRAINAGE PIPES ARE LOCATED WITHIN NATURE STRIPS, THE TRENCH SHALL BE BACKFILLED WITH COMPACTED 20MM CLASS 3 CRUSHED ROCK UP TO A LEVEL WHERE THE 45DEG. INFLUENCE LINE FROM THE B.O.K. INTERSECTS WITH THE NEAREST
- 11. ALL DRAINAGE PIPES 225mm AND ABOVE SHALL BE SPIGOT & SOCKET TYPE AND RUBBER RING JOINTED CLASS 4 MINIMUM REINFORCED CONCRETE PIPE.
- 12. PROVIDE CCTV FOR COMPLETED DRAINS AS PER CONDUIT INSPECTION REPORTING CODE WSA LATEST VERSION PRIOR TO PRACTICAL COMPLETION OR STATEMENT OF COMPLIANCE, WHICHEVER IS EARLIER
- 13. SERVICE CONDUITS ARE TO BE PROVIDED UNDER FOOTPATHS EXTENDING INTO ALLOTMENTS - LOCATION TO BE MARKED ON THE FOOTPATH AND KERB.
- 14. AG DRAINS TO BE PROVIDED BEHIND ALL KERBS AT INTERFACE OF EXISTING AND NEW PAVEMENT AND SHOULD HAVE SUITABLE OUTLET. REFER TO COUNCIL'S STANDARD DRAWING S110 FOR BACKFILL MATERIAL ETC. SOME WORKS MAY REQUIRE SPECIAL CONSIDERATION EG. VICROADS STANDARDS.
- 15. CONDUITS ARE TO BE CLEARLY MARKED ON THE KERB AND FOOTPATH FOR EASY IDENTIFICATION
- 16. ALL SERVICING TRENCHES UNDER ROAD CARRIAGEWAYS, FOOTPATHS, VEHICLE CROSSINGS AND OTHER STRUCTURES ARE TO BE BACKFILLED WITH 20mm CLASS 3 CRUSHED ROCK IN ACCORDANCE WITH SECTION 706 OF COUNCIL'S STANDARD SPECIFICATION FOR ROADS AND DRAINAGE WORKS IN LAND DEVELOPMENT.
- 17. ALL SERVICES MUST BE CONSTRUCTED PRIOR TO THE CONSTRUCTION OF THE KERB AND CHANNEL
- 18. TMP TO BE SUBMITTED TO COUNCIL'S SURVEILLANCE AND/OR TRAFFIC & TRANSPORT SECTION 7 DAYS PRIOR TO COMMENCEMENT OF WORKS FOR ACCEPTANCE.
- 19. STREET LIGHTING SHALL BE LED 18W FOR STANDARD FITTING AND LED 16W TOORAK/TOORAK ALPHA FOR DECORATIVE NON-STANDARD FITTING.
- 20. THE DRAWINGS, "MUST NOT BE SCALED/MEASURED' FROM HARD OR DIGITAL COPIES.
- 21. MINIMUM EARTHWORKS FILLING REQUIREMENTS FOR ALL ROAD WORKS: a. ROAD FILLING WORKS SHALL BE IN ACCORDANCE WITH SECTION 204 OF COUNCIL'S STANDARD SPECIFICATION FOR ROADS AND DRAINAGE WORKS IN LAND DEVELOPMENT.
 - b. TYPE A FILL IS REQUIRED FOR THE LAST 200mm LAYER UNDER ROAD PAVEMENTS, FOOTPATHS, VEHICLE CROSSINGS, NATURE STRIPS AND OTHER ROAD STRUCTURES.
 - C. TYPE A MATERIAL IS SPECIFIED IN SECTION 204 OF COUNCIL'S STANDARD SPECIFICATION FOR ROADS AND DRAINAGE WORKS IN LAND DEVELOPMENTS (EQUIVALENT TO THE LATEST VERSION OF VICROADS' CONTRACT SPECIFICATIONS) AND SHALL HAVE MAXIMUM SWELL OF ≤1.5%, MAXIMUM PERMEABILITY OF 5 X 10⁻⁷ CM/SEC, MAXIMUM BOULDER SIZE IS 75 MM ROCK WITH NO OTHER GRADING REQUIREMENTS, AND WITH 99% OF STANDARD COMPACTIVE EFFORT (SCALE A OF TABLE 204.131).
 - d. NATURE STRIP WIDTHS SHALL BE FINISHED OFF WITH 100mm THICK TOP SOIL MATERIAL RECOVERED FROM STRIPPING PRIOR TO THE CONSTRUCTION OF EARTHWORKS OR OTHER IMPORTED TOPSOIL TO COMPLY WITH COUNCIL'S LANDSCAPE REQUIREMENTS.
- 22. FILL MATERIAL TO BE IMPORTED TO SITE WILL BE SUBJECT TO THE FOLLOWING
- CONTROLS: a. BORROW MATERIAL FOR FILLING WORKS IS TO BE SIGNED OFF BY A SUITABLY QUALIFIED INDEPENDENT ENVIRONMENTAL SCIENTIST TO BE CLEAN FILL TO MEET EPA DEFINITION. THE SCIENTIST MUST BE RECOGNISED BY THE EPA TO UNDERTAKE SUCH A JOB.
- THE INDEPENDENT ENVIRONMENTAL SCIENTIST IS TO CERTIFY THAT THE SOURCE OR SOURCES OF BORROW MATERIAL TO MEET THE EPA DEFINITION OF CLEAN FILL SUITABLE FOR ROAD CONSTRUCTION. THE SCIENTIST IS TO OVERSEE ALL TESTING, FREQUENCY OF TESTING, ETC. TO MEET EPA REQUIREMENTS FOR CLEAN FILL.
- THE SCIENTIST IS TO ENSURE THAT ONLY THE CERTIFIED CLEAN FILL MATERIAL IS USED. TRANSPORTATION DOCKETS ARE TO BE ISSUED FOR EACH TRUCK LOAD. DATE AND TIME OF LOADING AND ARRIVAL ON SITE ARE TO BE
- AT THE END OF BORROW FILLING, A REPORT IS TO BE SUBMITTED TO COUNCIL BY THE INDEPENDENT SCIENTIST DETAILING THE TESTINGS CARRIED
- OUT LEADING TO THE APPROVAL OF THE SOURCE OR SOURCES. THE REPORT IS ALSO TO INCLUDE COPIES OF ALL THE TRANSPORTATION
- DOCKETS AND SUMMARY OF THE REQUIRED BORROW VOLUME. IN THE REPORT, THE SCIENTIST IS TO SIGN OFF THE COMPLETED BORROW FILL WORKS FOR EPA REQUIREMENTS FOR CLEAN FILL WORKS.
- b. BORROW MATERIAL FILLING WORKS IS TO BE SIGNED OFF BY A SUITABLY QUALIFIED INDEPENDENT (NATA REGISTERED COMPANY) GEOTECHNICAL ENGINEER TO BE TYPE B FILL TO MEET BCC SPECIFICATIONS FOR TYPE B FILL
- THE GEOTECHNICAL ENGINEER IS TO APPROVE THE SOURCE OR SOURCES OF THE BORROW MATERIAL THAT MEETS TYPE B FILL (INCLUDING MINIMUM
- THE GEOTECHNICAL ENGINEER IS TO CARRY OUT ALL THE TESTING AT THE
- SITE OR SOURCE(S) AS REQUIRED IN SECTION 204. • THE ENGINEER IS TO ENSURE THAT ONLY THE CERTIFIED TYPE B FILL MATERIAL IS USED. TRANSPORTATION DOCKETS ARE TO BE ISSUED FOR EACH TRUCK LOAD. DATE AND TIME OF LOADING AND ARRIVAL ON SITE ARE TO BE
- RECORDED. • AT THE COMPLETION OF THE FILLING WORKS, THE ENGINEER IS TO SUBMIT A SEPARATE REPORT TO COUNCIL TO VERIFY ALL BORROW MATERIAL FILLING WORKS MEET THE TYPE B SPECIFICATION.
- IN THE REPORT, THE GEOTECHNICAL ENGINEER IS TO SIGN OFF THE COMPLETED BORROW FILL WORKS THAT MEET TYPE B SPECIFICATIONS.
- c. PRIOR TO THE COMMENCEMENT OF THE BORROW MATERIAL FILLING, BOTH THE SCIENTIST AND THE GEOTECHNICAL ENGINEER ARE TO INFORM COUNCIL SURVEILLANCE OF THE APPROVED SOURCE OR SOURCES OF BORROW MATERIAL AND SUBMIT TESTING RESULTS VERIFYING THE ACCEPTANCE OF THE MATERIAL.

ADDITIONAL GENERAL NOTES

- 23. EARTHWORKS & SEDIMENTATION CONTROL
- a. NO POLLUTED OR SEDIMENT LADEN RUNOFF IS TO BE DISCHARGED DIRECTLY OR INDIRECTLY INTO EXISTING DRAINAGE SYSTEM DURING OR AFTER THE WORKS.
- b. STOCKPILING OF MATERIAL IS TO BE PLACED AS DIRECTED BY THE SUPERINTENDENT.
- 24. ALL LEVELS & SETOUT TO MGA55 AND AHD.
- PRECEDENCE OVER BCC EARTHWORKS REQUIREMENTS. 26. PIPE BEDDING AND BACKFILL TO BE IN ACCORDANCE WITH BCC SPECIFICATION 701A. 27. ABORIGINAL PROTECTION REQUIREMENTS MUST BE ADHERED TO AS PER PLANNING PERMIT

25. AS PART OF THESE WORKS DOUGLAS AND PARTNERS EARTHWORKS SPECIFICATION WILL TAKE

- CONDITIONS 6 AND 7 28. ENVIRONMENTAL MANAGEMENT PLAN MUST BE SUBMITTED AND APPROVED AS PER
- PLANNING PERMIT CONDITION 5
- 29. ADHERE TO PLANNING PERMIT CONDITIONS 12 & 13
- 30. OBTAIN APPROVAL FOR CONSTRUCTION VEHICLE ACCESS AS PER PLANNING PERMIT CONDITION 44 31. NO SERVICES SHALL BE INSTALLED DIRECTLY UNDER AND PARALLEL TO COUNCIL'S PAVEMENT AND
- FOOTPATH WITHOUT COUNCIL'S APPROVAL.
- 32. ALL SERVICE CLEARANCES TO MEET COUNCIL AND AUTHORITY REQUIREMENTS.



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FOR CONSTRUCTION







NOTES PAGE RIVER VALLEY - STAGE 7D4 Checked By Drawn Scale FOR CONSTRUCTION VR N/A @ A1

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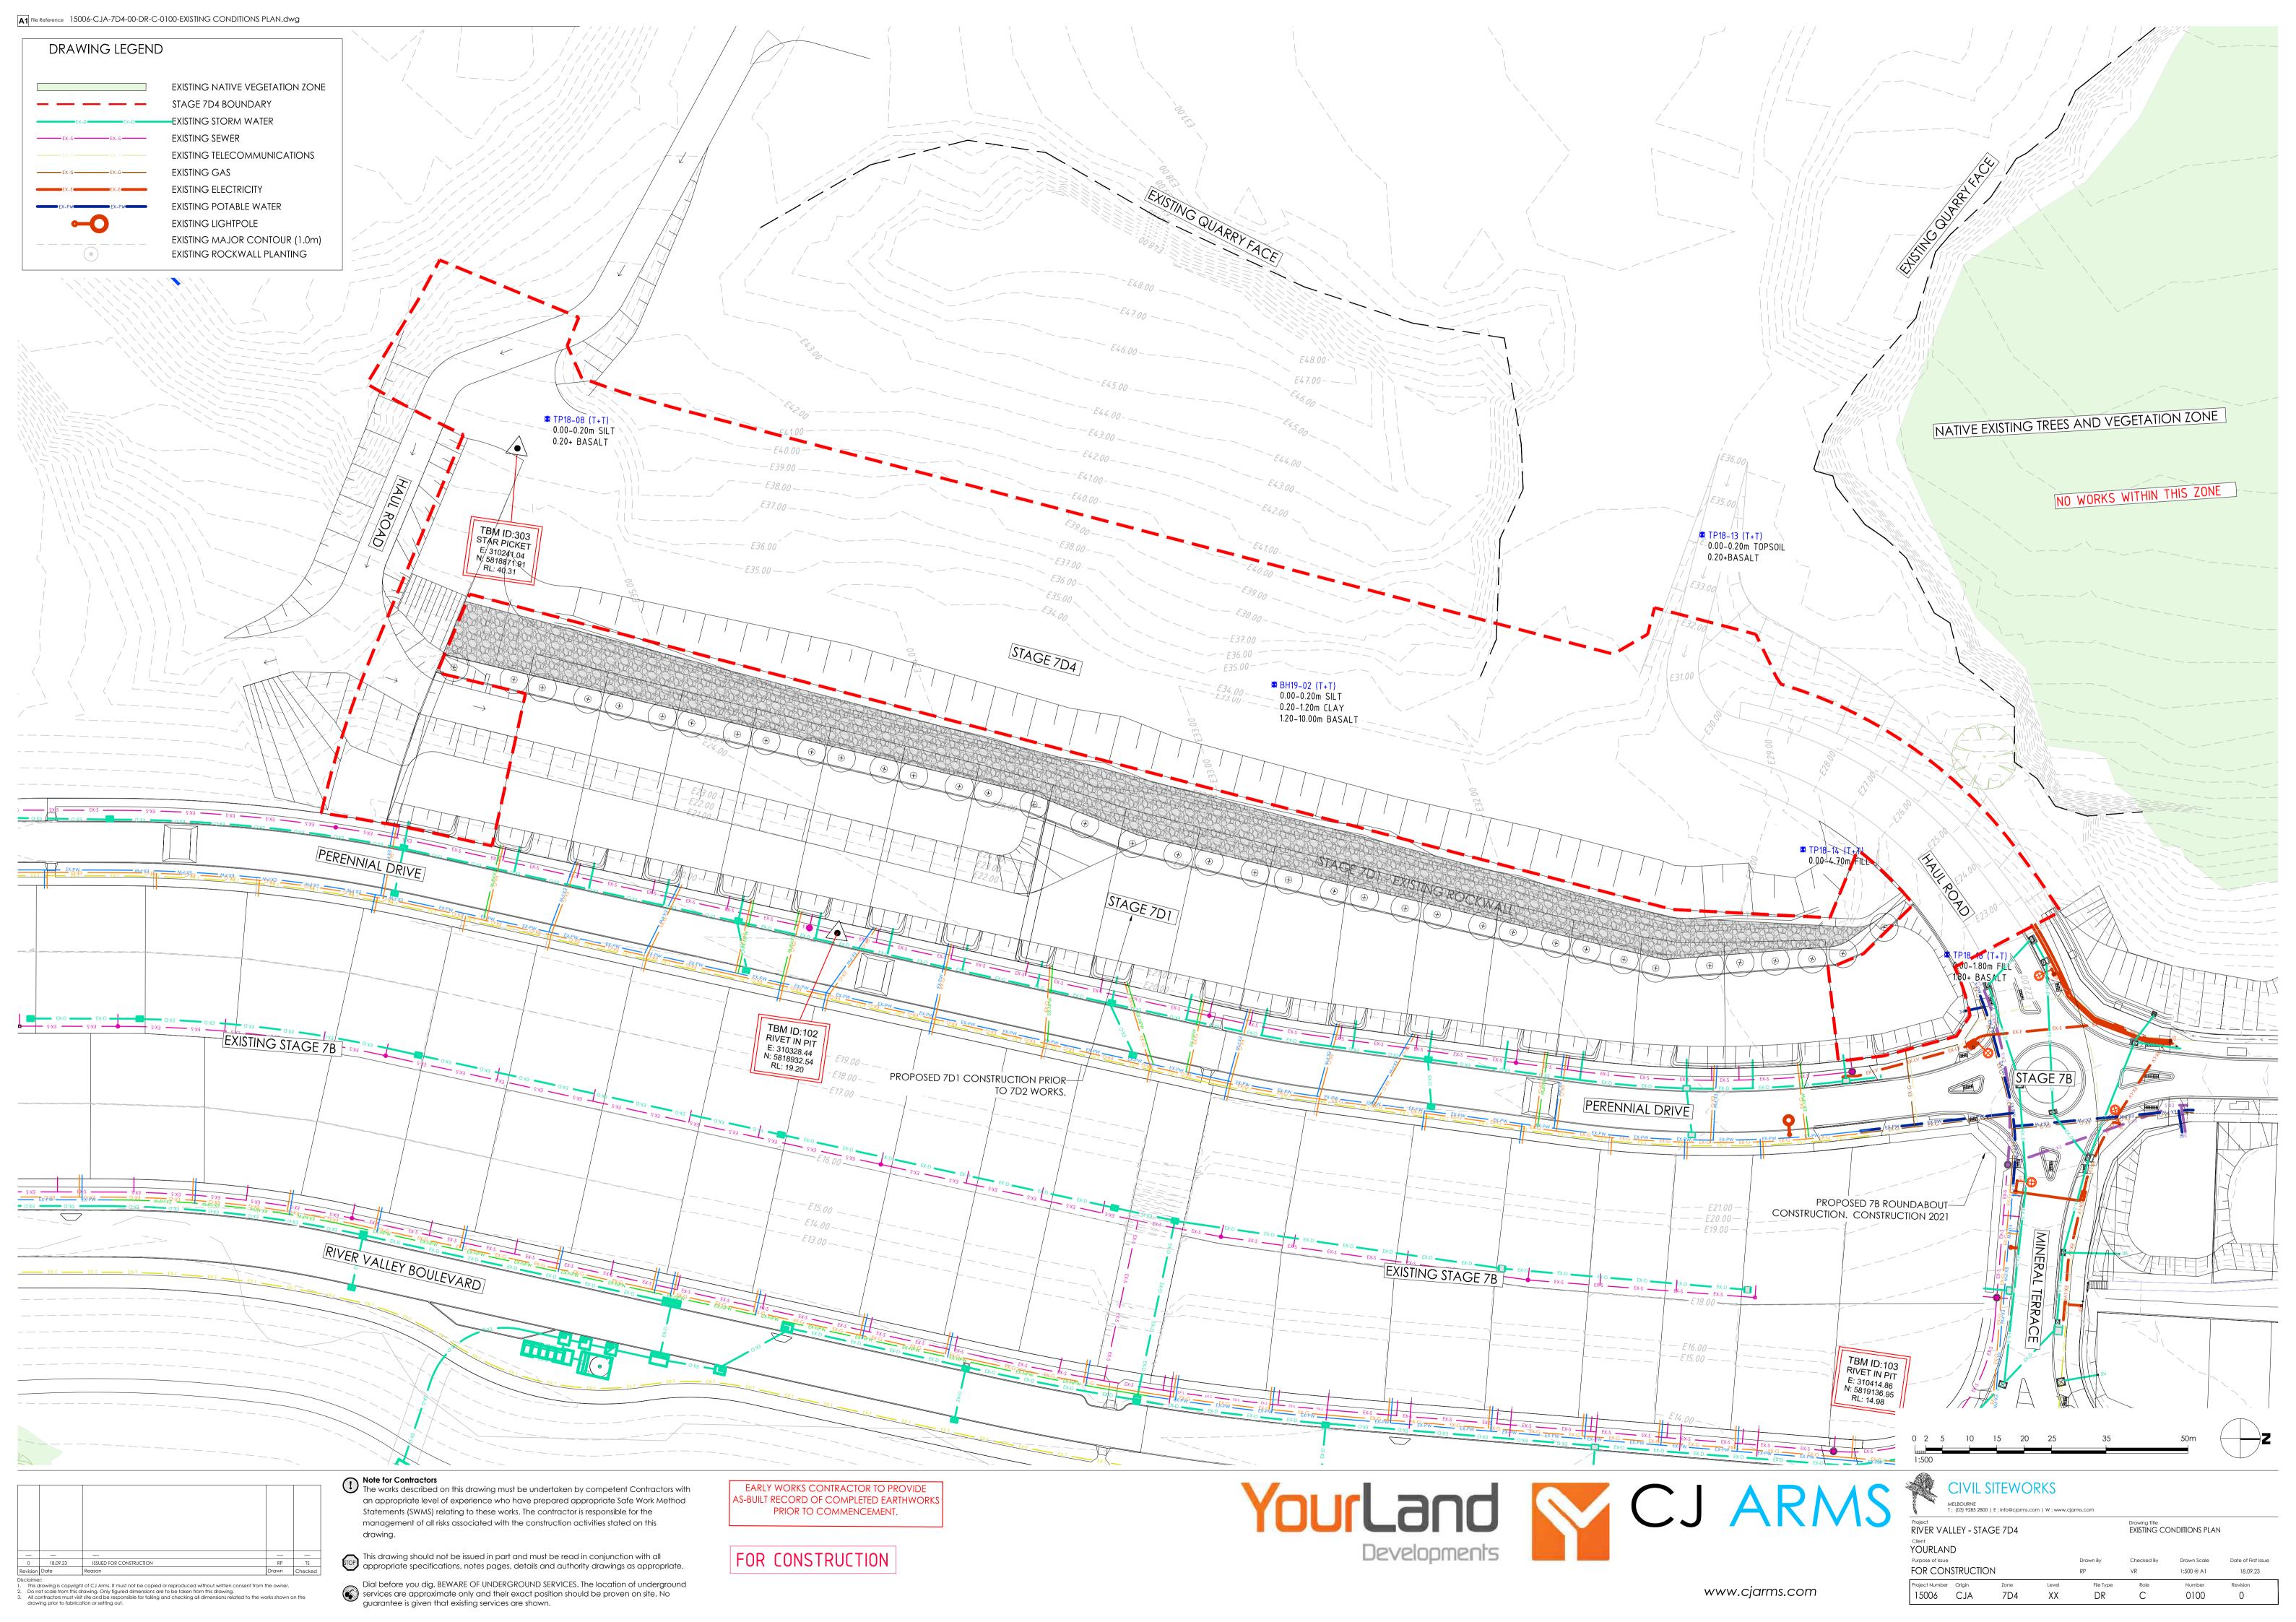
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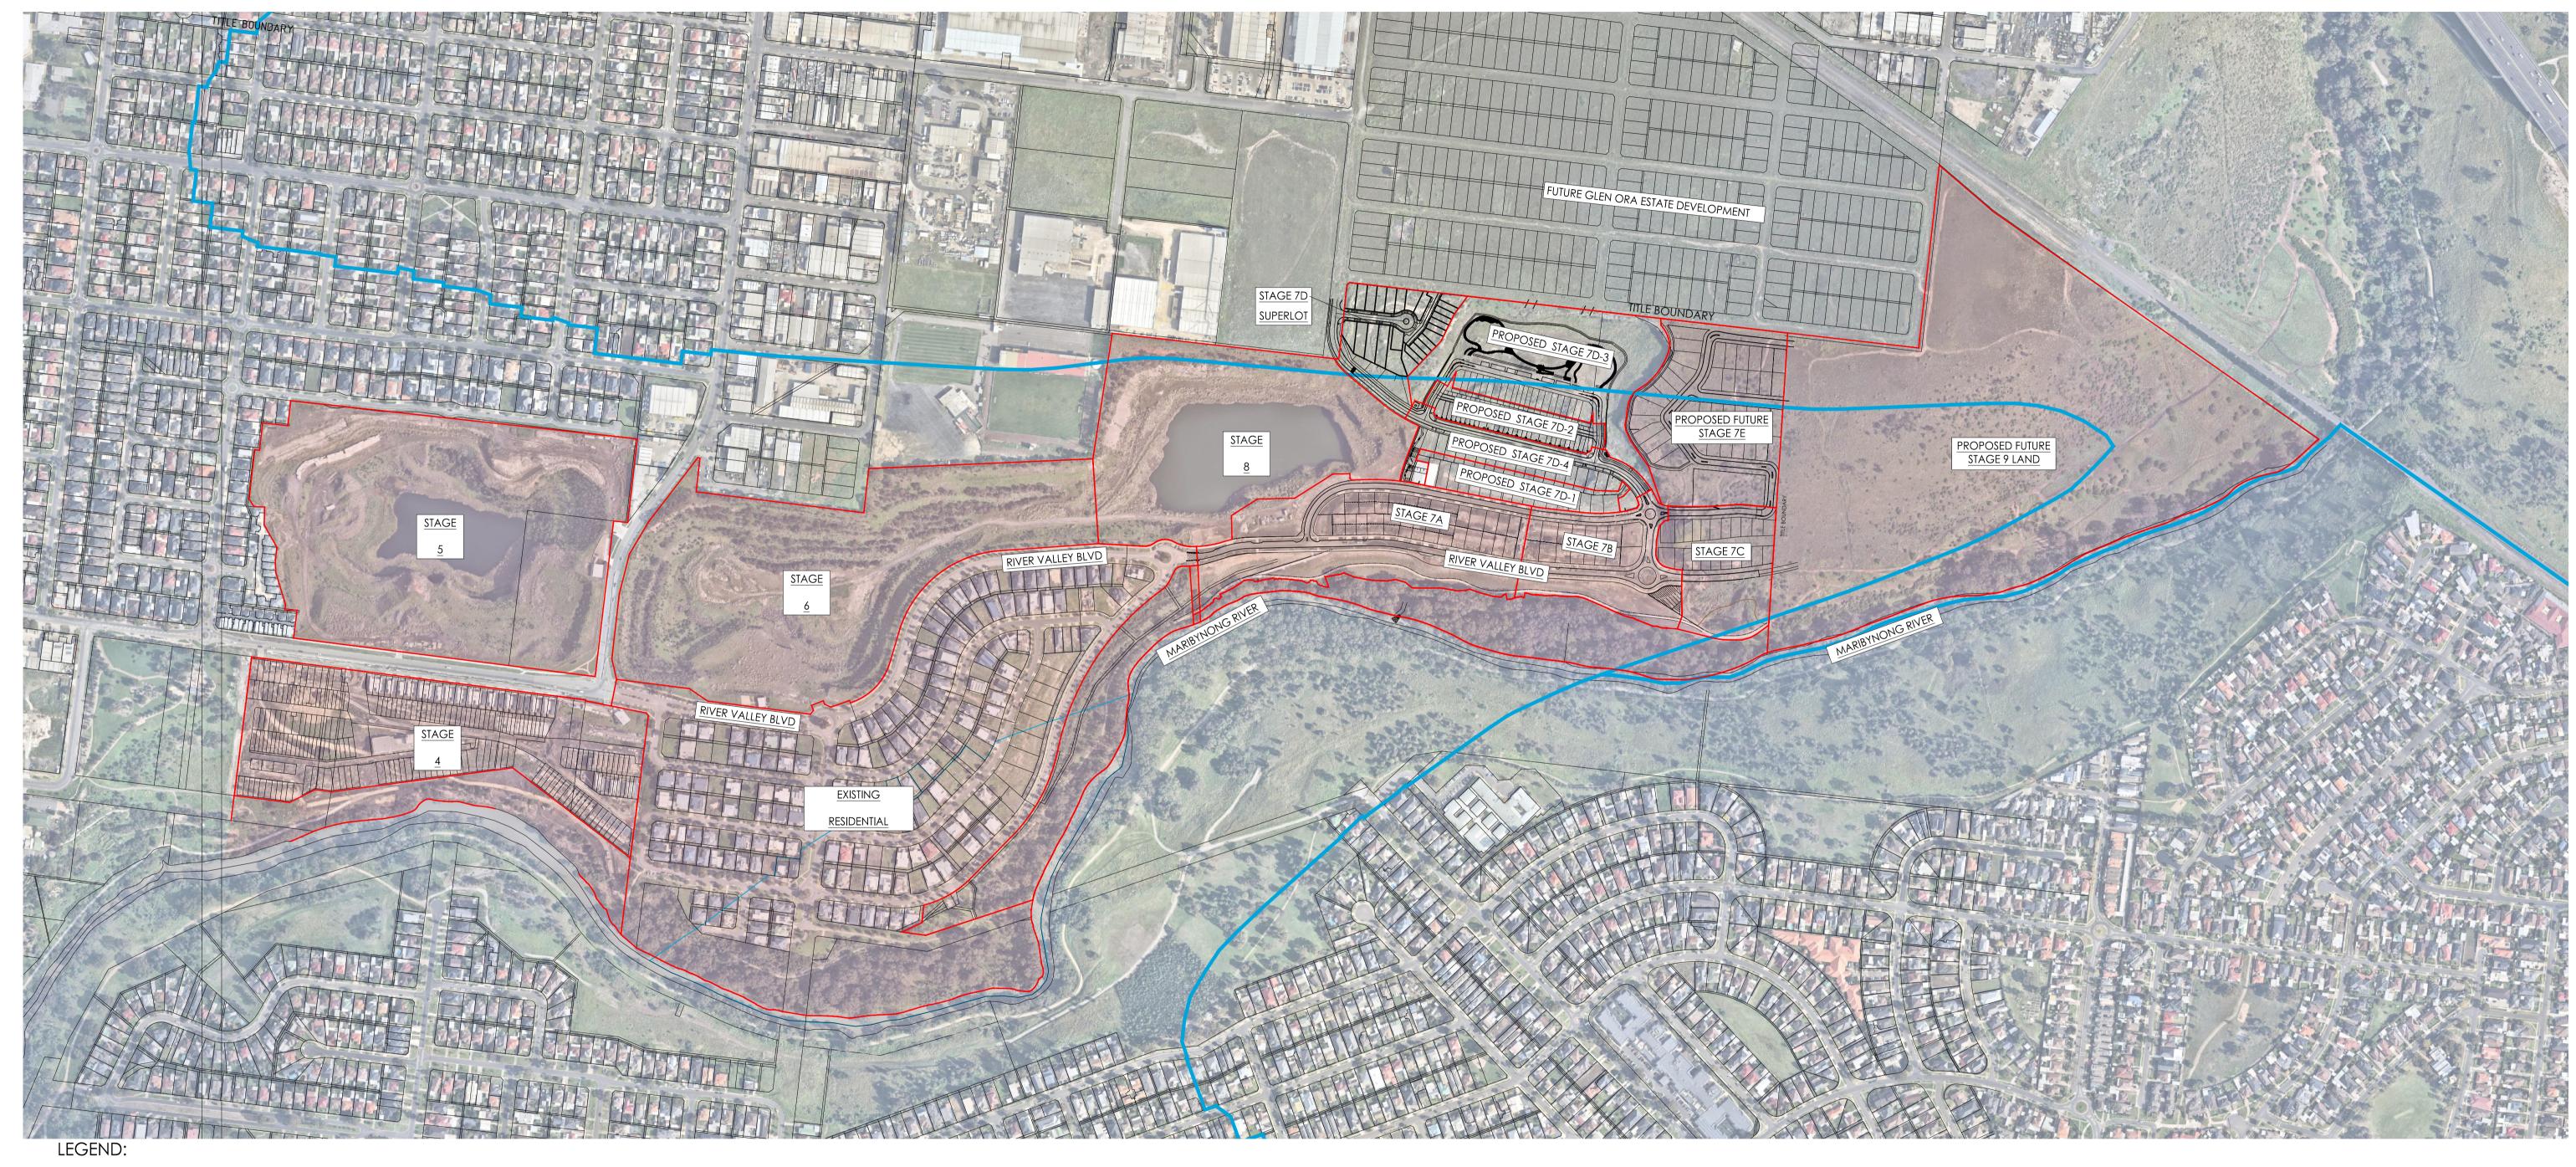
15006 CJA 7D4

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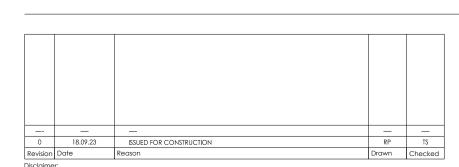
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MAE02 OVERLAY EXTENT STAGE BOUNDARY



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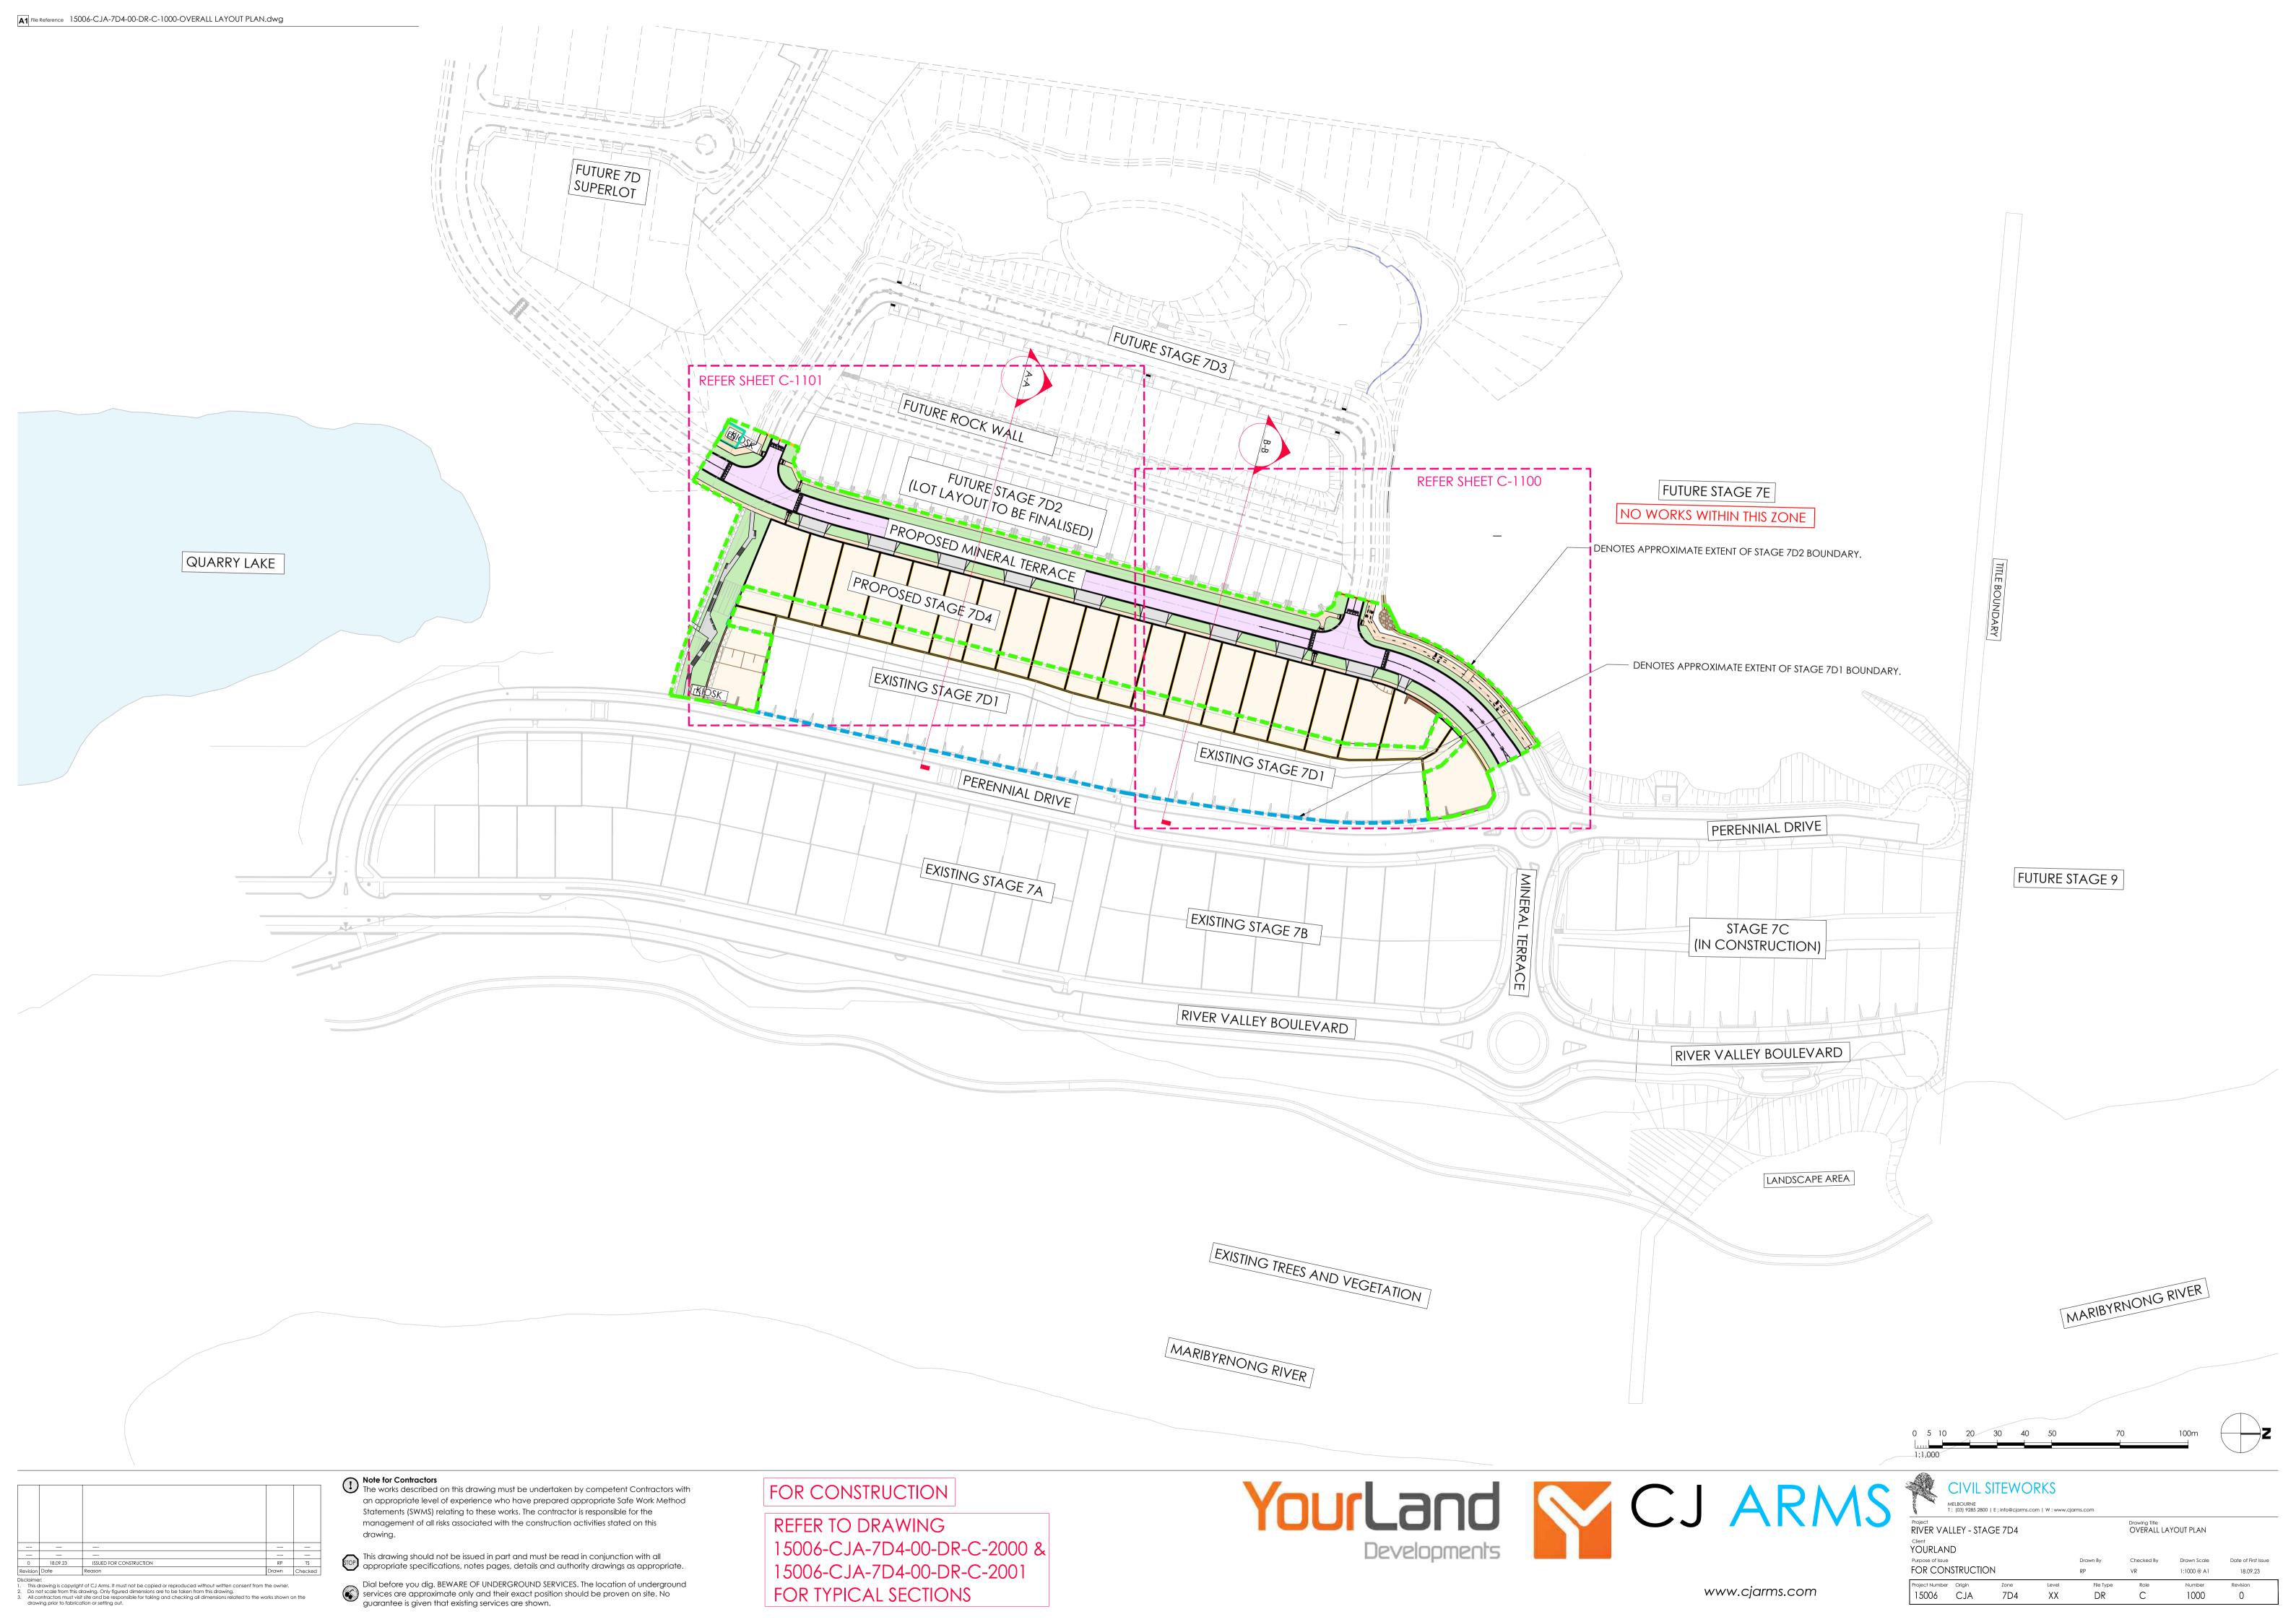
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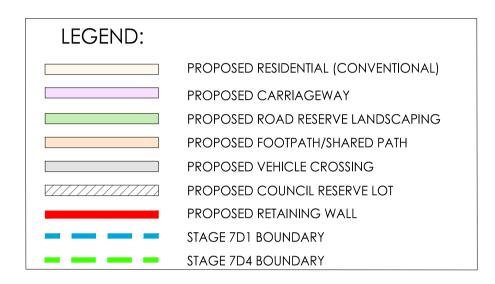




S	CIVIL	SITEWC	PKS				
	Project RIVER VALLEY - STA	AGE 7D4			Drawing Title STAGING PL	AN	
	Purpose of Issue			Drawn By	Checked By	Drawn Scale	Date of First I
	FOR CONSTRUCTION	NC		RP	VR	N/A @ A1	18.09.23
	Project Number Origin	Zone	Level	File Type	Role	Number	Revision
	15006 CJA	7D4	XX	DR	С	0200	0





STAGE 7D4 - DEVELOPM BUDGET	ENT YIELD	LAND
DESCRIPTION	AREA (Ha)	% OF TOTAL AREA
7D4 – TOTAL AREA	1.66	
ROAD INFRASTRUCTURE		
LOCAL ROAD (ACCESS STREET)	0.65	39.3%
SUBTOTAL	0.65	39.3%
RESIDENTIAL		
CONVENTIONAL RESIDENTIAL	0.92	55.5%
COUNCIL RESERVE LOT	0.09	5.3%
SUBTOTAL	1.01	60.7%



STAGE 7D4 NUMBER OF LOTS 21 CONVENTIONAL DENSITY LOTS 1 COUNCIL RESERVE LOT

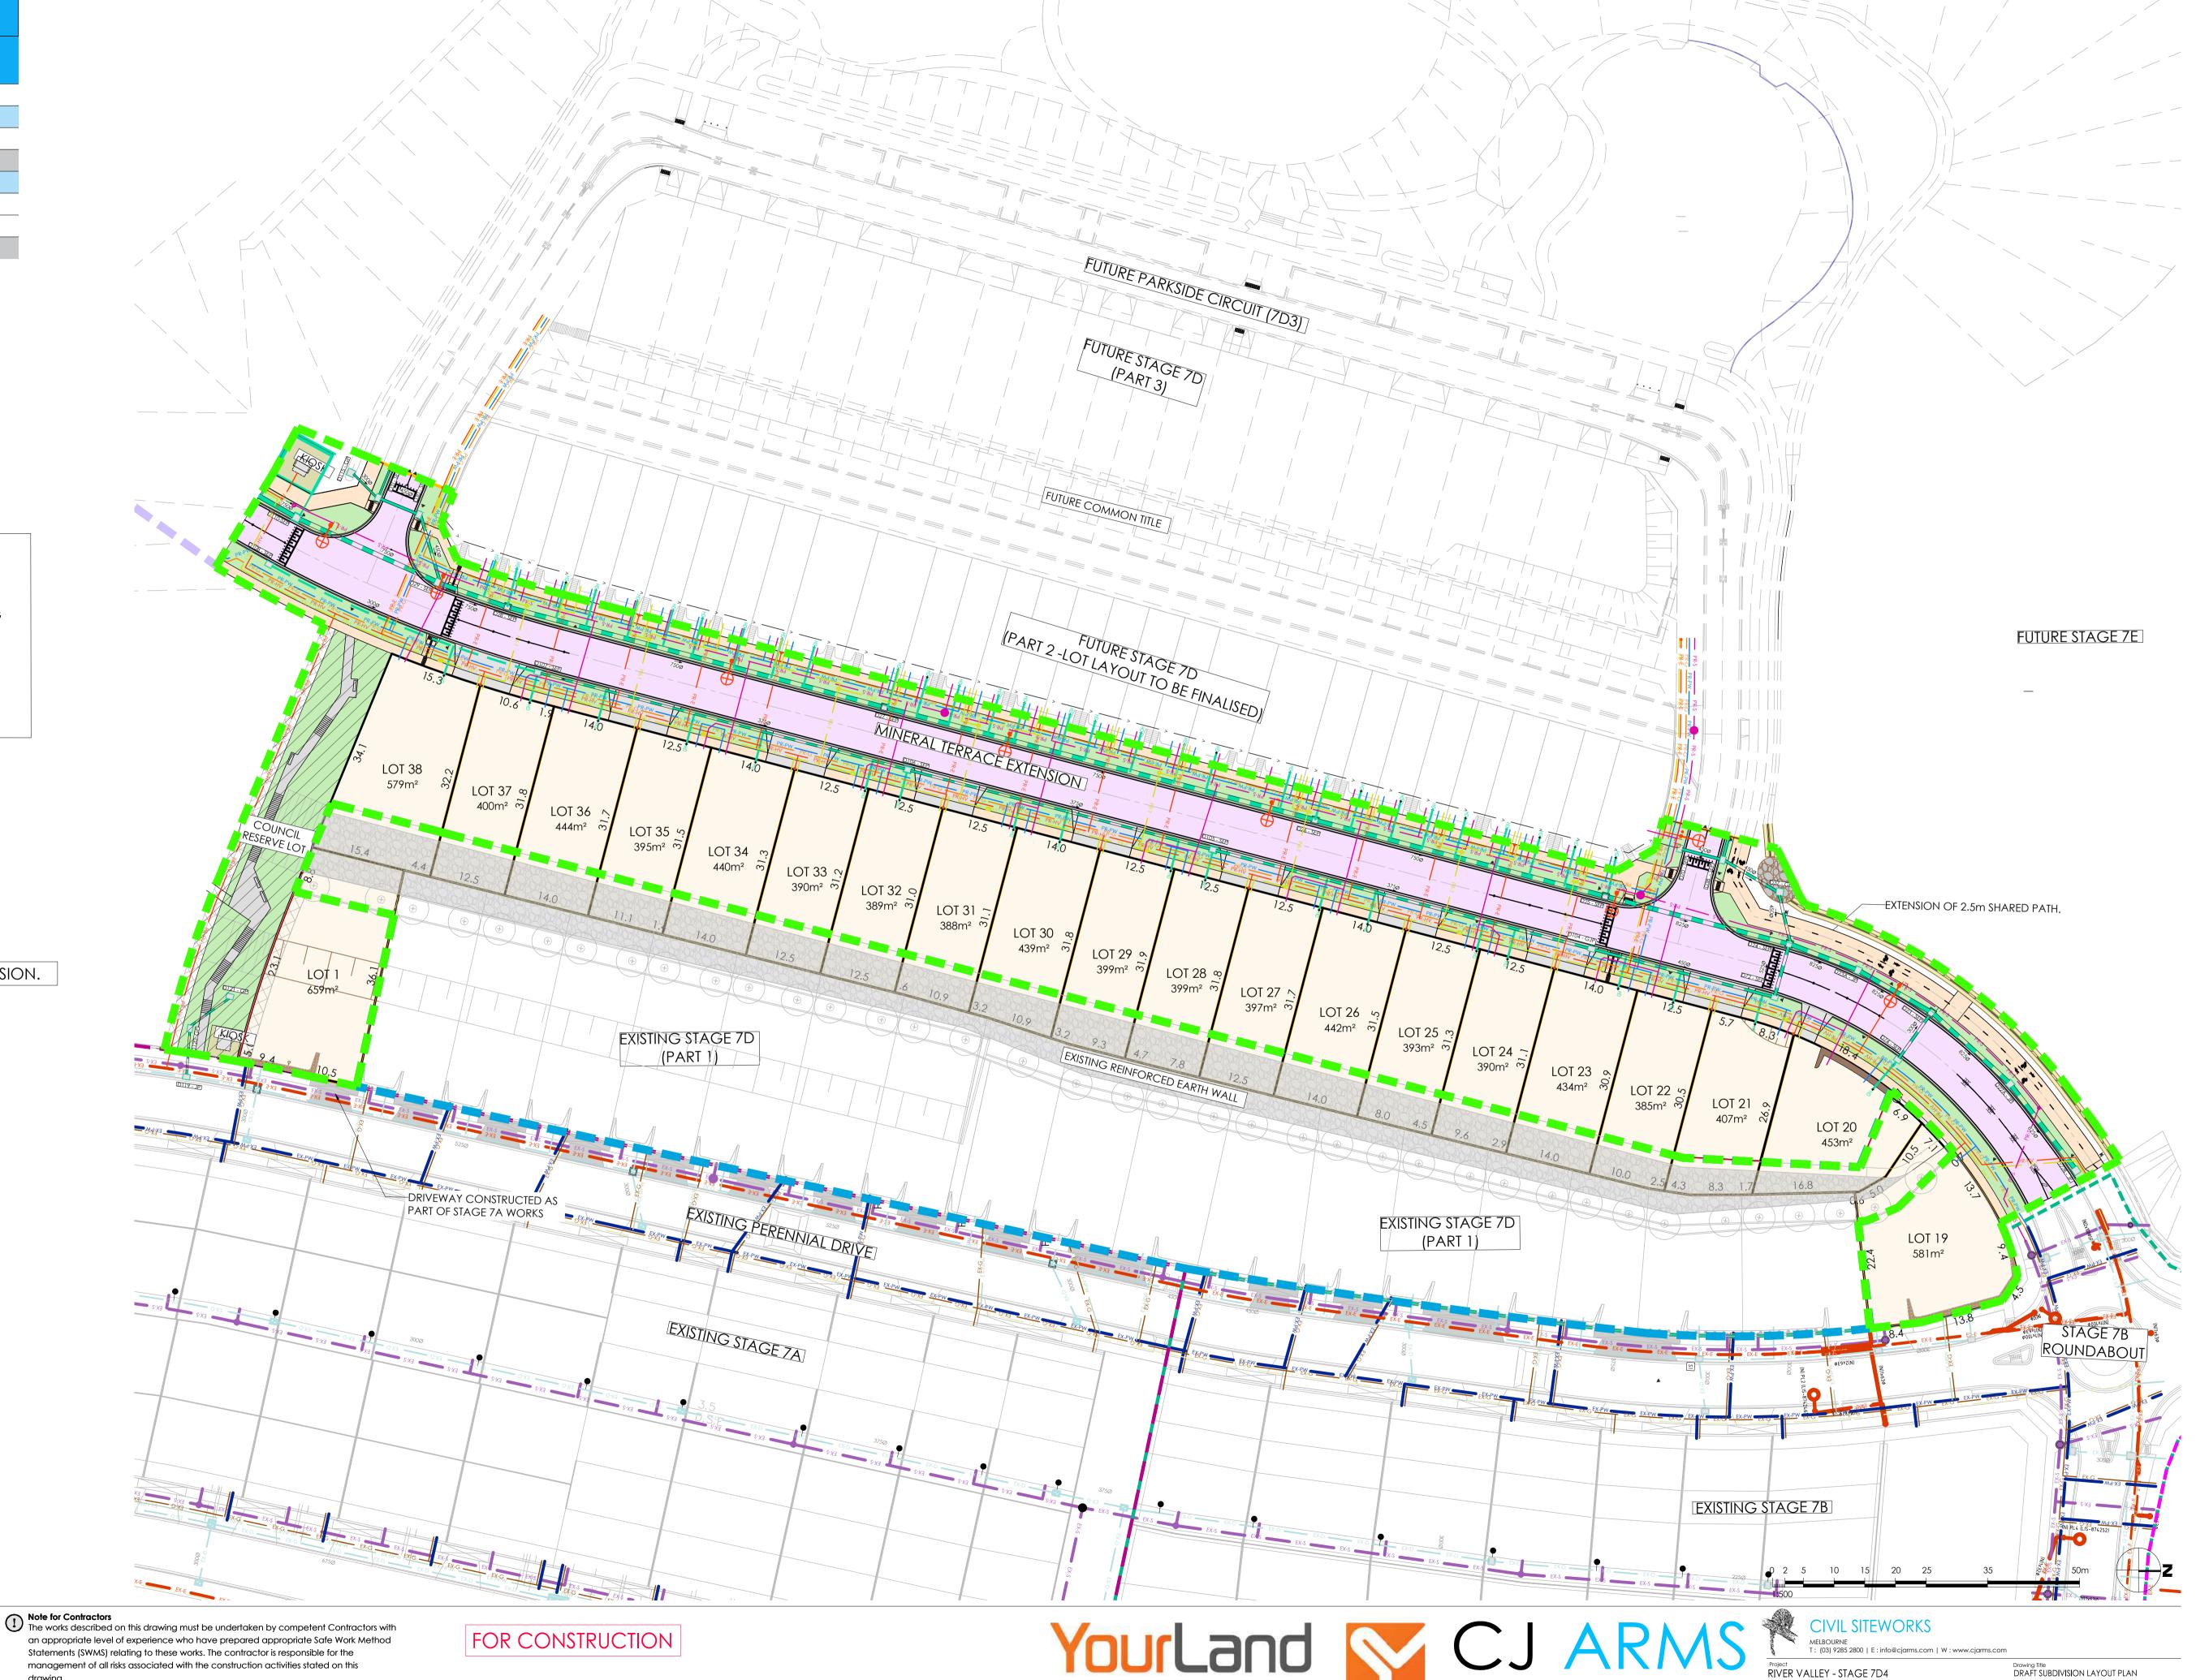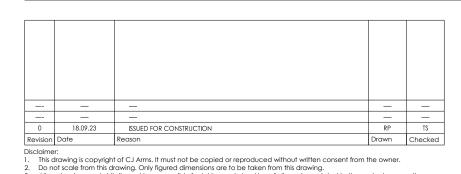7D4 SERVICES ARE AMENDED IN THIS REVISION.





an appropriate level of experience who have prepared appropriate Safe Work Method Statements (SWMS) relating to these works. The contractor is responsible for the management of all risks associated with the construction activities stated on this

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Drawing Title
DRAFT SUBDIVISION LAYOUT PLAN Project RIVER VALLEY - STAGE 7D4 Client YOURLAND FOR CONSTRUCTION Number 1050

DR

С

15006 CJA 7D4 XX

ELECTRICAL AND COMMS SERVICES ADDED TO THE WEST OF MINERAL TERRACE.

CHAINAGES FOR PROPOSED PARKSIDE CIRCUIT

ARE NOW SHOWN ON THE CENTERLINE


7D4 SERVICES ARE AMENDED IN THIS REVISION.

CHAINAGES FOR PROPOSED MINERAL TERRACE ARE NOW SHOWN ON THE CENTERLINE

REFER TO DRAWING C-8000 FOR CONSTRUCTION OF ELECTRICAL PIT ON FOOTPATH DETAIL

DRAWING LEGEND

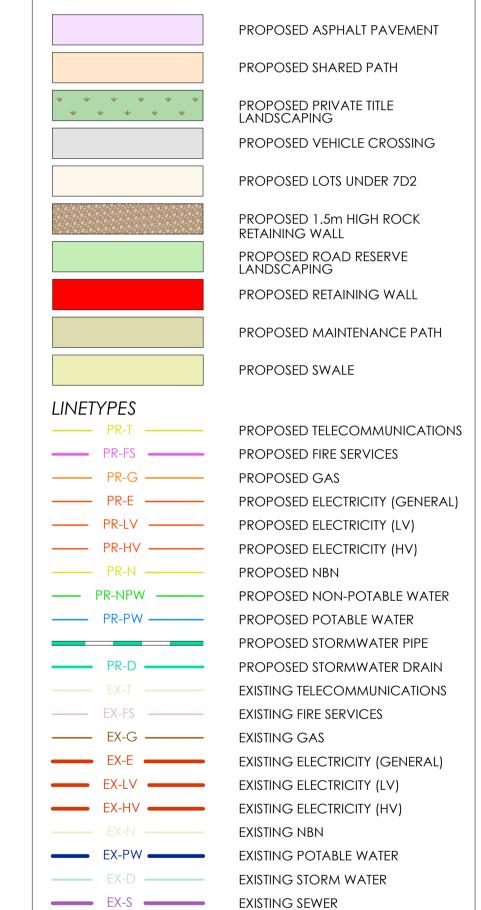HATCHING



EXISTING MINOR CONTOUR (1.0m)

EXISTING MAJOR CONTOUR (5.0m)

EXISTING STORMWATER PIPE

PROPOSED STORM WATER PITS

EXISTING STORMWATER PITS

PROPOSED STREETSCAPE / ROCKWALL PLANTING

PROPOSED LV SERVICE PIT

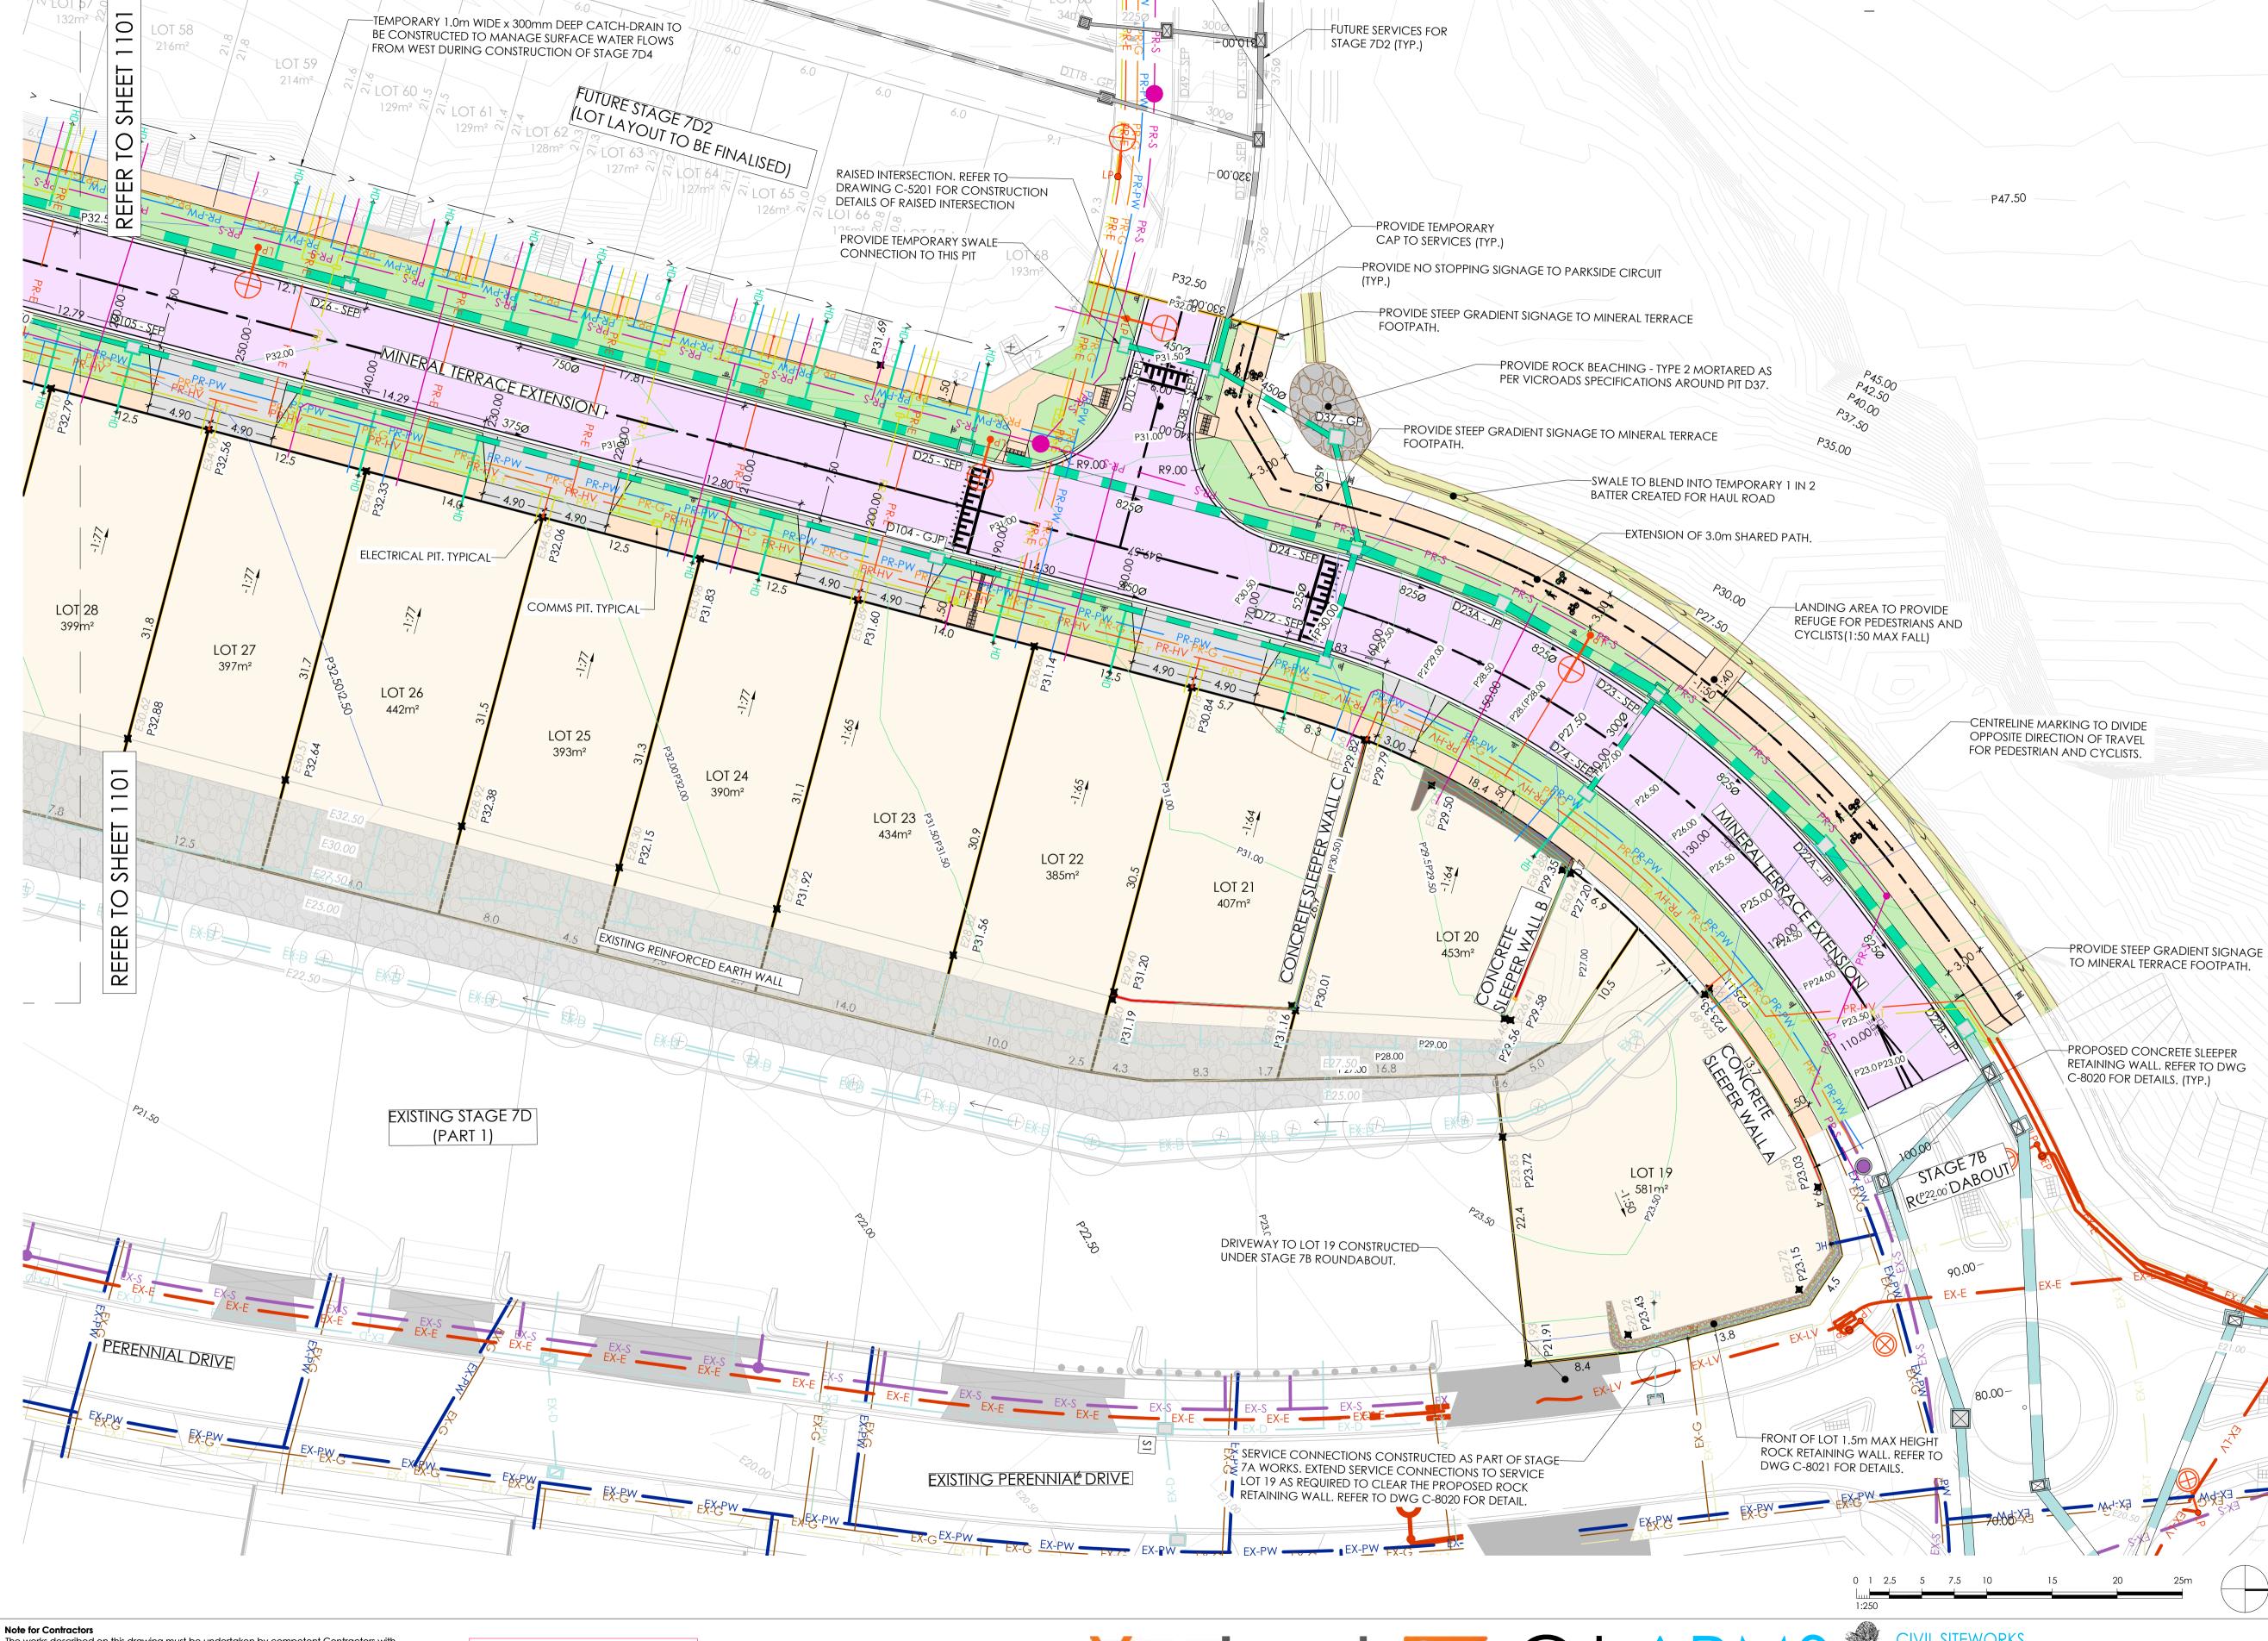
PROPOSED TELECOMMUNICATION PIT

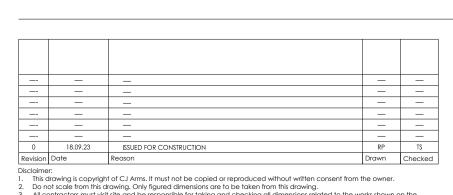
EXISTING STREETSCAPE

PROPOSED LEVEL

EXISTING LEVEL

PROPOSED LIGHTPOLE EXISTING LIGHTPOLE





BLOCKS/SYMBOLS

IP.

(%)

P2 P5 P6 \ominus

 \times P0.00

× E0.00

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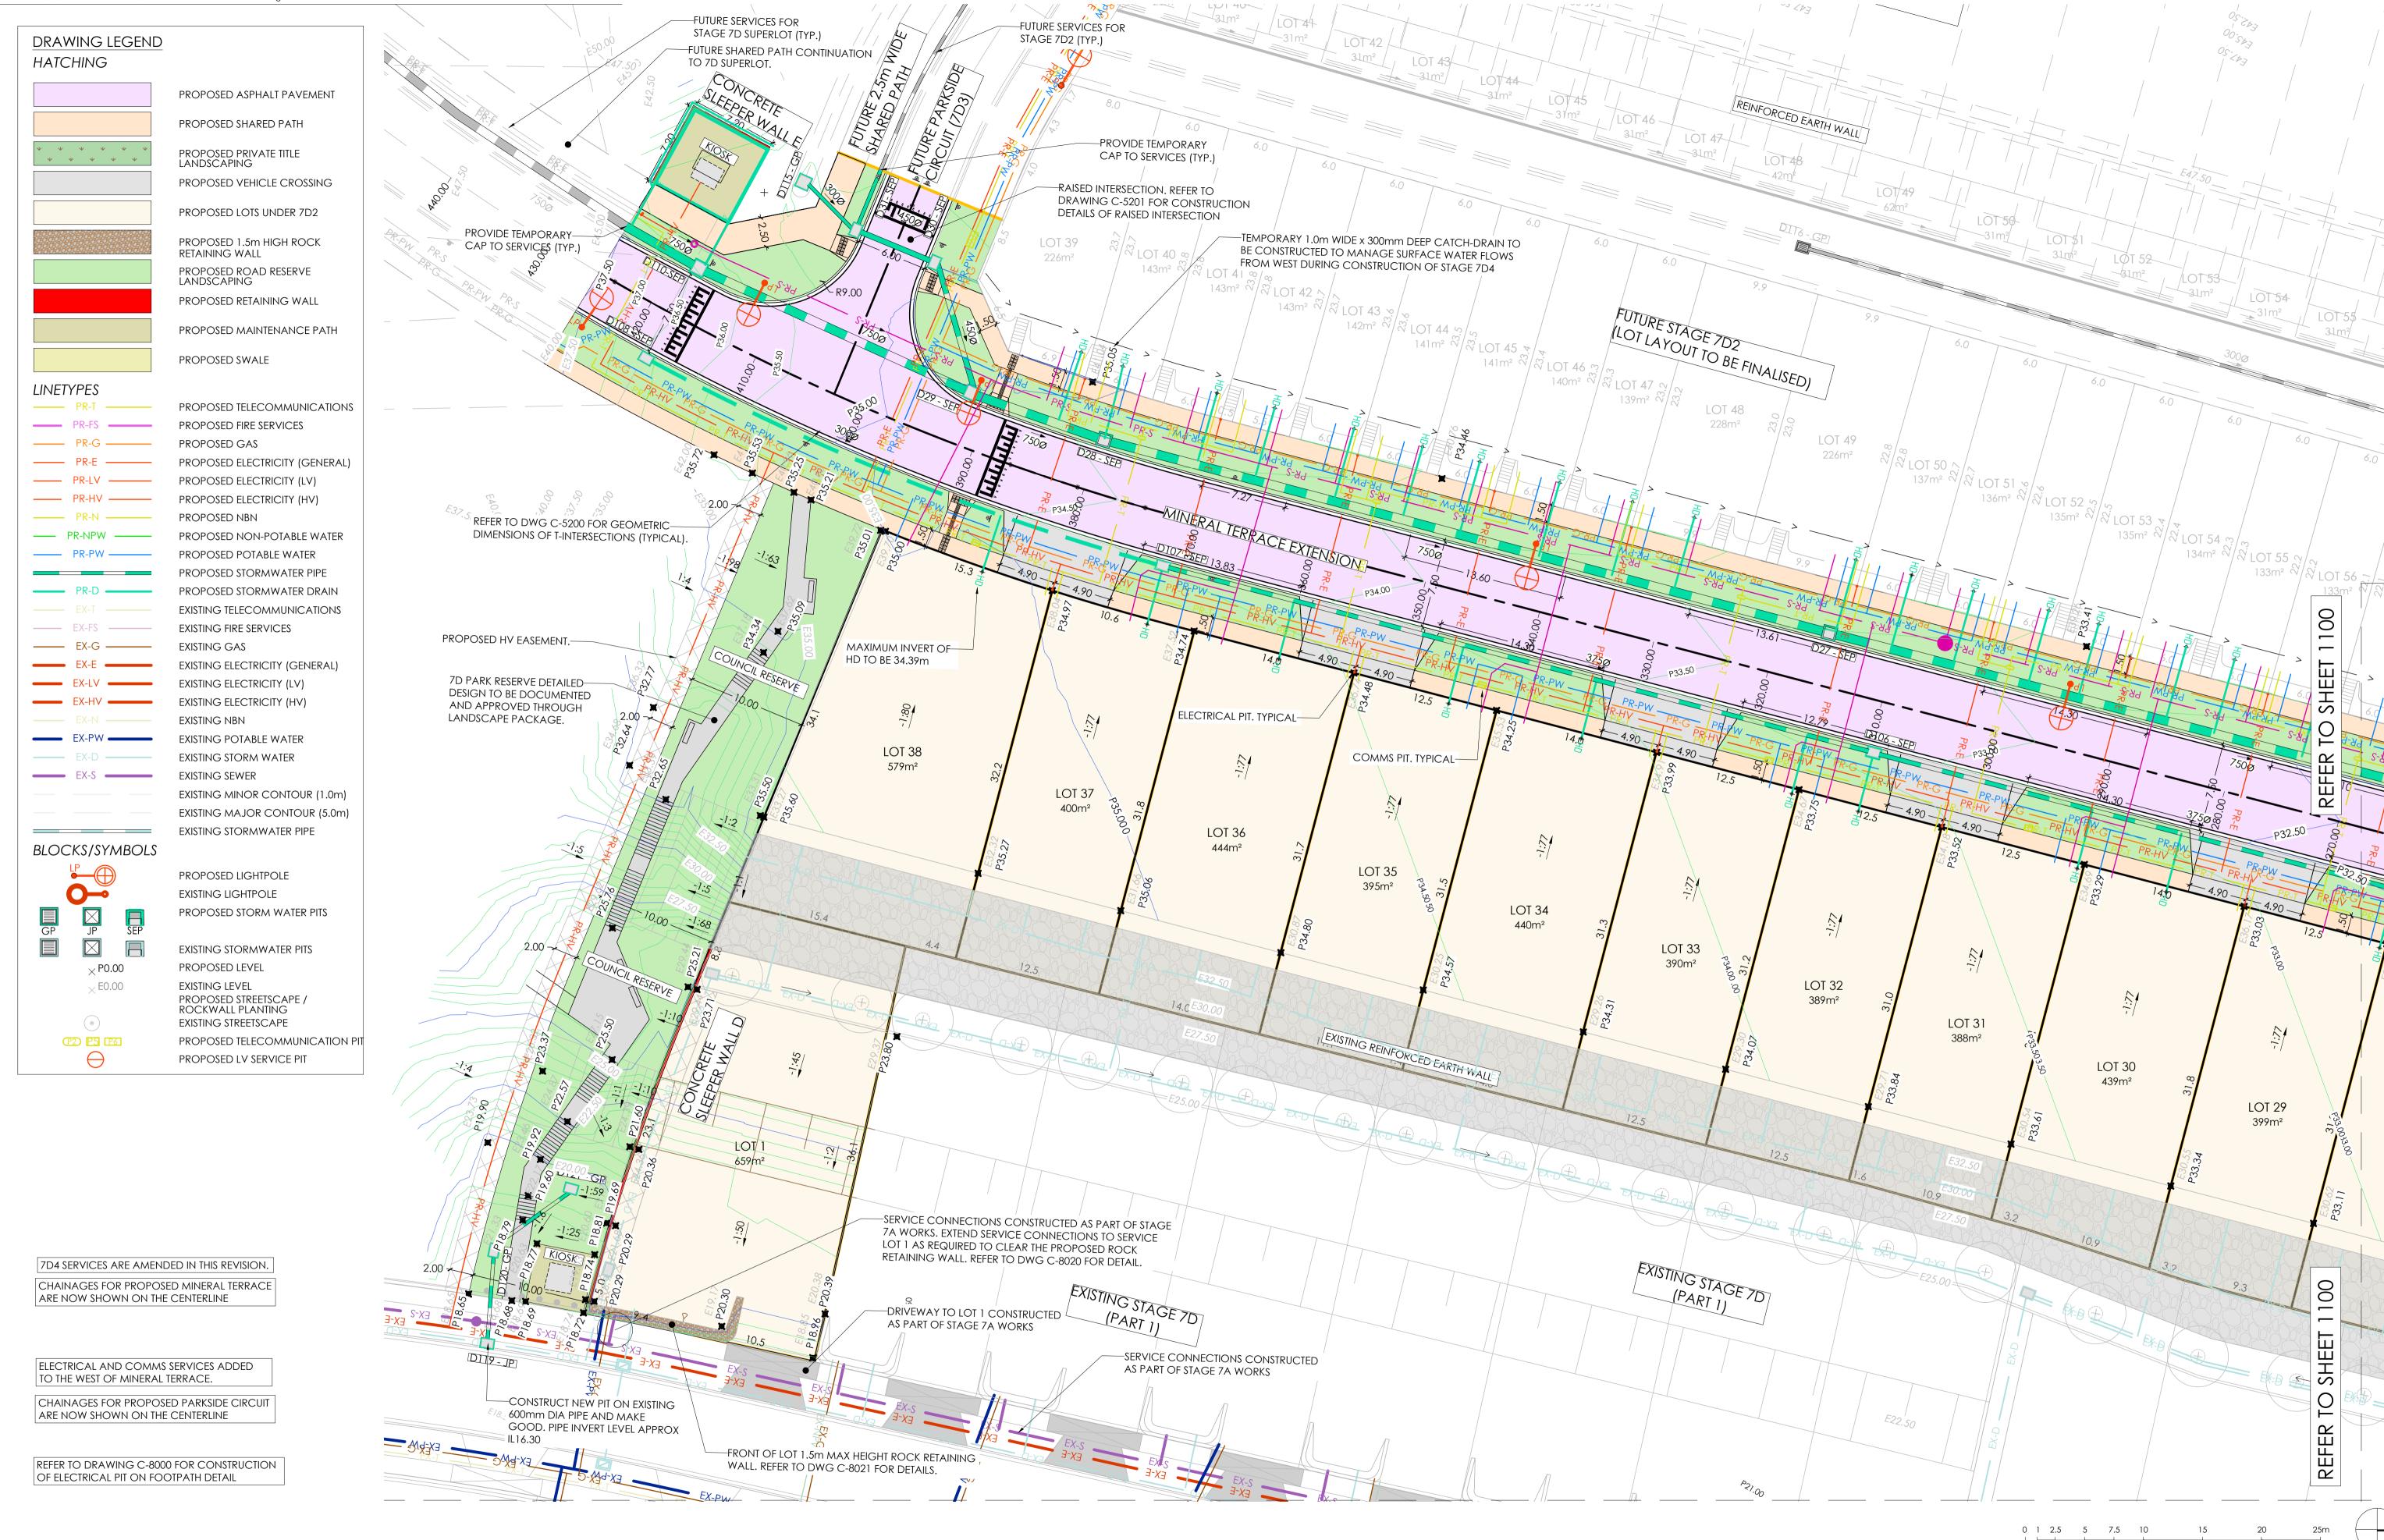
1:250 @ A1

1100

FOR CONSTRUCTION

15006 CJA 7D4

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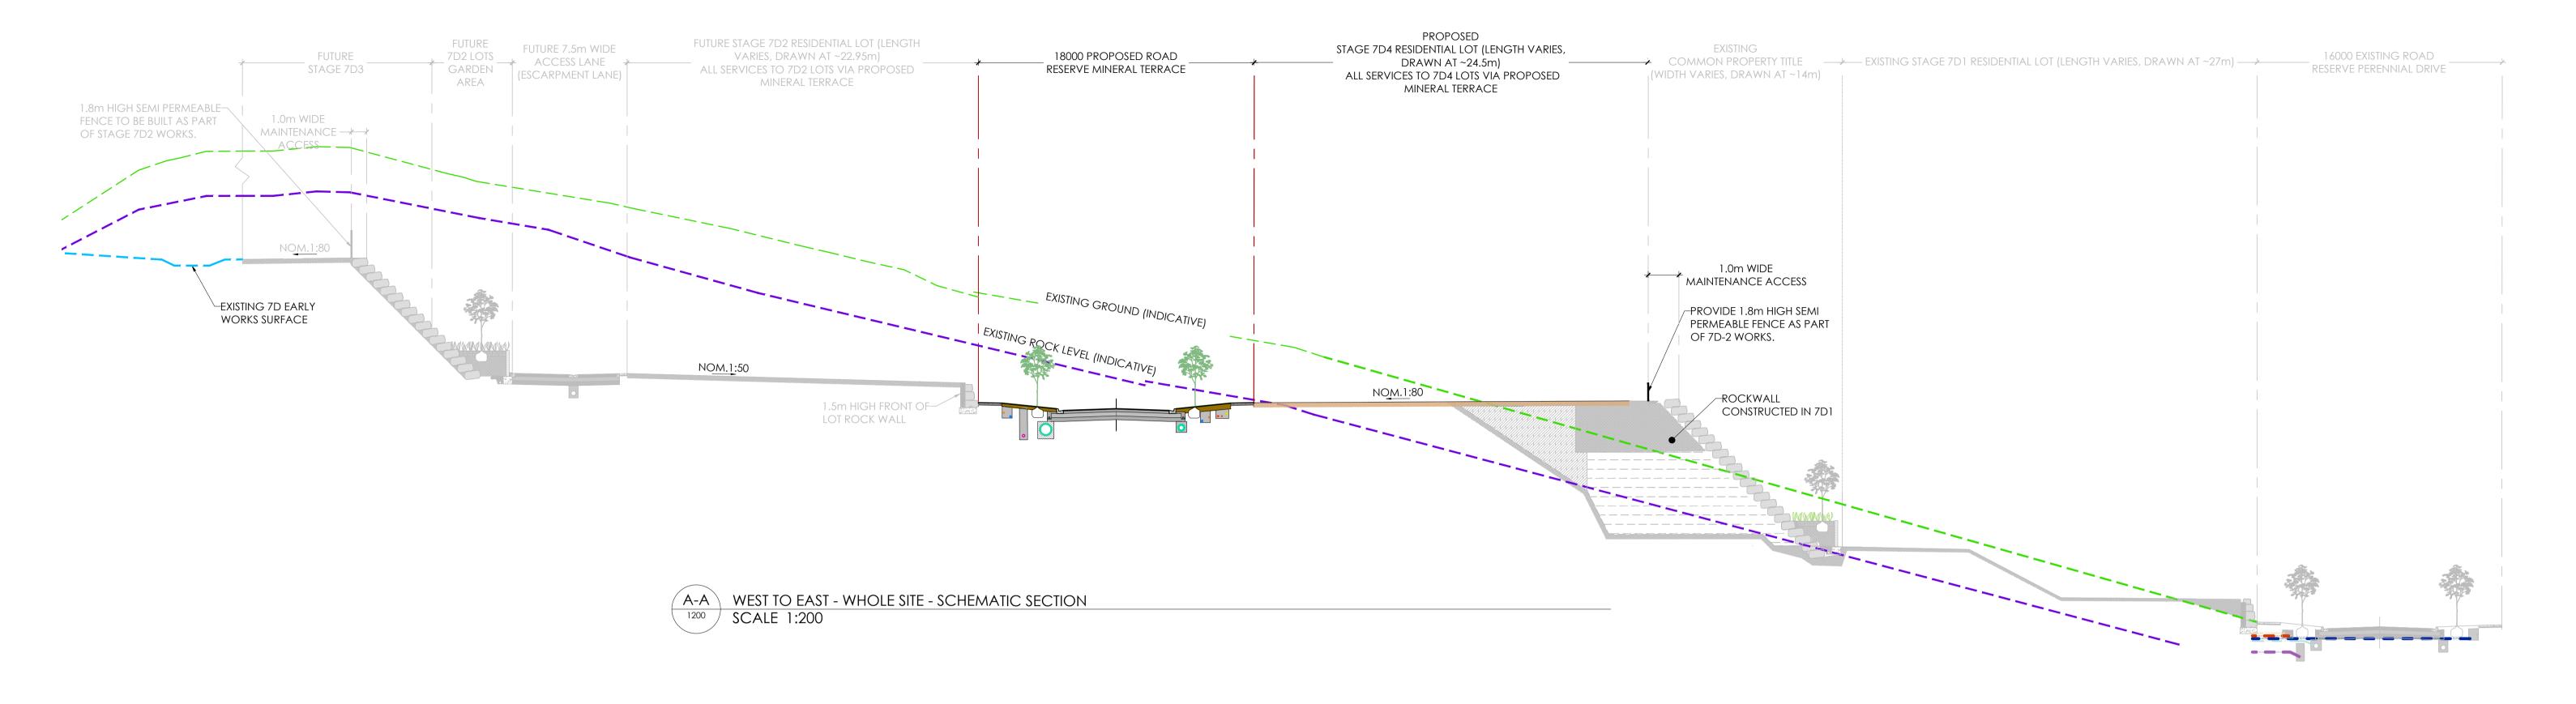
FOR CONSTRUCTION






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CIVIL SITEWORKS T: (03) 9285 2800 | E:info@cjarms.com | W:www.cjarms.com Project RIVER VALLEY - STAGE 7D4 Drawing Title
DETAILED LAYOUT PLAN (SHEET 2 OF 2) YOURLAND FOR CONSTRUCTION 1:250 @ A1 15006 CJA 7D4 DR 1101 XX



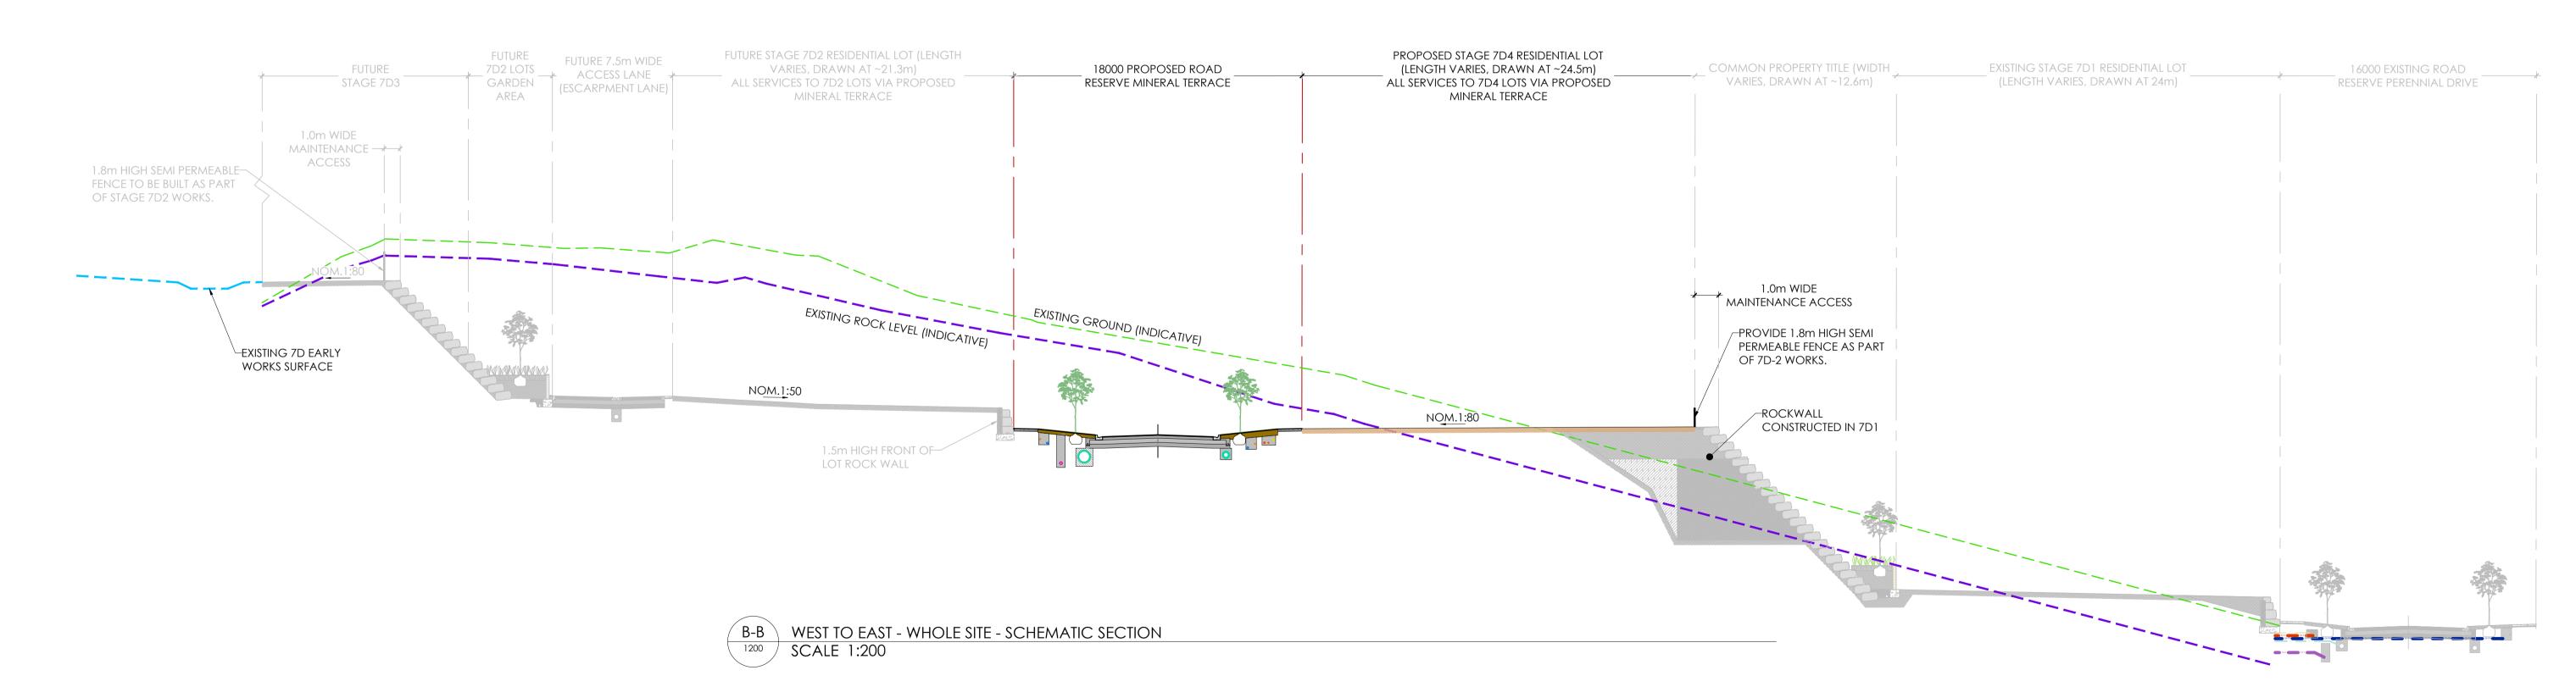

18.09.23 ISSUED FOR CONSTRUCTION Date Reason

Note for Contractors

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Dial before you dig. BEWARE OF UNDERGROUND SERVICES. The location of underground services are approximate only and their exact position should be proven on site. No guarantee is given that existing services are shown.

FOR CONSTRUCTION







15		CIVIL SITEWORKS MELBOURNE T: (03) 9285 2800 E: info@cjarms.com				
V 10	Project RIVER V	ALLEY - STAGE 7D4		Drawing Title TYPICAL SEC	CTION-WHOLE SI	TE
	Client YOURLA					
	Purpose of Issi	ue	Drawn By	Checked By	Drawn Scale	С
	FOR CO	INSTRUCTION	RP	VR	1:200 @ A1	


15006 CJA 7D4

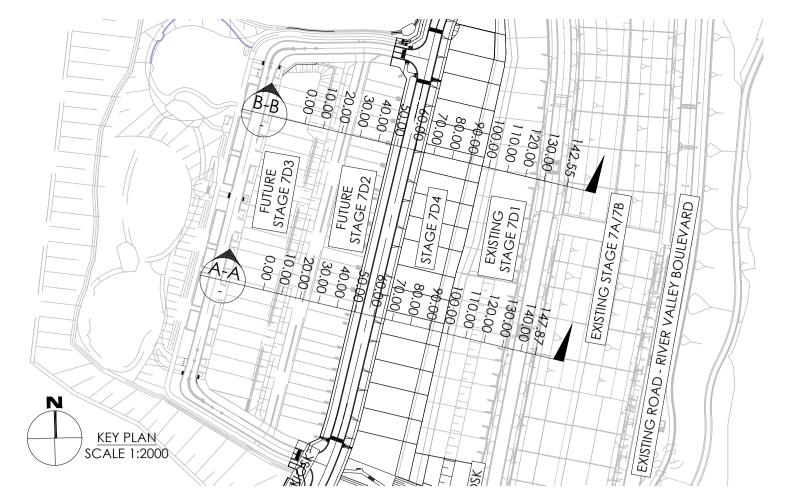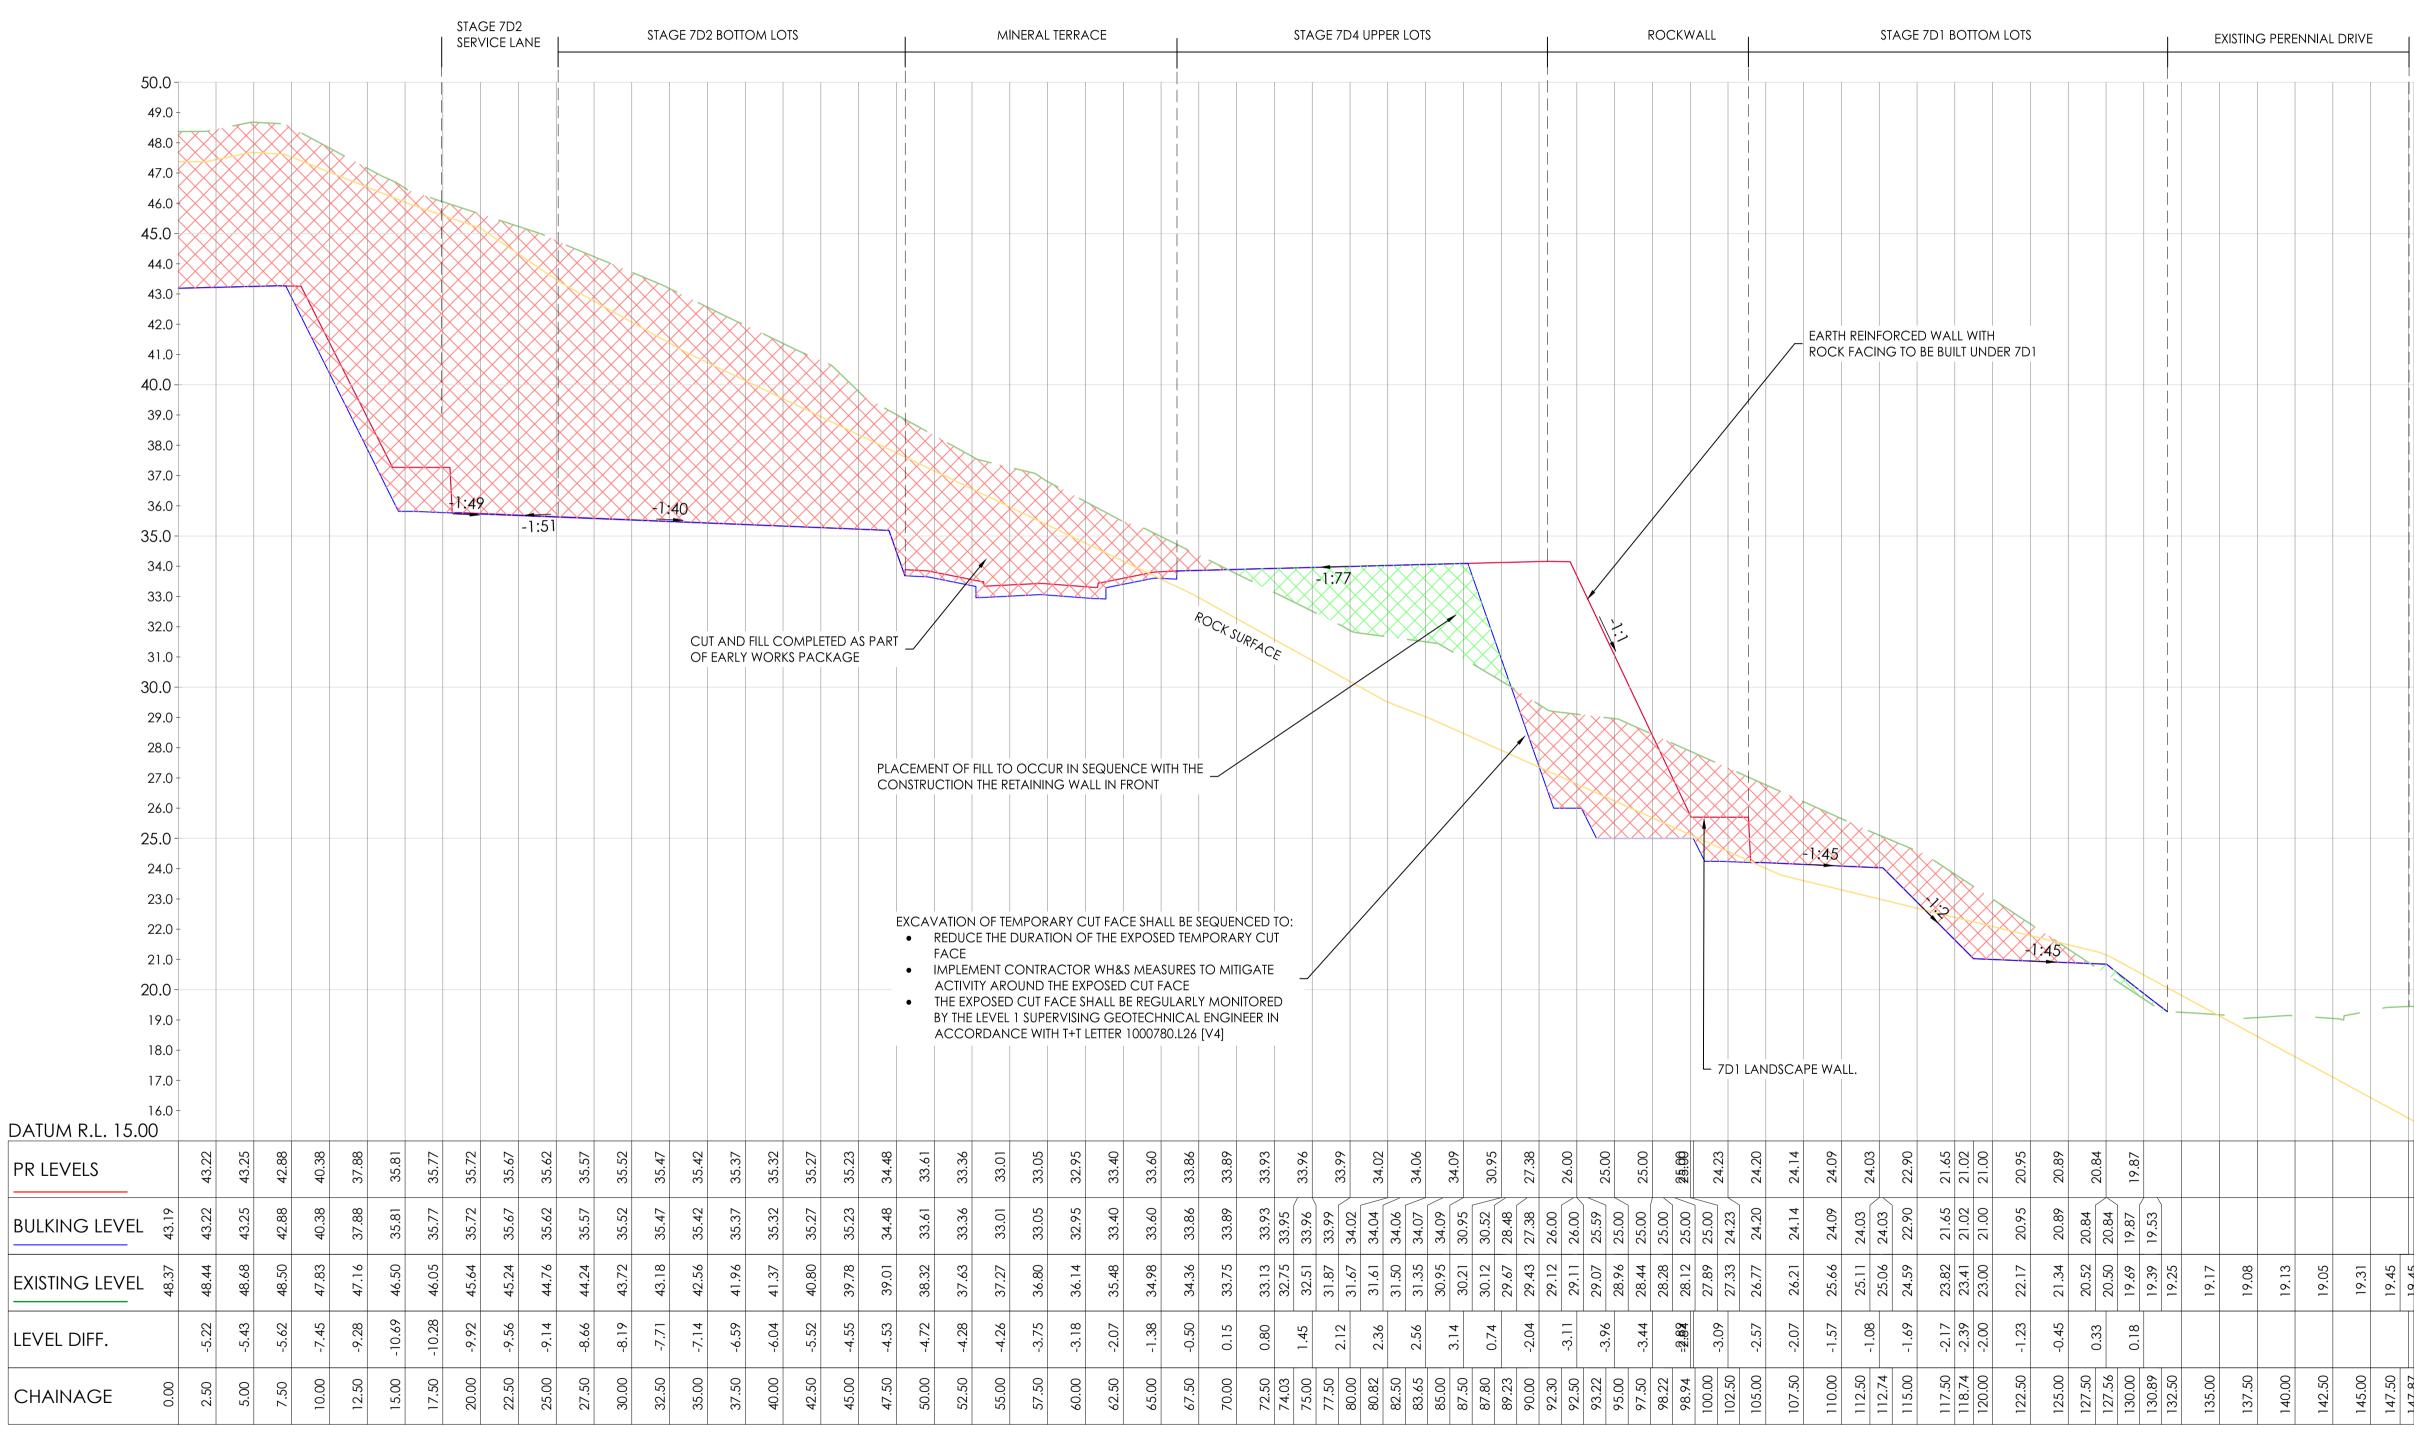DR





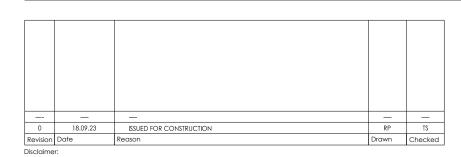A-A - LONG SECTION SCALES: HORIZONAL 1:250 VERTICAL 1:125 (2x)



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Statements (SWMS) relating to these works. The contractor is responsible for the management of all risks associated with the construction activities stated on this


Note for Contractors

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an appropriate level of experience who have prepared appropriate Safe Work Method

Dial before you dig. BEWARE OF UNDERGROUND SERVICES. The location of underground

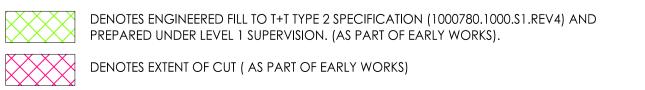FOR CONSTRUCTION











XX

DR

FOR CONSTRUCTION


15006 CJA 7D4


0 1 2.5 5 7.5 10 15

AS SHOWN @ A1 18.09.23


2001

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B-B - LONG SECTION SCALES: HORIZONAL 1:250 VERTICAL 1:125 (2x)

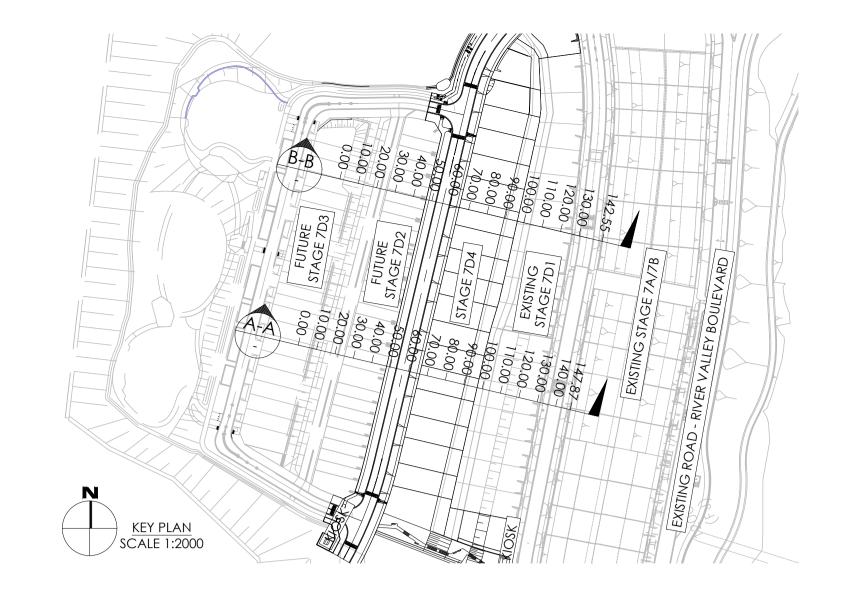

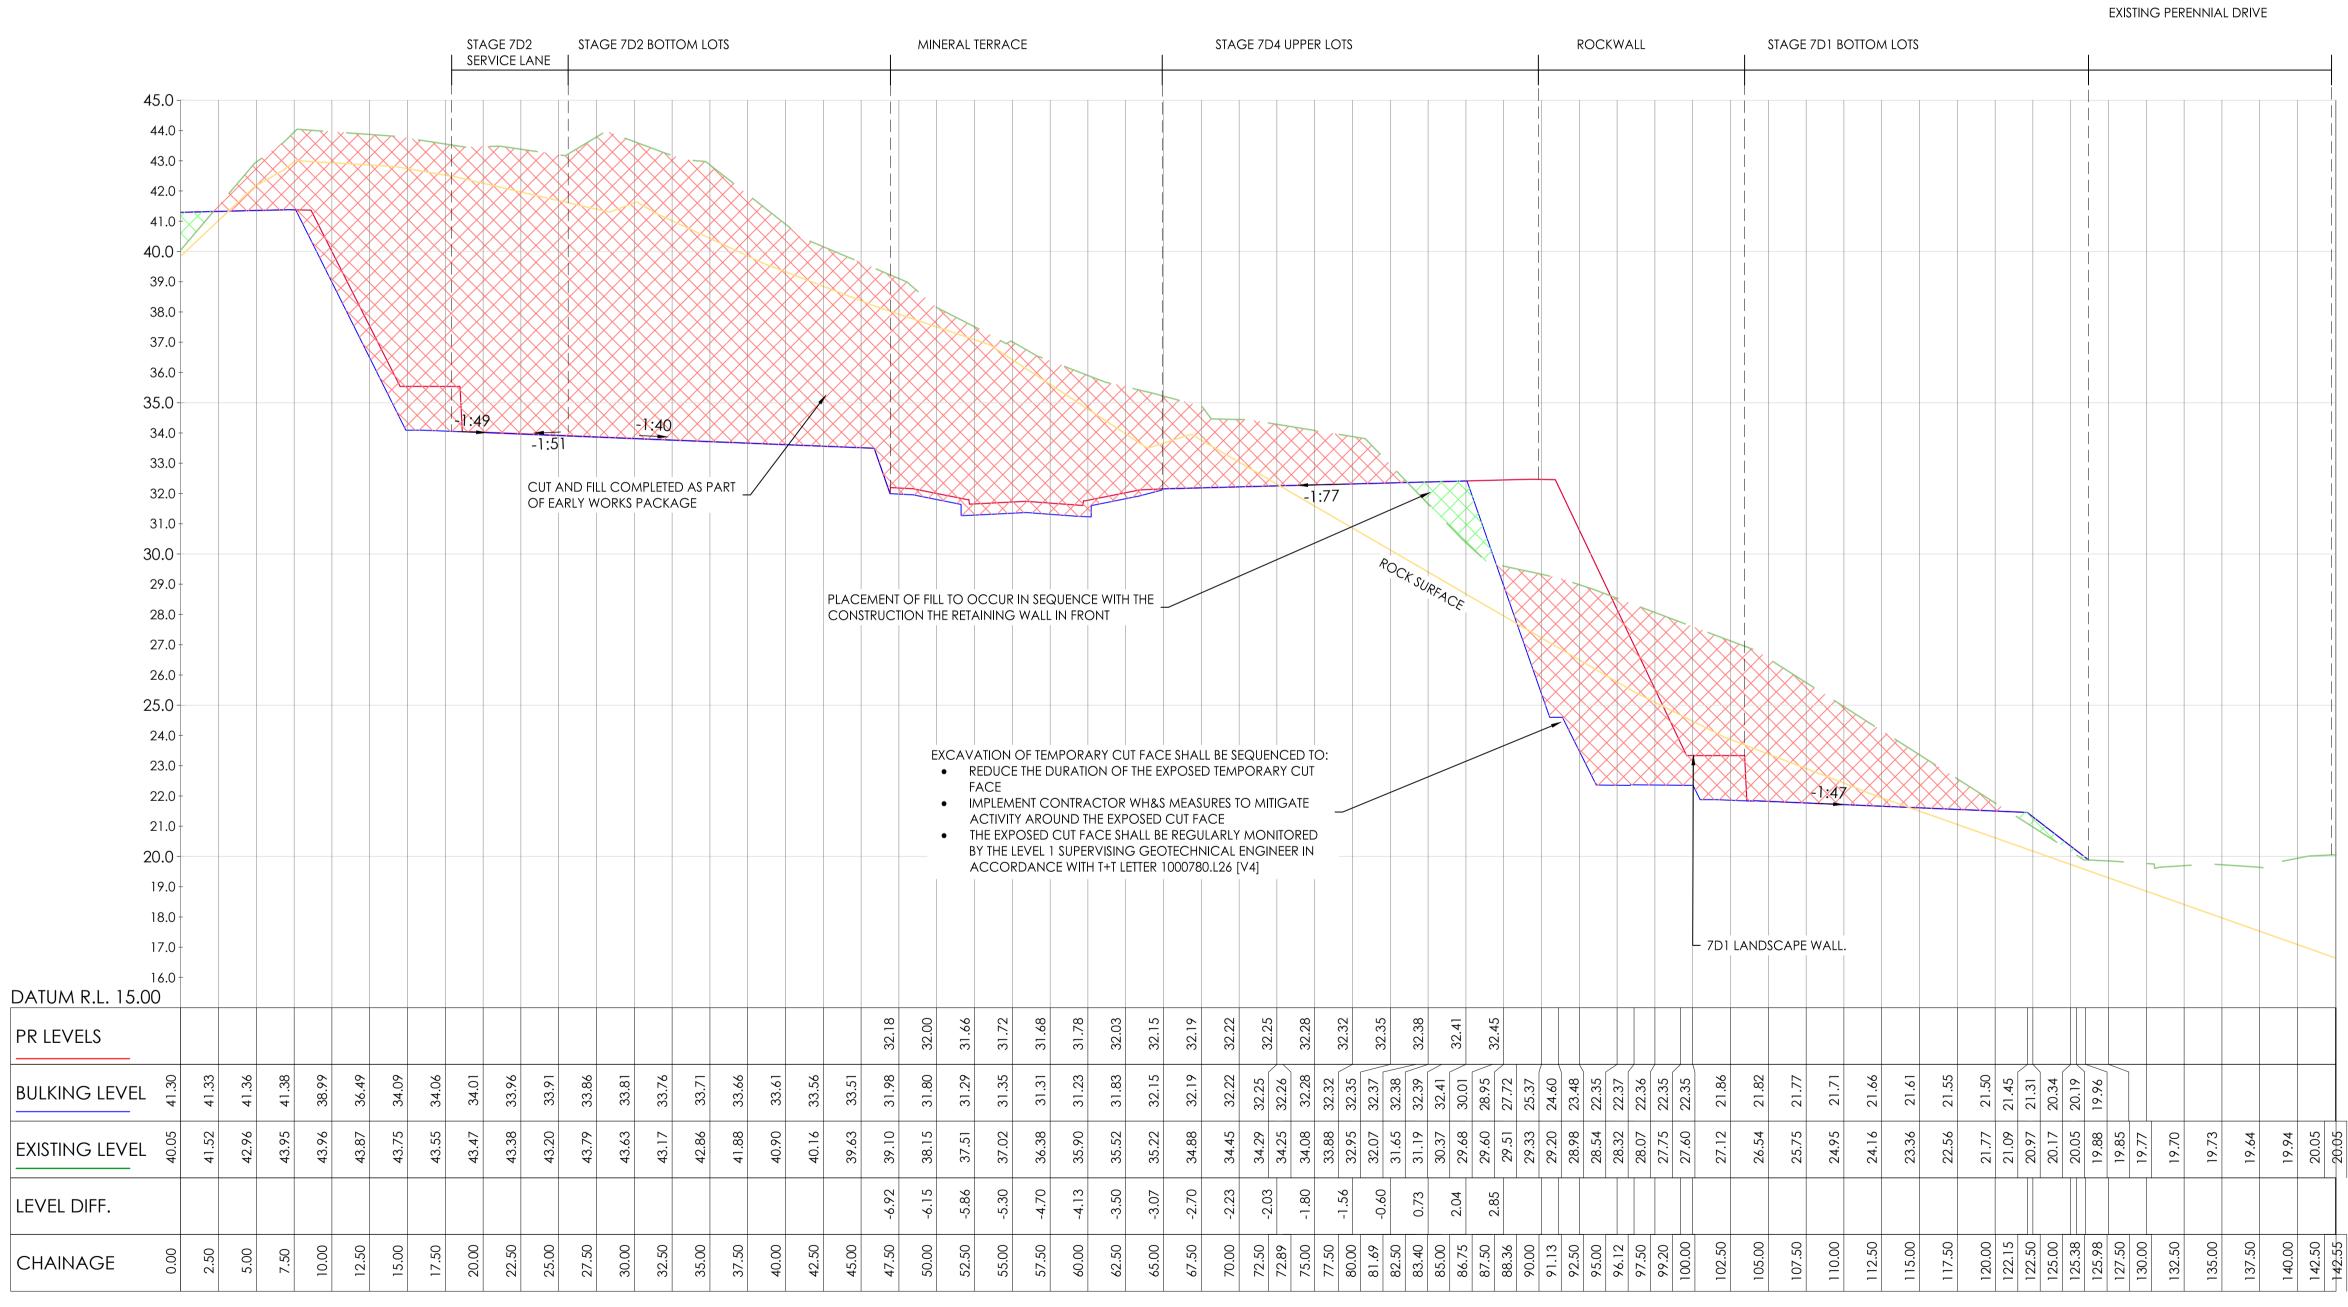management of all risks associated with the construction activities stated on this drawing. This drawing should not be issued in part and must be read in conjunction with all appropriate specifications, notes pages, details and authority drawings as appropriate.

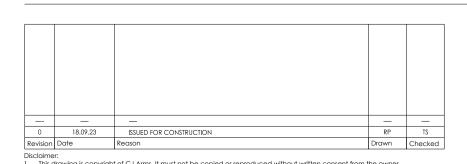services are approximate only and their exact position should be proven on site. No

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Statements (SWMS) relating to these works. The contractor is responsible for the

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an appropriate level of experience who have prepared appropriate Safe Work Method

Dial before you dig. BEWARE OF UNDERGROUND SERVICES. The location of underground

DENOTES ENGINEERED FILL TO T+T TYPE 2 SPECIFICATION (1000780.1000.S1.REV4) AND PREPARED UNDER LEVEL 1 SUPERVISION. (AS PART OF EARLY WORKS).

DENOTES EXTENT OF CUT (AS PART OF EARLY WORKS)










0 1 2.5 5 7.5 10 15


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FOR CONSTRUCTION AS SHOWN @ A1 18.09.23 15006 CJA 7D4 XX DR 2002

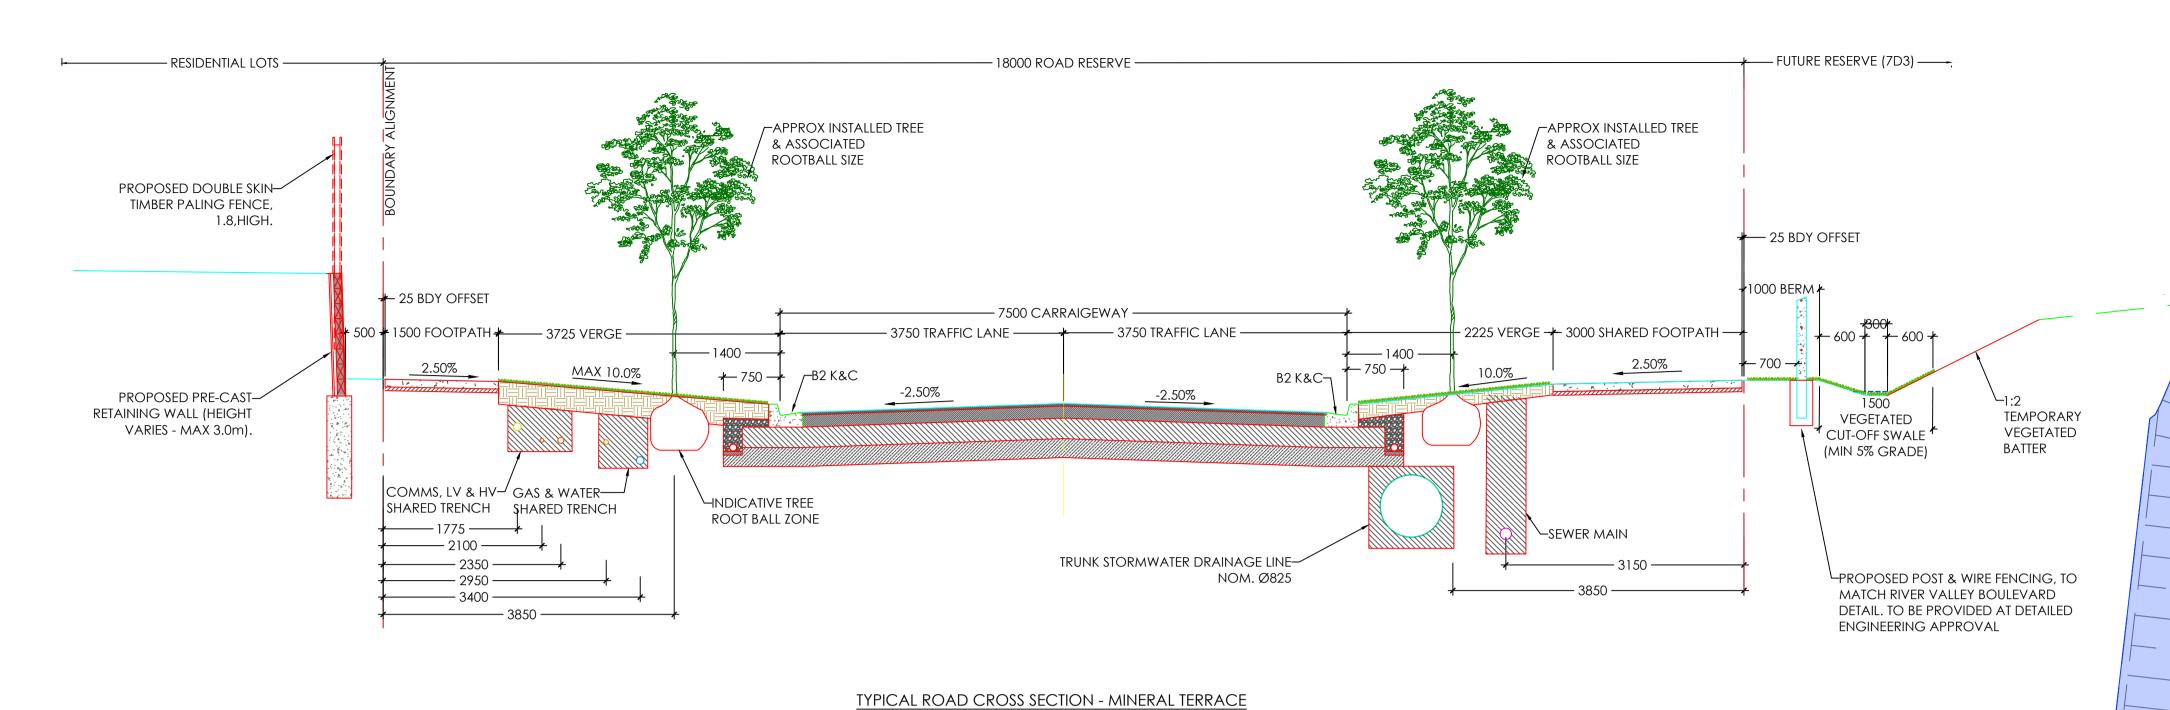

CH 110-170



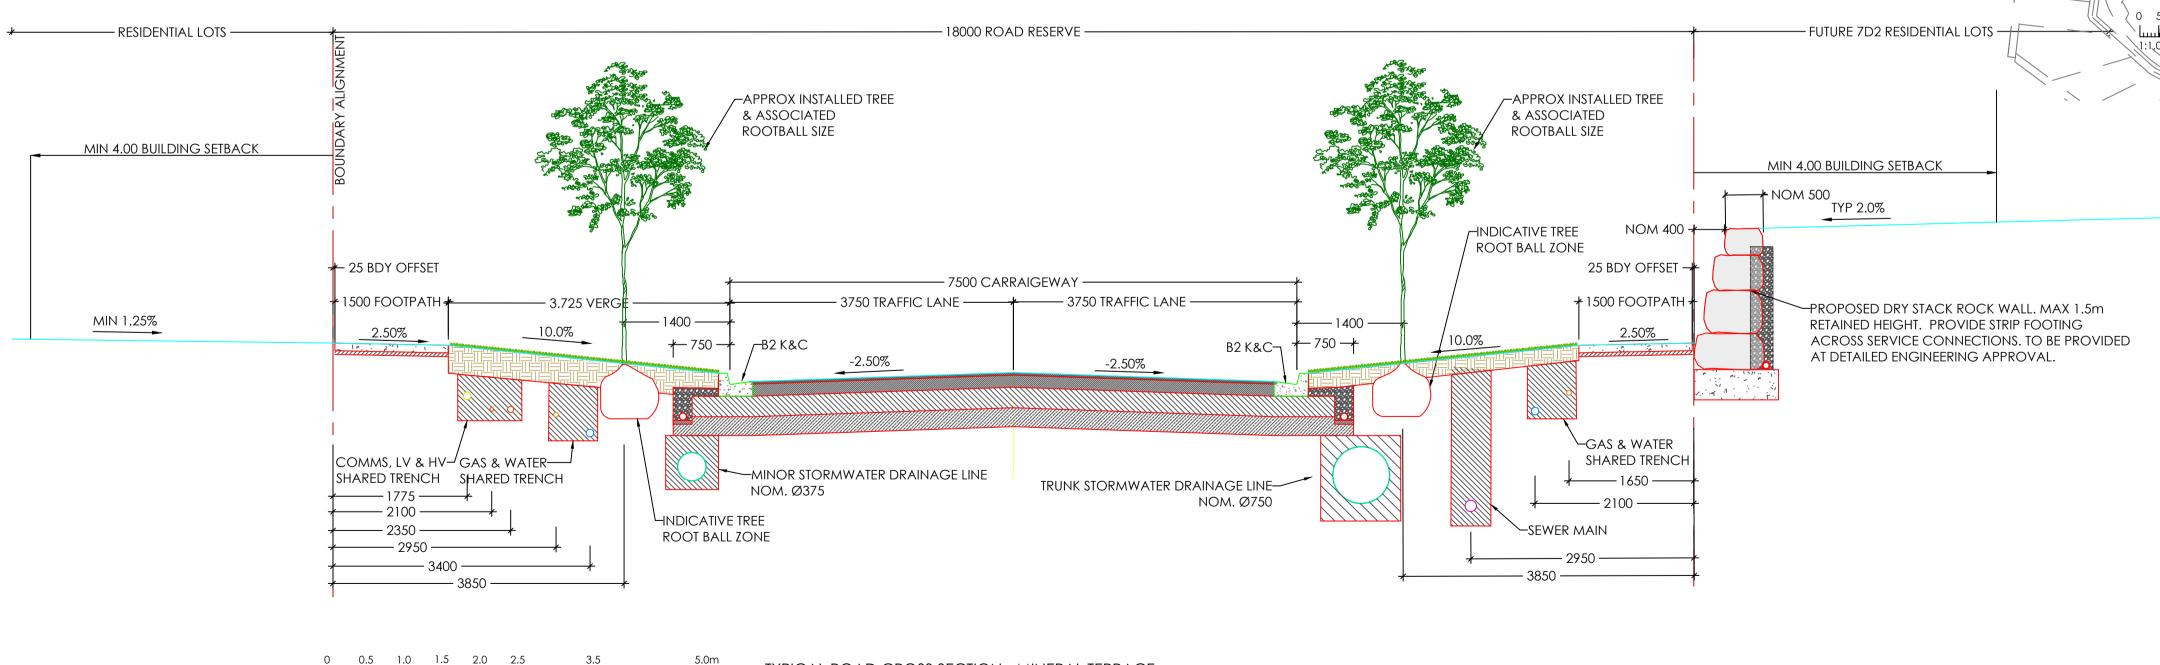

TYPICAL ROAD CROSS SECTION - MINERAL TERRACE CH 190 - 390

(ALL CROSS ROAD UTILITY INFRASTRUCTURE OMITTED FOR CLARITY)

FOR CONSTRUCTION

 TABLE OF SERVICE OFFSETS

 Street
 Gas
 Water
 Sewer
 Elec
 Comms
 BOK

 MINERAL TERRACE - CH 110 - 170
 2.95 S
 3.40 S
 3.15 N
 2.10(LV) / 2.35(HV) S
 1.775 S
 5.10

 MINERAL TERRACE - CH 190 - 390
 2.95 E 1.65 W 2.10 W
 2.95 W 2.10(LV) / 2.35(HV) E
 1.775 E
 5.10

NOTES:

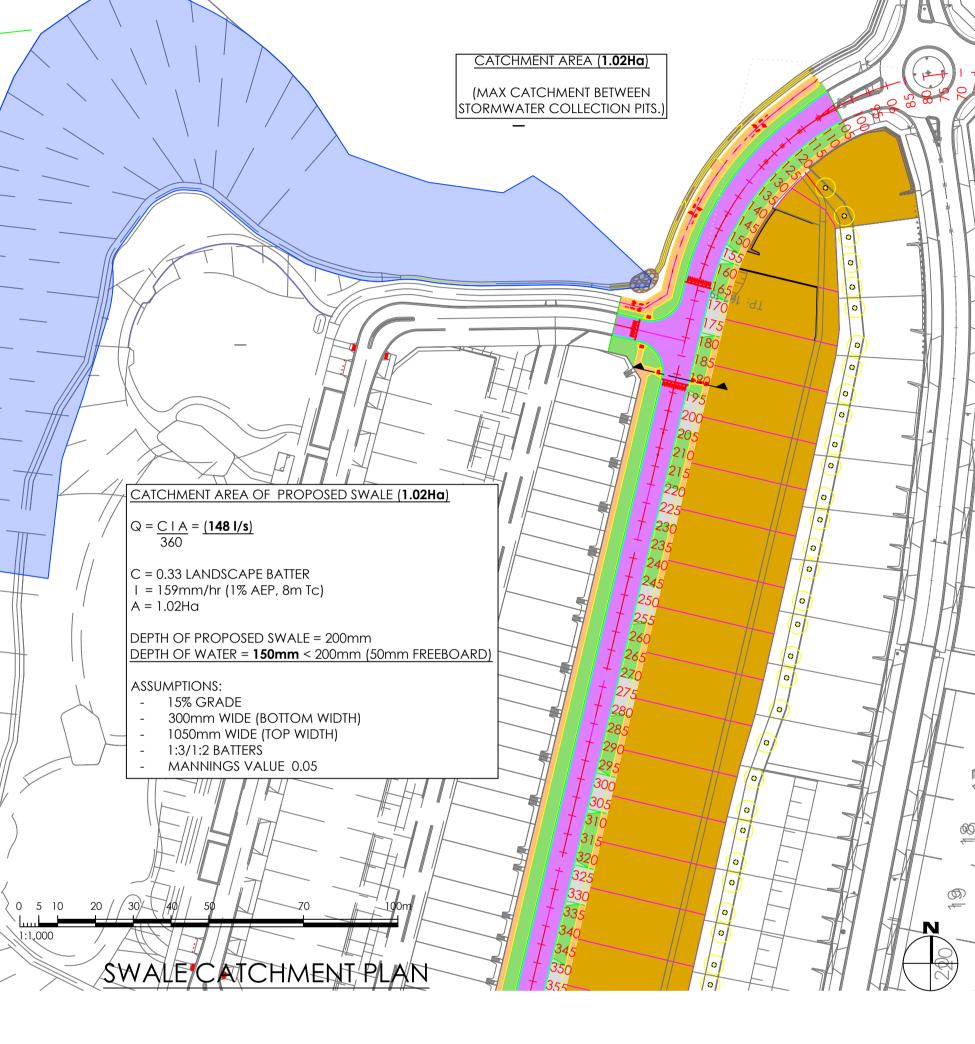
1. MINIMUM DEPTH OF COVER TO ALL UTILITY SERVICES WITH THE EXCEPTION OF TELECOMMUNICATIONS SERVICES TO BE 600mm. TELECOMMUNICATIONS SERVICES ARE

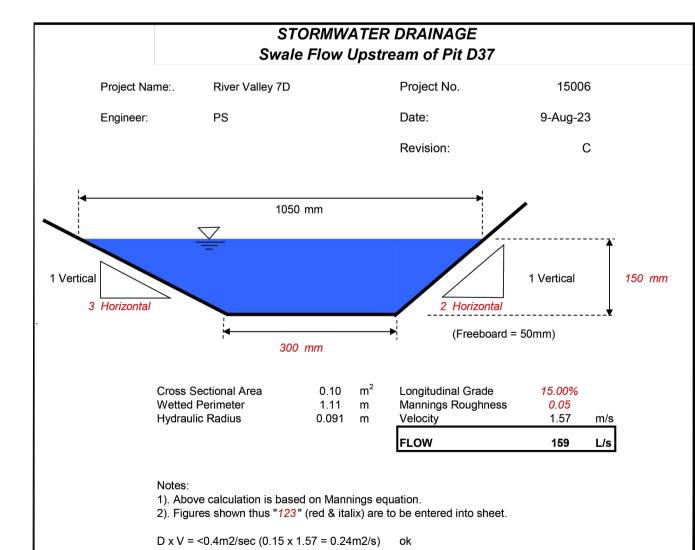
TO HAVE A MINIMUM DEPTH OF COVER OF 450mm.

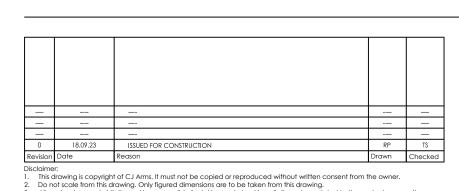
2. REFER TO ABOVE TABLE FOR SERVICES OFFSETS.

3. LOCATIONS OF STREET TREES ARE SHOWN INDICATIVELY ONLY.

4. REFER TO LANDSCAPE PLANS FOR FURTHER DETAILS ON PLANTING AND TREE TREATMENTS.







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CJ ARMS

CIVIL SITEWORKS

MELBOURNE
T: (03) 9285 2800 | E: info@cjarms.com | W: www.cjar

15006 CJA 7D4

MELBOURNE
T: (03) 9285 2800 | E:info@cjarms.com | W:www.cjarms.com

Project
RIVER VALLEY - STAGE 7D4

Client
YOURLAND
Purpose of Issue

Drawn By

Checked By

Drawn Scale

Date of First Issue
FOR CONSTRUCTION

RP

VR

AS SHOWN @ A1 18.09.23

DR

2100

XX

	TABLE	OF SERVICE	OFFSETS			
Street	Gas	Water	Sewer	Elec	Comms	BOK
PARKSIDE CIRCUIT (EAST & WEST LINKS-NORTH JUNCTION)	0.600 S	1.050 S	3.150 S	2.100 S	1.800 S	4.350

1. MINIMUM DEPTH OF COVER TO ALL UTILITY SERVICES WITH THE EXCEPTION OF TELECOMMUNICATIONS SERVICES TO BE 600mm.

3. LOCATIONS OF STREET TREES ARE SHOWN INDICATIVELY ONLY.

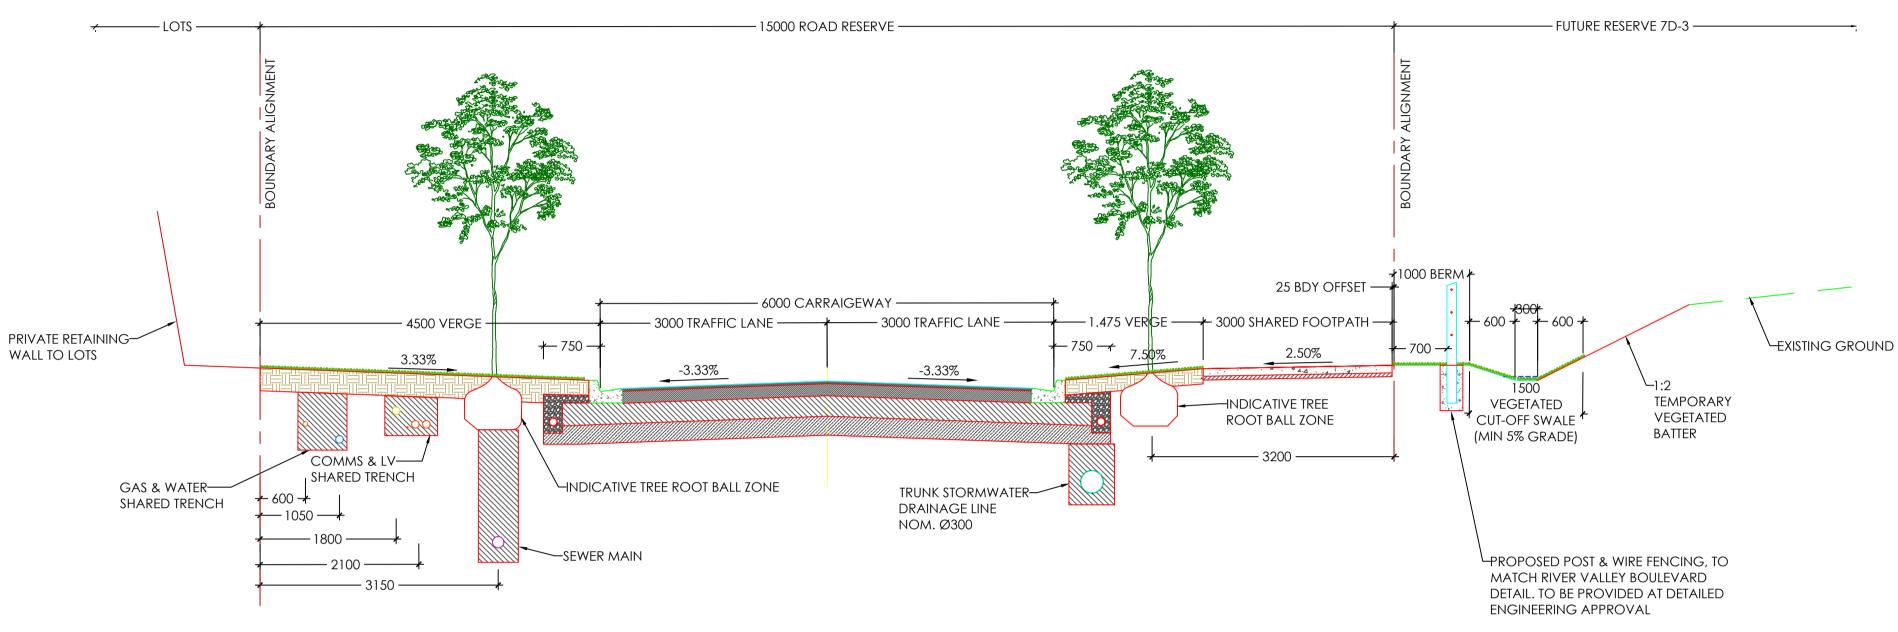
2. REFER TO ABOVE TABLE FOR SERVICES OFFSETS.

COVER OF 450mm.

TREE TREATMENTS.

TELECOMMUNICATIONS SERVICES ARE TO HAVE A MINIMUM DEPTH OF

4. REFER TO LANDSCAPE PLANS FOR FURTHER DETAILS ON PLANTING AND



TYPICAL ROAD CROSS SECTIONS - PARKSIDE CIRCUIT (EAST & WEST LINKS - NORTH JUNCTION)



1. MINIMUM DEPTH OF COVER TO ALL UTILITY SERVICES WITH THE EXCEPTION OF TELECOMMUNICATIONS SERVICES TO BE 600mm. TELECOMMUNICATIONS SERVICES ARE TO HAVE A MINIMUM DEPTH OF COVER OF 450mm.

- 2. REFER TO ABOVE TABLE FOR SERVICES OFFSETS.
- 3. LOCATIONS OF STREET TREES ARE SHOWN INDICATIVELY ONLY. 4. REFER TO LANDSCAPE PLANS FOR FURTHER DETAILS ON PLANTING AND

0 0.5 1.0 1.5 2.0 2.5

DR C

15006 CJA 7D4 XX

18.09.23

2101

TREE TREATMENTS.

:	150	000 ROAD RESERVE ———————————————————————————————————	FUTURE 7D3 LOTS ———
# 600 + 600		00 CARRAIGEWAY — 4500 VERGE	FUTURE PRE-CAST RETAINING WALL. SINGLE TIER HEIGHT LIMITED TO 1.5m
PROPOSED POST & WIRE FENCING, TO-MATCH RIVER VALLEY BOULEVARD DETAIL. TO BE PROVIDED AT DETAILED	INDICATIVE TREE ROOT BALL ZONE 3200 TRUNK STORMWATER DRAINAGE LINE NOM. Ø300		COMMS & LV SHARED TRENCH

TYPICAL ROAD CROSS SECTIONS - PARKSIDE CIRCUIT (EAST & WEST LINKS - SOUTH JUNCTION)

FOR CONSTRUCTION

Project RIVER VALLEY - STAGE 7D4 Drawing Title
TYPICAL ROAD CROSS SECTIONS (SHEET 2 OF 2) YOURLAND Drawn Scale Date of First Issue FOR CONSTRUCTION VR 1:50 @ A1


ENGINEERING APPROVAL

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SECTION S7D-2

 $Q_{1\%AEP}$ (7D AREA) = 1.2m3/s (From Civil Site Design Software model. Refer to catchment hydrology report in C-2104 for individual pits catchment flows & C-9600 for Catchment plan.)

 $Q_{1\%AEP}$ (GLEN ORA GAP FLOW ALLOWANCE) = 2.0m3/s

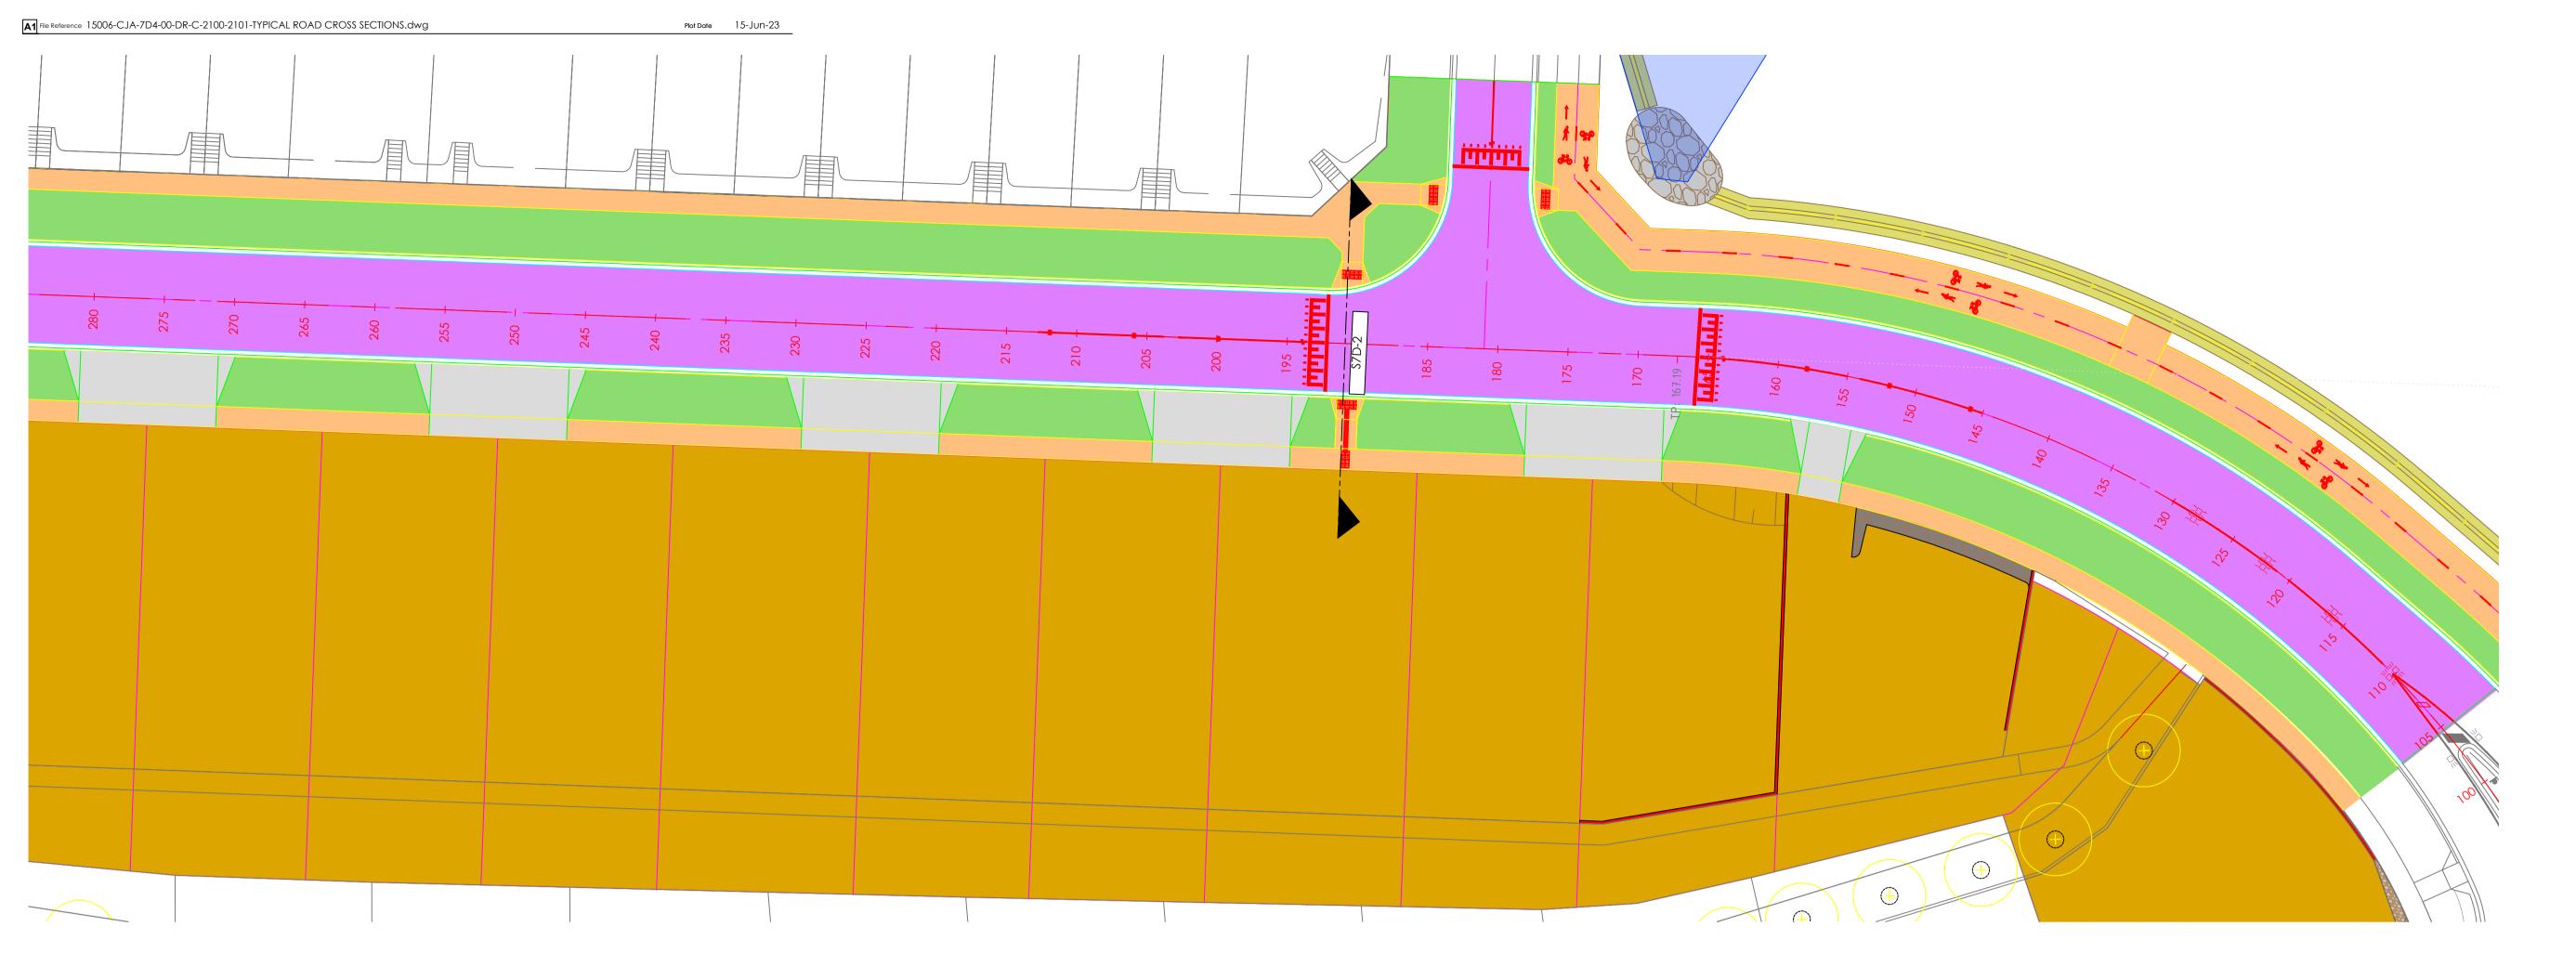 $Q_{1\%AEP}$ (TOTAL) = <u>**3.2m3/s**</u>

PIPE H.G.L. CAPACITY = **4794 l/s =** 4145(D25-D24) + 649.4(D104-D72)

(REFER TO C-2105/2106)

The pipes alone have capacity for Q100 flow so there will be no problem on raised intersection due to Q100 flows.

drawing.

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FOR CONSTRUCTION







Project RIVER VALLEY - STAGE 7D4 Drawing Title
CRITICAL SECTION CALCULATION (SHEET 1 OF 2) Client YOURLAND

0 1 2.5 5 7.5 10 15

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Purpose of Issue
FOR CONSTRUCTION Checked By Drawn Scale Date of First Issue VR AS SHOWN @ A1 18.09.23 Number Revision 2102 0 15006 CJA 7D4 XX DR C

SECTION S7D-3

 $Q_{1\%AEP}$ (7D AREA) = **2.33 m3/s** (From Civil Site Design Software model. Refer to catchment hydrology report in C-2104 for individual pits catchment flows & C-9600 for Catchment plan)

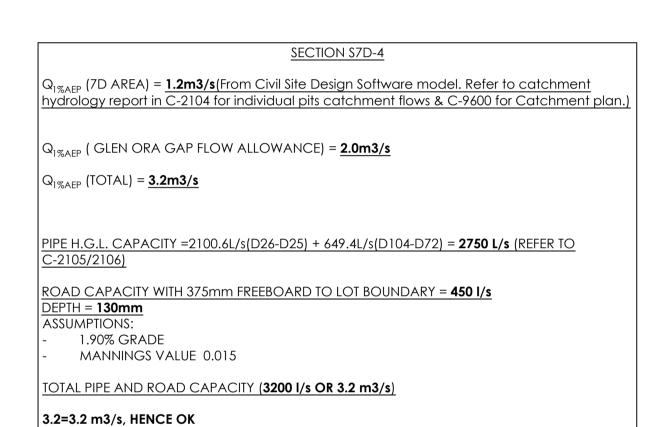
 $Q_{1\%AEP}$ (GLEN ORA GAP FLOW ALLOWANCE) = $\underline{2.0 \text{ m3/s}}$

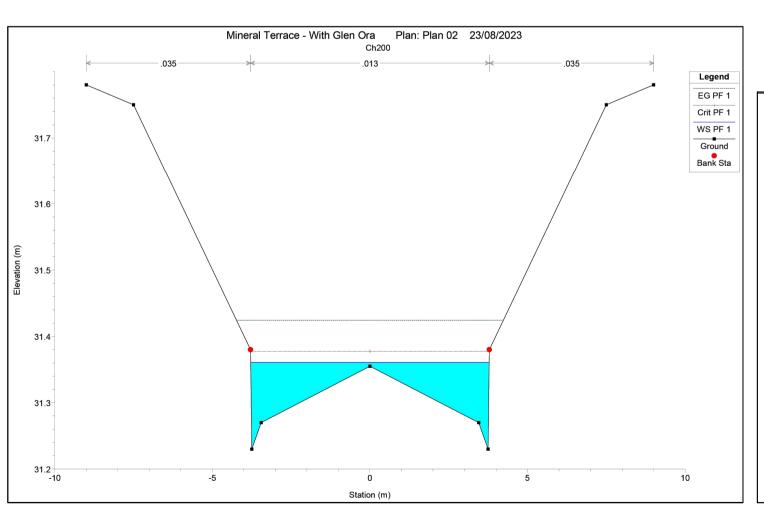
 $Q_{1\%AEP}$ (TOTAL) = <u>**4.33 m3/s**</u>

HGL PIPE CAPACITY = 4145I/s(D24-25)+649.4I/s(D72-D104) = 4794I/s (REFER TO C-2105/2106)

PIPE CAPACITY (4794 I/s OR 4.79 m3/s)


4.79>4.33 m3/s, HENCE OK










1 IN 100 YEAR CRITICAL (SECTION S7D-4)

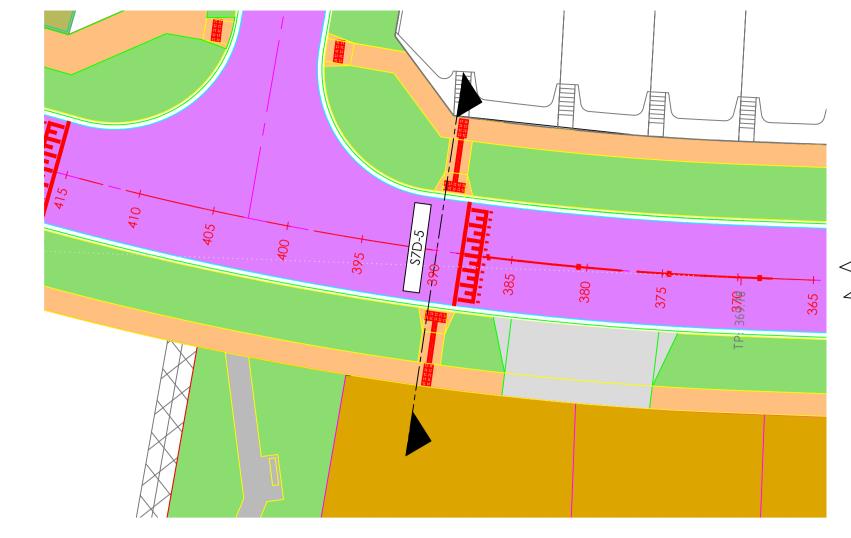


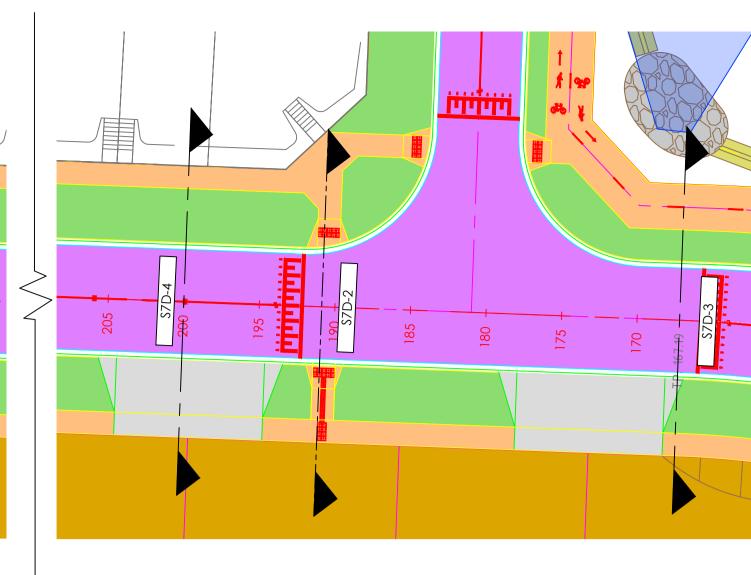

MINERAL TERRACE -	- RAISED PLATFORM
V _{AVE}	1.18 m/s
D _{AVE}	110 mm
D _{AVE} x V _{AVE}	$0.13 \text{ m}^2/\text{s} < 0.35 \text{ m}^2/\text{s}$

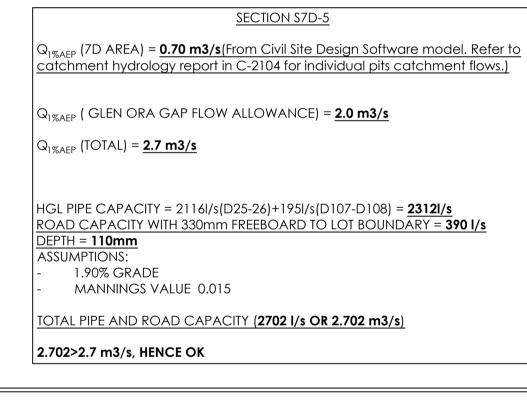

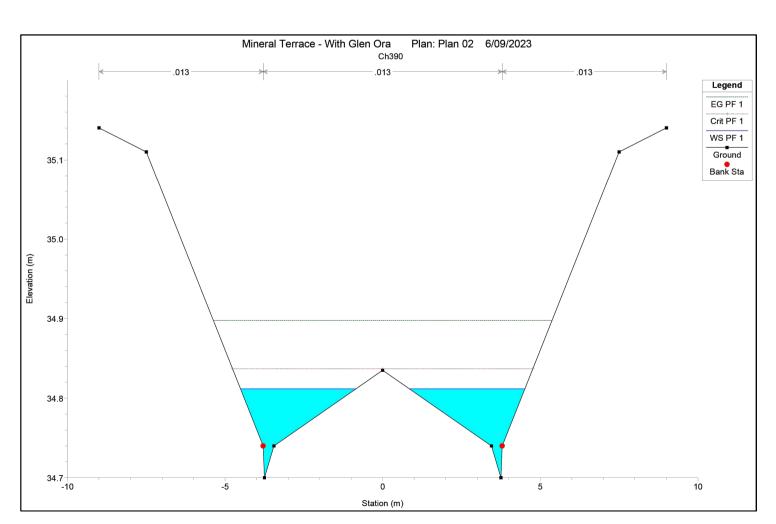

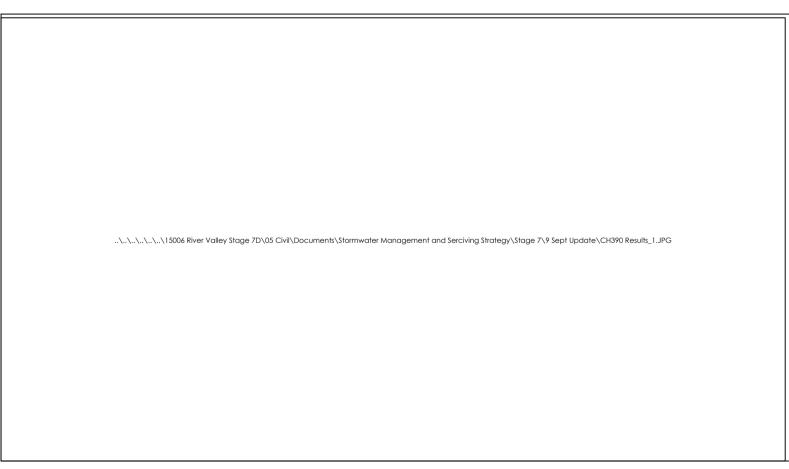

15006 CJA 7D4 XX

1 IN 100 YEAR CRITICAL (SECTION S7D-5)

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FOR CONSTRUCTION





Project RIVER VALLEY - STAGE 7D4 Drawing Title
CRITICAL SECTION CALCULATION (SHEET 2 OF 2) YOURLAND Drawn Scale FOR CONSTRUCTION N/A @ A1 18.09.23


DR

	Single Catchment Area	J.		Adopted Pit Tc	Rainfall Intensity a	Total Catchment Flow	Catchment Flow Direct to Pipe	Catchment Flow to Pit Inlet	Specified Inflow to Pit	Total Flow to Pit
<u>o</u>	chm a	Pit C Factor	Pit Effective Area	Piŧ	ıten	chill [*]	+ F	† F Inle	ᄩ	7 +0
±	Catch Area	ш́.	Effect Area	ed	<u></u>	Cat -lo	леп † †	nen ∓;c	ied o P	2
Д	Jle /	<u>+</u>	±	opt	ıfal	le l	rh j	12.0	ecif †	<u> </u>
	Sing	Ф	۵	PΑ	\air	Tot	Cat Dir	Cat +	Spe	[ot:
	(Ha)		(Ha)	(min)	(mm/hr)	(l/s)	(l/s)	(l/s)	(l/s)	(1/5
D2					186.0			_		0.0
D3					186.0					0.0
D3A					186.0					0.0
D3B					186.0					0.0
D3 D3A D3B D4 D5 D6 D7 D8 D50 D9 D51 D10 D104 D52 D11 D103 D53 D53 D12 D88 D102 D54 D13 D101 D99 D89 D55 D14 D97 D100 D90 D56 D15 D98 D91 D78 D98 D91 D78 D92 D96					186.0					0.1
					186.0					1.1
	0.151	0.900	0.136	6	186.0 174.0	65.7		65.7		18. 85.
	0.151	0.700	0.150	0	186.0	03.7		05.1		1.6
	0.158	0.873	0.138	7	165.5	63.4		63.4		87.
	0.043	0.800	0.034							
	0.115	0.900	0.104							
	0.048	0.800	0.038	7	165.5	17.7		17.7		26.
D51	0.250	0.826	0.207	7	165.5	95.0		95.0		98.
	0.184	0.800	0.147							
□10	0.066 0.148	0.900	0.059	7	165.5	57.5		57.5		62.
۱۷ ت	0.146	0.800	0.125	'	כירטו	ב.ו כ		د.، د		02.
	0.067	0.900	0.060							
D104	0.069	0.900	0.062	6	174.0	30.0		30.0		30.
D52					186.0					28.
D11	0.068	0.843	0.057	7	165.5	26.3		26.3		44.
	0.039	0.800	0.031							
D402	0.029	0.900	0.026		477.0	20.0		70.0		70
	0.074	0.900	0.067	6 7	174.0 165.5	32.2 88.5		32.2 88.5		32. 106
	0.190	0.800	0.152	,	103.3	00.5		00.5		100
	0.045	0.900	0.041							
D12	0.155	0.832	0.129	7	165.5	59.3		59.3		80.
	0.105	0.800	0.084							
	0.050	0.900	0.045							
	0.024	0.900	0.022	6	174.0	10.4		10.4		30.
	0.078	0.900	0.070	6	174.0	33.9		33.9		33.
D34	0.141	0.828	0.117	7	165.5	53.6		53.6		80.
	0.039	0.900	0.035							
D13	0.223	0.833	0.186	7	165.5	85.4		85.4		88.
	0.149	0.800	0.119							
	0.074	0.900	0.067							
	0.054	0.900	0.049	6	174.0	23.5		23.5		23.
	0.195	0.800	0.156	7	165.5	71.7		71.7		85.
	0.039	0.800	0.031	7	165.5	14.3		14.3		30.
	0.032	0.900	0.029	6 7	174.0 165.5	13.9 37.1		13.9 37.1		103. 37.
	0.032	0.900	0.029	6	174.0	13.9		13.9		16.
	0.203	0.800	0.162	7	165.5	74.7		74.7		74.
	0.178	0.800	0.142	7	165.5	65.5		65.5		79.
D56	0.580	0.806	0.467	7	165.5	214.8		214.8		217
	0.548	0.800	0.438							
	0.032	0.900	0.029	-	.=:					
	0.025	0.900	0.023	6	174.0	10.9		10.9		12.
	0.097 0.185	0.900	0.087	6 7	174.0 165.5	42.2 68.0		42.2 68.0		42. 74.
	0.059	0.900	0.148	6	174.0	25.7		25.7		28.
	0.030	0.900	0.027	6	174.0	13.1		13.1		16.
					186.0					
D83	0.057	0.900	0.051	6	174.0	24.8		24.8		26.
D10 D104 D52 D11 D103 D53 D12 D88 D102 D54 D13 D101 D99 D89 D55 D14 D97 D100 D90 D56 D15 D98 D91 D78 D91 D78 D91 D78 D91 D78 D91 D78 D92	0.155	0.800	0.124	7	165.5	57.0		57.0		58.
	0.064	0.900	0.058	6	174.0	27.8		27.8		27.
	0.036	0.900	0.032	6	174.0	15.7		15.7		16.
	0.065	0.900	0.059	6	174.0	28.3		28.3		29.
לעט	0.087	0.769	0.067	6	174.0	32.3		32.3		32.
	0.057	0.700	0.027							
D17	0.051	5.700	3.370		186.0					
	0.048	1.000	0.048	6	174.0	23.2		23.2		23.
D84					186.0					2.2
	0.048	0.800	0.038	7	165.5	17.7		17.7		17.

					nine N					
Pit No.	Single Catchment Area	Pit C Factor	Pit Effective Area	Adopted Pit Tc	Rainfall Intensity	Total Catchment Flow	Catchment Flow Direct to Pipe	Catchment Flow to Pit Inlet	Specified Inflow to Pit	Total Flow to Pit
÷	Catch Area	J.	Eff Ar	ted		Ca Flo	Et t	nme Pi†	fiec to	Flo
_		PiŦ	i.	фор	infe	ıtal	atch Jire	#t.t	эесі	tal
	Si			⋖	Ra	1 L	ت ن	ٽ	S	2
	(Ha)		(Ha)	(min)	(mm/hr)	(l/s)	(l/s)	(l/s)	(l/s)	(l/s
D87	0.036	0.900	0.032	6	174.0	15.7		15.7		15.7
D59	0.418	0.800	0.334	7	165.5	153.7		153.7		192.
D86	0.063	0.900	0.057	6	174.0	27.4		27.4		27.4
D18	0.099	0.820	0.081	6	174.0	39.2		39.2		39.2
	0.020	0.900	0.018							
D85	0.079	0.800 1.000	0.063	6	174.0	36.7		36.7		36.7
D81	0.073	0.900	0.076	6	174.0	16.1		16.1		17.1
D33A	0.031	0.700	0.00	0	186.0	10.1		10.1		17.1
D19	0.076	0.900	0.068	6	174.0	33.1		33.1		33.1
D82	0.035	1.000	0.035	6	174.0	16.9		16.9		16.9
D60	0.318	0.569	0.181	7	165.5	83.2		83.2		127.
	0.061	0.800	0.049							
	0.133	0.900	0.120							
	0.124	0.100	0.012							
D33B					186.0					
D20					186.0					
D61	0.261	0.819	0.214	7	165.5	98.2		98.2		134.
	0.212	0.800	0.170							
D77	0.049	0.900	0.044		17/ 0	25.2		25.2		25.0
D77 D33C	0.058	0.900	0.052	6	174.0 186.0	25.2		25.2		25.2
D21	0.083	0.784	0.065	6	174.0	31.5		31.5		31.5
	0.035	0.704	0.032	-	177.0	د.ا د		د.، د		د.ا د
	0.048	0.700	0.034							
D35A					186.0					
D76	0.049	0.900	0.044	6	174.0	21.3		21.3		21.3
D22	0.037	0.900	0.033	14	122.9	11.4		11.4		11.4
		0.900	0.000							
		0.800	0.000							
		0.350	0.000							
D/C	0.037	0.900	0.033	_	445 -	440 =		440 =		40.0
D62	0.480	0.542	0.260	7	165.5	119.5		119.5		120.8
	0.248	0.800	0.198							
	0.048	0.900	0.043							
D35B	3.104				186.0					
D22B					186.0					
D63					186.0					0.3
D75	0.048	0.900	0.043	6	174.0	20.9		20.9		20.9
D35C					186.0					
D22A					186.0					
D64					186.0					5.5
D23	0.026	0.900	0.023	5	186.0	12.1		12.1		12.1
D65	0.143	0.826	0.118	7	165.5	54.3		54.3		55.7
	0.106	0.800	0.085							
23A	0.037	0.900	0.033		186.0					
D74	0.052	0.785	0.041	6	174.0	19.7		19.7		19.7
J 1 T	0.032	0.703	0.041		177.0	12.1		17.1		19.1
	0.030	0.700	0.021							
D66					186.0					7.0
D73	0.038	0.900	0.034	6	174.0	16.5		16.5		16.5
D24	0.018	0.900	0.016	5	186.0	8.4		8.4		8.4
D67	0.155	0.820	0.127	7	165.5	58.4		58.4		59.1
	0.124	0.800	0.099							
	0.031	0.900	0.028							
D25	0.109	0.856	0.093	6	174.0	45.1		45.1		45.1
	0.048	0.800	0.038							
 -	0.061	0.900	0.055	_	.=	4===		7= -		
D37	1.240	0.350	0.434	8	157.0	189.3		189.3		189.
D72	0.071	0.807	0.057	6	174.0	27.7		27.7		27.7
	0.038	0.900	0.034							
D68	0.033	0.700	0.023	7	165.5	52.7		52.7		53.6
200	0.137	0.800	0.070		ר.כטו	۱.۵د		32.1		٥,٠.
	0.050	0.900	0.045							
D71	0.025	0.900	0.023	6	174.0	10.9		10.9		10.9
D26	0.196	0.833	0.163	6	174.0	78.9		78.9		78.9
	0.131	0.800	0.105		1					

	±				nine N		>	_	>	:±
	Single Catchment Area	Pit C Factor	Pit Effective Area	Adopted Pit Tc	Rainfall Intensity	Пеп	Catchment Flow Direct to Pipe	Catchment Flow to Pit Inlet	Specified Inflow to Pit	Total Flow to Pit
No.	tch ea	ac1	ect ea	<u>a</u>	nte	t ₹	± .e	늘르	드	3
±	Catcl Area	Ü	Eff Ar	ted		Ca Fl	# 	Pit	fiec to	П
_) Igle	Ε̈́Ξ	<u></u>	фор	linfa	tal	atch ire	atch to)eci	Ī
	i <u>s</u>			A	Ra	Total Catchment Flow	ت ت	ٽ	S	Ĺ
D38 D104 D69 D27 E0S D70 D105 D28 D126 D106 D29 D41 D118 D107 D30 D110 D42 D49 D117 D108 D31 E0S D43 D48 D49 D415 E0S D41 D115 E0S D111	(Ha)		(Ha)	(min)	(mm/hr)	(l/s)	(l/s)	(l/s)	(l/s)	(1/:
	0.015	0.900	0.014	5	186.0	7.0		7.0		7.
D104	0.112	0.782	0.088	6	174.0	42.3		42.3		42
	0.046	0.700	0.041							
D69	0.047	0.700	0.033	6	174.0	15.9		15.9		15.
D27	0.292	0.820	0.239	6	174.0	115.7		115.7		115
	0.235	0.800	0.188							
FNS	0.057	0.900	0.051		186.0					
	0.019	0.900	0.017	5	186.0	8.8		8.8		8.8
	0.206	0.745	0.153	6	174.0	74.1		74.1		74
	0.046	0.900	0.041							
	0.160	0.700	0.112							
D28	0.240	0.805	0.193	6	174.0	93.4		93.4		93.
	0.013	0.900	0.012 0.182							
D105 D28 D126 D106 D29 D41 D118 D107 D30 D110 D42 D49 D117	0.006	0.900	0.102	5	186.0	2.8		2.8		2.8
D38 D104 D69 D27 EOS D70 D105 D28 D126 D106 D106 D29 D41 D118 D107 D30 D110 D42 D49 D117 D108 D43 D48 D49 D117 D108	0.185	0.761	0.141	6	174.0	68.0		68.0		68.
	0.056	0.900	0.050							
	0.129	0.700	0.090							
	0.014	0.900	0.013	5	186.0	6.5	6.5		6.!	
	0.030	0.900	0.027	5	186.0 186.0	14.0 22.3		14.0 22.3		22
	0.048	0.742	0.043	6	174.0	74.2		74.2		74
	0.043	0.900	0.039							
	0.164	0.700	0.115							
	0.019	0.900	0.017	5	186.0	8.8		8.8		8.8
D110	0.172	0.500	0.086	6	174.0	41.6		41.6		41.
	0.047	0.900	0.042							
Π42	0.125	0.900	0.044	6	174.0	20.4		20.4		20.
	0.040	0.900	0.036	5	186.0	18.6		18.6		18.
D117	0.047	0.900	0.042	5	186.0	21.9		21.9		21.
D108	0.196	0.855	0.168	6	174.0	81.0		81.0		81.
	0.152	0.900	0.137							
N31	0.044	0.700	0.031	5	186.0	17.7		17.7		17.
	0.030	0.700	0.054		186.0	17.7		17.7		17.
	0.068	0.818	0.056	6	174.0	26.9		26.9		26
	0.012	0.900	0.011							
	0.056	0.800	0.045							
	1.170	0.350	0.410	5	186.0	211.6		211.6		211
	0.222	0.100	0.022	5	174.0 186.0	10.7		10.7		10. 20
	0.400	0.350	0.039	6	174.0	67.7		67.7		67
D110 D42 D49 D117 D108 D31 EOS D43 D48 D49A D116 D115 EOS					186.0					
D107 D30 D110 D42 D49 D117 D108 D31 E0S D43 D48 D49A D116 D115 E0S	0.151	0.507	0.077	6	174.0	37.0		37.0		37
	0.043	0.900	0.039							
D.L.L.	0.108	0.350	0.038		17/ 0	227		227		רכ
U44	0.084	0.829	0.070	6	174.0	33.6		33.6		33
	0.060	0.800	0.048							
D43A	0.087	0.900	0.078	6	174.0	37.8		37.8		37
					186.0					
D112	0.095	0.599	0.057	6	174.0	27.5		27.5		27
	0.043	0.900	0.039							
D45	0.052	0.350 0.816	0.018	6	174.0	45.8		45.8		45
_ · •	0.019	0.900	0.017			. 5.0		. 5.0		ر
	0.097	0.800	0.078							
JOIN					186.0					
D113	1.149	0.739	0.849	7	165.5	390.4		390.4		390
	0.225	0.900	0.203							
D46	0.924	0.700	0.647	6	174.0	54.8		54.8		54
PTU	0.140	0.007	V. IIJ	٠ ٠	114.0	0.+د ∣	I	0.+د ∣		4ر

			S	Sunsh	ine N	lth				
Pi† No.	Single Catchment Area	Pit C Factor	Pit Effective Area	Adopted Pit Tc	Rainfall Intensity	Total Catchment Flow	Catchment Flow Direct to Pipe	Catchment Flow to Pit Inlet	Specified Inflow to Pit	Total Flow to Pit
	(Ha)		(Ha)	(min)	(mm/hr)	(l/s)	(l/s)	(l/s)	(l/s)	(l/s)
D45A	0.131	0.900	0.118	6	174.0	57.0		57.0		57.0
D34	0.023	0.900	0.021	5	186.0	10.7		10.7		10.7
D114	0.019	0.900	0.017	5	186.0	8.8		8.8		8.8
D47	0.087	0.808	0.070	6	174.0	34.0		34.0		34.0
	0.080	0.800	0.064							
	0.007	0.900	0.006							
D35	0.020	0.900	0.018	5	186.0	9.3		9.3		9.3
D34A	0.029	0.900	0.026	6	174.0	12.6		12.6		12.6
D36	0.032	0.819	0.026	6	174.0	12.7		12.7		12.7
	0.006	0.900	0.005							
	0.026	0.800	0.021							

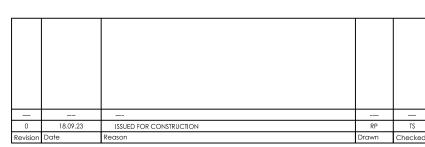

Note for Contractors

The works described on this drawing must be undertaken by competent Contractors with an appropriate level of experience who have prepared appropriate Safe Work Method Statements (SWMS) relating to these works. The contractor is responsible for the

drawing. This drawing should not be issued in part and must be read in conjunction with all appropriate specifications, notes pages, details and authority drawings as appropriate.

management of all risks associated with the construction activities stated on this

Dial before you dig. BEWARE OF UNDERGROUND SERVICES. The location of underground services are approximate only and their exact position should be proven on site. No guarantee is given that existing services are shown.

FOR CONSTRUCTION







15006 CJA 7D4 XX

Project RIVER VALLEY - STAGE 7D4 Client YOURLAND


Drawing Title
HYDROLOGY CATCHMENT REPORT Purpose of Issue
FOR CONSTRUCTION Checked By Drawn Scale Date of First Issue TS N/A @ A1 18.09.23 Number Revision 2104 0

File Type Role

DR C

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Connecting Pits tream Upstream)	Diameter	ength	esign Flow	n sgn	elocity	elocity Head	Downstream Pit	ion Slope	ion Loss	Upstream Pit	Coefficient	ad Loss	Upstream Water Level	Surcharge Level Inlet/Outlet Level)	Pipe Obvert	Pipe Obvert	Pipe Invert	Pipe Invert	Slope	lesign Flow	
Pipe Conned (Downstream		Pipe L	Des	Mannings	>	Velo	MoO	Friction	Friction		SS	Head	Ups Le	Surcharge net/Outle	ваш		Downstream		Pipe		
ne Ci	Pipe	P	Pipe	Σ	Pipe	Pipe \	at t	Pipe F	Pipe	L at	Lo	Pipe	t ed	. Su	ıstrı	Upstream	ıstr	Upstream		Pipe	
Pipe (Down)			ш.			<u>a</u>	HGL	<u>-</u>	Δ.	HGL	PiŦ		dopted	Pit (Pit	Downstream	Ups	Jowi	Ups			
	(mm)	(m)	(l/s)		(m/s)	(m)	(m)	(%)	(m)	(m)	Ku	(m)	(m)	(m)	(m)	(m)	(m)	(m)	(%)	(l/s)	
D1 D2	1350	2.800	3580.1	0.013	2.43	0.301	5.070	0.00	0.007	5.077	0.500	0.150	5.227	5.361	5.070	5.084	3.700	3.714	0.500	3580.1	5
D2 D3	1350	51.013	3611.6	0.013	2.45	0.306	5.227	0.00	0.133	5.361	2.000	0.613	5.973	7.086	5.163	5.470	3.793	4.100	0.602	3611.6	-
D3 D3A	1200	16.223	3617.4	0.013	3.09	0.489	5.973	0.00	0.076	6.378	0.000	0.000	6.378	10.772	6.320	6.726	5.100	5.506	2.500	3617.4	8
D3A D3B D3B D4	1200	20.842 8.111	3624.8 3627.7	0.013	3.10	0.491	6.378	0.00	0.099	6.898 7.101	2.000	0.000	6.898 8.083	11.613 11.682	6.730 7.250	7.250 7.453	5.510 6.030	6.030 6.233	2.495 2.500	3624.8 3627.7	8
D4 D5	1200	3.861	3629.1	0.013	3.10	0.492	8.083	0.00	0.018	8.179	2.000	0.983	9.162	11.663	8.603	8.700	7.383	7.480	2.500	3629.1	8
D5 D6	1200	4.860	3630.7	0.013	3.11	0.492	9.162	0.00	0.023	9.283	0.500	0.246	9.529	11.639	9.629	9.750	8.409	8.530	2.500	3630.7	8
D6 D7	1200	8.971	3632.2	0.013	3.11	0.493	9.529	0.00	0.043	9.624	1.100	0.542	10.165	11.590	9.770	9.865	8.550	8.645	1.059	3632.2	-
D7 D8 D7 D50	900	11.332	2512.3 1220.5	0.013	3.86 1.88	0.761	10.165 10.165	0.01	0.117	10.282	0.727 2.200	0.553 0.395	10.835	11.632 11.514	9.863 9.848	9.920	8.953 8.938	9.010 9.130	0.500 1.860	2512.3 1220.5	1
D8 D9	900	14.054	2516.3	0.013	3.87	0.764	10.835	0.01	0.145	10.980	0.783	0.598	11.579	11.621	9.990	10.060	9.080	9.150	0.500	2516.3	1
D50 D51	675	57.814	1175.0	0.013	3.19	0.519	10.586	0.01	0.574	11.160	0.500	0.259	11.419	11.804	10.036	10.325	9.351	9.640	0.500	1175.0	
D9 D10 D51 D104	900	33.899 9.600	2513. 7 28.2	0.013	3.86 0.40	0.762	11.579 11.419	0.01	0.349	11.928 11.424	0.500 5.000	0.381	12.309 11.465	11.790 11.862	10.141 10.320	10.310 10.497	9.231	9.400	0.500 1.844	2513.7 28.2	1
D51 D104	675	50.029	1099.0	0.013	2.98	0.454	11.419	0.00	0.436	11.855	0.000	0.041	11.855	12.063	10.320	10.497	9.720	9.970	0.500	1099.0	
D10 D11	900	31.868	2462.6	0.013	3.79	0.731	11.790	0.01	0.315	12.106	0.500	0.366	12.471	11.951	10.381	10.540	9.471	9.630	0.500	2462.6	,
D10 D103	300	9.600	30.3	0.013	0.43	0.009	11.790	0.00	0.006	11.796	5.000	0.047	11.843	11.849	10.300	10.480	10.000	10.180	1.875	30.3	
D52 D53 D11 D12	675 825	18.426 34.890	1086.6 2177.4	0.013	2.95 3.95	0.444	11.855 11.951	0.01	0.157	12.012 12.365	0.500	0.222	12.234 12.762	12.139 12.148	10.655	10.747	9.970 9.700	10.062 9.940	0.499	1086.6 2177.4	.
D11 D88	375	33.845	326.8	0.013	2.96	0.447	11.951	0.02	0.598	13.561	2.265	1.012	14.571	16.929	10.529	13.725	10.154	13.350	9.443	326.8	
D53 D102	300	9.600	31.9	0.013	0.45	0.010	12.139	0.00	0.006	12.146	5.000	0.052	12.198	12.198	10.734	10.830	10.434	10.530	1.000	31.9	
D53 D54	600	40.364	1002.5	0.013	3.43	0.600	12.139	0.01	0.531	12.670	0.600	0.360	13.030	12.784	10.743	11.470	10.133	10.860	1.800	1002.5	ļ.,
D12 D13 D12 D101	750 300	49.496 9.600	2124.6	0.013	4.68 0.31	1.119 0.005	12.148 12.148	0.02	0.920	13.069 12.151	0.500 5.000	0.560	13.628 12.176	13.146	10.770	11.750 10.856	10.010	10.990	1.980	2124.6	1
D88 D99	300	60.532	125.8	0.013	1.78	0.162	14.571	0.01	0.524	15.687	1.399	0.226	15.913	17.710	14.550	15.760	14.250	15.460	1.999	125.8	
D88 D89	375	11.300	192.6	0.013	1.74	0.155	14.571	0.01	0.072	14.643	1.500	0.233	14.876	16.756	13.798	13.855	13.423	13.480	0.500	192.6	
D54 D55 D13 D14	750	16.027 46.336	952.1 2041.7	0.013	3.26 4.50	0.542 1.033	12.784 13.146	0.01	0.191	12.975 13.943	0.600	0.325 0.517	13.300	13.764	11.549 11.820	11.870	10.939	11.260 12.030	2.000	952.1 2041.7	'
D13 D14	300	9.600	54.4	0.013	0.77	0.030	13.146	0.00	0.017	13.163	2.200	0.067	13.229	13.204	11.740	11.836	11.440	11.536	1.000	54.4	
D99 D100	225	45.145	60.8	0.013	1.48	0.111	15.913	0.01	0.380	16.827	5.000	0.556	17.383	18.850	15.769	16.899	15.540	16.670	2.503	60.8	
D89 D90 D55 D56	375 600	62.520 8.714	177.0 889.9	0.013	1.60 3.05	0.131	14.876 13.300	0.01	0.338	15.214 13.391	1.300 2.318	0.170 1.096	15.385 14.486	16.318 13.915	13.932 11.946	14.245 12.120	13.557 11.336	13.870 11.510	0.500 2.000	177.0 889.9	.
D14 D15	750	13.707	2018.2	0.013	4.45	1.010	14.256	0.02	0.230	14.487	1.000	1.010	15.496	14.784	12.868	13.340	12.108	12.580	3.444	2018.2	
D97 D98	300	29.666	39.7	0.013	0.56	0.016	13.204	0.00	0.029	13.233	5.000	0.080	13.314	13.946	11.910	12.740	11.610	12.440	2.798	39.7	
D90 D91	300	68.000	122.7	0.013	1.74	0.154	15.385	0.01	0.561	15.946	1.604	0.246	16.192	15.968	14.250	14.590	13.950	14.290	0.500	122.7	_
D56 D78	375 600	17.383 46.420	111.5 687.6	0.013	1.01 2.35	0.052	13.915 13.915	0.00	0.039	13.954 15.149	1.600 0.600	0.083	14.037 15.318	13.855	12.103 12.194	12.465 15.490	11.728	12.090 14.880	7.100	111.5 687.6	2
D15 D16	750	5.580	1953.1	0.013	4.31	0.946	14.784	0.02	0.088	14.872	0.500	0.473	15.345	15.004	13.415	13.570	12.655	12.810	2.778	1953.1	2
D15 D83	300	11.358	81.9	0.013	1.16	0.069	14.784	0.00	0.043	14.827	1.492	0.102	14.930	14.934	13.330	13.600	13.030	13.300	2.377	81.9	
D91 D92 D78 D96	300	51.573 9.600	67.1 26.2	0.013	0.95	0.046	15.968 13.855	0.00	0.135	16.103 13.860	1.992 5.000	0.091 0.035	16.194 13.895	15.658 13.933	14.662 12.464	14.920 12.560	14.362 12.164	14.620 12.260	0.500 1.000	67.1	
D78 D79	300	54.268	62.0	0.013	0.88	0.007	13.855	0.00	0.004	14.329	1.148	0.035	14.374	15.970	12.470	14.510	12.170	14.210	3.760	62.0	
D57 D58	600	43.006	654.8	0.013	2.24	0.256	15.339	0.01	0.247	16.315	0.600	0.154	16.468	17.994	15.581	16.557	14.971	15.947	2.270	654.8	
D57 D95	300	8.500	30.4	0.013	0.43	0.009	15.318	0.00	0.005	15.403	5.000	0.047	15.451	16.964	15.485	15.570	15.185	15.270	1.000	30.4	ļ.
D16 D17 D83 D94	750 300	14.593	1955.3 21.8	0.013	4.31 0.31	0.948	15.004 14.930	0.02	0.231	15.234 14.936	5.000	0.758	15.992 14.960	15.526 15.223	13.650 13.670	14.500	12.890	13.740	5.825 2.021	1955.3	-
D83 D84	300	19.757	36.4	0.013	0.52	0.003	14.930	0.00	0.016	14.946	1.142	0.015	14.961	15.462	13.670	14.070	13.370	13.770	1.822	36.4	
D92 D93	225	20.003	16.6	0.013	0.40	0.008	15.658	0.00	0.015	15.673	5.000	0.041	15.714	15.625	14.919	15.019	14.690	14.790	0.500	16.6	
D79 D80 D79 D87	300	29.867 9.600	32.6 14.7	0.013	0.46	0.011	14.374 14.374	0.00	0.020	15.718 14.470	0.000 5.000	0.000	15.718 14.481	17.381 16.040	14.580 14.584	15.924 14.680	14.280 14.284	15.624 14.380	4.500 1.000	32.6 14.7	
D58 D59	600	27.433	617.7	0.013	2.11	0.002	16.636	0.00	0.002	16.820	0.500	0.011	16.934	18.264	16.636	16.820	16.026	16.210	0.670	617.7	
D58 D86	300	8.502	25.8	0.013	0.36	0.007	16.468	0.00	0.004	16.553	5.000	0.034	16.587	18.024	16.545	16.630	16.245	16.330	1.000	25.8	
D17 D18	750	17.362	1957.5	0.013	4.32	0.950	15.526	0.02	0.275	15.801	0.500	0.475	16.276	17.291	14.580	15.970	13.820	15.210	8.006	1957.5	1
D84 D85 D80 D81	300	8.089 6.138	34.5 31.8	0.013	0.49	0.012	14.961 15.718	0.00	0.006	14.968 15.994	5.000 2.200	0.061	15.028 16.01 7	15.569 17.688	14.110 15.924	14.215 16.200	13.810 15.624	13.915 15.900	1.298 4.500	34.5 31.8	
D59 D33A	600	50.867	471.7	0.013	1.61	0.010	16.934	0.00	0.004	17.089	0.500	0.023	17.156	18.602	16.890	17.181	16.280	16.571	0.572	471.7	
D18 D19	750	19.431	1932.2	0.013	4.26	0.926	16.276	0.02	0.300	17.680	2.500	2.314	19.992	19.845	16.050	18.050	15.290	17.290	10.293	1932.2	-
D81 D82	300	9.600	15.9	0.013	0.22	0.003	16.059	0.00	0.002	16.178	5.000	0.013	16.191	17.758	16.281	16.400	15.981	16.100	1.240	15.9	
D33A D60 D33A D33B	150	3.231 8.068	472.5 0.0	0.013	0.00	0.133	17.156 17.156	0.00	0.010	17.174 17.930	0.500	0.067	17.241	18.633	17.181 16.950	17.200 18.080	16.571	16.590 17.930	0.572 14.005	472.5 0.0	
D19 D20	750	18.501	1912.4	0.013	4.22	0.907	19.845	0.02	0.280	20.125	0.000	0.000	20.125	21.088	18.936	19.510	18.176	18.750	3.100	1912.4	:
D60 D61	525	62.736	386.4	0.013	1.73	0.152	17.241	0.00	0.255	17.624	0.500	0.076	17.700	19.051	17.191	17.624	16.657	17.090	0.690	386.4	
D60 D77 D33B D33C	300 150	8.498 26.411	0.0	0.013	0.34	0.006	17.241 17.980	0.00	0.003	17.244 21.700	5.000 5.000	0.029	17.273 21.700	18.663 25.240	17.185 18.130	17.270 21.850	16.885 17.980	16.970 21.700	1.000	0.0	
D20 D21	750	19.032	1915.9	0.009	4.22	0.000	20.125	0.00	0.000	20.414	0.000	0.000	20.414	25.240	19.590	20.180	18.830	19.420	3.100	1915.9	
	525	52.026	291.1		+		17.700	0.00	0.123	18.046	0.500	0.043	18.089	19.398	17.708	18.054	-	+		+	

				HGL	Repo	ort –	Retu	rn P	eriod:	100y	/rs	Loc	ation	: Sun	shine	Nth					
Pipe Connecting Pits (Downstream Upstream)	Pipe Diameter	Pipe Length	Pipe Design Flow	Mannings n	Pipe Velocity	Pipe Velocity Head	HGL at Downstream Pit	Pipe Friction Slope	Pipe Friction Loss	HGL at Upstream Pit	Pit Loss Coefficient	Pipe Head Loss	Adopted Upstream Water Level	Pit Surcharge Level (Pit Inlet/Outlet Level)	Downstream Pipe Obvert	Upstream Pipe Obvert	Downstream Pipe Invert	Upstream Pipe Invert	Pipe Slope	Pipe Design Flow	Pipe HGL Capacity
	(mm)	(m)	(l/s)		(m/s)	(m)	(m)	(%)	(m)	(m)	Ku	(m)	(m)	(m)	(m)	(m)	(m)	(m)	(%)	(l/s)	(l/s)
D21 D22	750	11.860	1895.6	0.013	4.18	0.891	20.414	0.01	0.176	20.591	0.900	0.802	21.392	22.653	20.260	20.760	19.500	20.000	4.216	1895.6	3220.
D35A D62 D35A D35B	525 150	17.974 7.301	293.7	0.013	0.00	0.088	18.089	0.00	0.043	18.132 18.650	0.800	0.070	18.203 18.650	19.518 21.039	18.002 17.860	18.104 18.800	17.468 17.710	17.570 18.650	0.566 12.876	293. 7 0.0	458.3 83.9
D22 D22B	825	3.995	4007.4	0.013	7.27	2.694	21.392	0.04	0.157	21.549	0.500	1.347	22.894	23.078	21.108	21.418	20.270	20.580	7.759	4007.4	5653.
D62 D63	450	22.526	196.7	0.013	1.24	0.078	18.203	0.00	0.060	18.262	0.000	0.000	18.262	19.669	18.090	18.240	17.640	17.790	0.666	196.7	318.3
D62 D75	300	10.315	19.6	0.013	0.28	0.004	18.203	0.00	0.003	18.205	5.000	0.020	18.225	19.587	18.087	18.190	17.787	17.890	1.000	19.6	135.
D35B D35C	150	23.468	0.0	0.009	0.00	0.000	20.200	0.00	0.000	20.780	5.000	0.000	20.780	23.060	20.350	20.930	20.200	20.780	2.471	0.0	35.7
D22B D22A D63 D64	825 450	17.735 15.888	4011.2 198.2	0.013	7.27	2.699 0.079	22.894	0.04	0.698	23.592	2.000	5.397	28.984 18.305	25.169 19.777	21.568 18.242	22.91 7 18.350	20.730 17.792	22.079 17.900	7.607	4011.2 198.2	5597 321.
D22A D23	825	17.350	4015.6	0.013	1.25 7.28	2.704	18.262 25.169	0.00	0.043	18.305 25.853	2.000	0.000 5.409	31.262	27.115	23.638	24.818	22.800	23.980	0.680 6.801	4015.6	5289
D64 D65	450	20.527	195.9	0.013	1.23	0.077	18.305	0.00	0.054	18.445	0.500	0.039	18.483	19.914	18.350	18.490	17.900	18.040	0.682	195.9	322.
D23 23A	825	13.833	3990.6	0.013	7.24	2.671	27.115	0.04	0.539	27.654	1.500	4.007	31.657	28.741	25.588	26.618	24.750	25.780	7.446	3990.6	5537
D23 D74	300	9.505	19.7	0.013	0.28	0.004	27.115	0.00	0.003	27.118	5.000	0.020	27.138	27.129	25.780	25.930	25.480	25.630	1.578	19.7	171.6
D65 D66	375	27.000	133.7	0.013	1.21	0.075	18.483	0.00	0.085	19.003	0.000	0.000	19.003	20.273	18.495	19.015	18.120	18.640	1.926	133.7	341.
D65 D73 23A D24	300 825	8.662 12.010	15.5 3993.7	0.013	7.24	0.002 2.675	18.483	0.00	0.002	18.485	5.000 1.500	0.012 4.013	18.497 33.299	19.955 30.268	18.476 27.468	18.563 28.518	18.176 26.630	18.263 27.680	1.000 7.449	15.5 3993.7	135. 5538
D66 D67	375	20.630	128.4	0.013	1.16	0.069	19.003	0.04	0.060	19.403	1.300	0.090	19.493	20.900	19.015	19.415	18.640	19.040	1.939	128.4	342.
D24 D25	825	30.960	2908.3	0.013	5.27	1.419	30.268	0.02	0.579	30.847	0.500	0.709	31.555	31.147	28.696	29.860	27.858	29.022	4.200	2908.3	4145
D24 D37	450	8.630	754.9	0.013	4.75	1.149	30.268	0.04	0.282	30.550	1.795	2.063	32.611	35.008	28.930	29.550	28.480	29.100	7.848	754.9	1125
D24 D72	525	9.003	335.9	0.013	1.50	0.115	30.268	0.00	0.028	30.296	2.200	0.252	30.548	30.241	28.814	29.054	28.280	28.520	2.666	335.9	1016
D67 D68	300	29.300	67.8	0.013	0.96	0.047	19.493	0.00	0.078	20.238	2.103	0.099	20.337	21.774	19.410	20.410	19.110	20.110	3.413	67.8	255.
D67 D71 D25 D26	300 750	8.581 48.880	10.2 2873.5	0.013	6.33	0.001 2.047	19.493 31.147	0.00	1.684	19.494 32.831	5.000 0.500	0.005	19.499 33.855	20.945 32.123	19.413 29.860	19.573 30.770	19.113 29.100	19.273 30.010	1.860	10.2 2873.5	186. 2100
D37 D38	450	10.680	582.6	0.013	3.66	0.685	32.611	0.02	0.224	32.836	1.872	1.282	34.116	31.458	29.600	30.070	29.150	29.620	4.510	582.6	849.
D72 D104	450	30.830	314.2	0.013	1.98	0.199	30.241	0.01	0.271	30.512	0.600	0.119	30.631	31.393	29.050	30.160	28.600	29.710	2.662	314.2	649.
D68 D69	300	8.458	14.9	0.013	0.21	0.002	20.337	0.00	0.001	20.657	5.000	0.011	20.668	21.708	20.480	20.800	20.180	20.500	3.783	14.9	269.
D26 D27	750	72.536	2809.7	0.013	6.19	1.957	32.123	0.03	2.336	34.459	0.500	0.979	35.438	33.476	30.820	32.110	30.060	31.350	1.778	2809.7	2076
D38 E0S	375	5.156	569.4	0.013	5.16	1.356	31.458	0.05	0.270	31.728	0.500	0.678	32.406	32.065	30.075	30.575	29.700	30.200	9.697	569.4	778.
D38 D70	450 375	7.200 63.720	8.8 279.9	0.013	0.06 2.53	0.000	31.458	0.00	0.000	31.458 31.298	5.000 1.000	0.001	31.459 31.626	31.618 32.342	30.120 30.165	30.280 31.065	29.670 29.790	29.830 30.690	2.213 1.768	8.8 279.9	590. 326.
D27 D28	750	63.602	2709.4	0.013	5.97	1.820	33.476	0.03	1.907	35.384	0.000	0.000	35.384	34.668	32.160	33.260	31.400	32.500	1.729	2709.4	2047
EOS D126	375	13.913	570.7	0.013	5.17	1.362	32.065	0.05	0.731	32.797	0.000	0.000	32.797	33.282	30.575	31.924	30.200	31.549	9.697	570.7	778.
D105 D106	375	51.500	214.0	0.013	1.94	0.192	31.626	0.01	0.401	32.027	1.200	0.230	32.257	33.304	31.115	32.025	30.740	31.650	1.767	214.0	326.
D28 D29	750	11.913	2623.4	0.013	5.78	1.706	34.668	0.03	0.335	35.003	0.815	1.390	36.393	34.877	33.310	33.575	32.550	32.815	2.222	2623.4	2326
D126 D41 D126 D118	375	7.620	512.9 58.7	0.013	0.83	1.100 0.035	32.797	0.04	0.325	33.122 32.821	2.000	0.564	33.685 32.891	34.110 33.078	31.975 31.930	32.725 32.100	31.600 31.630	32.350 31.800	9.843	512.9 58.7	784. 161.
D106 D107	375	62.284	152.3	0.013	1.38	0.033	32.757	0.00	0.023	33.077	1.600	0.070	33.232	34.465	32.075	33.235	31.700	32.860	1.862	152.3	335.
D29 D30	450	11.505	132.7	0.013	0.83	0.035	34.877	0.00	0.014	34.891	1.101	0.039	34.930	35.199	33.520	33.670	33.070	33.220	1.304	132.7	450
D29 D110	825	25.411	2492.7	0.013	4.52	1.042	34.877	0.02	0.392	35.269	1.500	1.563	36.832	36.416	33.703	34.168	32.865	33.330	1.831	2492.7	2718
D41 D42	375	37.411	476.8	0.013	4.32	0.951	33.685	0.04	1.383	38.133	1.500	1.426	39.558	39.807	32.775	38.275	32.400	37.900	14.701	476.8	961.
D41 D49 D118 D117	300	7.250 67.789	28.1 39.7	0.013	0.40	0.008	33.685 32.891	0.00	0.004	33.689	1.681	0.014	33.702 33.585	34.165	32.730 32.250	32.880	32.430 32.021	32.580 33.377	2.069	28.1 39.7	197. 95.
D107 D108	300	47.293	81.0	0.013	0.96	0.047	33.232	0.00	0.253	33.504 34.192	5.000	0.080	34.527	34.544	33.240	33.606 34.200	32.940	33.900	2.000	81.0	195.
D30 D31	450	7.208	125.0	0.013	0.79	0.032	34.930	0.00	0.008	34.938	0.500	0.016	34.954	35.186	33.720	33.820	33.270	33.370	1.387	125.0	465
D110 EOS	750	7.124	2453.9	0.013	5.41	1.493	36.416	0.02	0.176	36.592	0.500	0.746	37.338	45.144	34.140	34.931	33.380	34.171	11.109	2453.9	5256
D42 D43	300	30.127	273.8	0.013	3.87	0.765	39.558	0.04	1.179	40.737	0.815	0.624	41.360	40.741	38.280	39.460	37.980	39.160	3.917	273.8	273
D42 D48	300 225	18.102 6.336	211.6	0.013	2.99 0.27	0.457	39.558 33.702	0.02	0.429	39.987	2.394 1.000	1.094	41.081 33.708	39.932	38.280	39.030 33.475	37.980 32.650	38.730	4.143 9.470	211.6	281.
D49 D49A D117 D116	225	67.750	20.0	0.009	0.27	0.004	33.702	0.00	0.002	33.704 34.940	5.000	0.004	35.000	33.337 35.835	32.875 33.656	35.4 #5	32.650	33.250 34.782	2.000	20.0	95.4
D31 D115	300	5.952	67.7	0.013	0.96	0.047	34.954	0.00	0.016	34.970	5.000	0.234	35.203	35.366	33.990	34.170	33.690	33.870	3.024	67.7	239.
D31 EOS	300	5.530	43.0	0.013	0.61	0.019	34.954	0.00	0.006	34.960	0.500	0.009	34.970	35.602	33.820	34.442	33.520	34.142	11.254	43.0	468
EOS D111	750	41.316	2455.8	0.013	5.41	1.495	37.338	0.02	1.021	39.198	0.500	0.748	39.945	51.343	34.931	39.517	34.171	38.757	11.098	2455.8	5253
D43 D44	300	25.507	214.2	0.013	3.03	0.468	40.741	0.02	0.618	41.360	0.721	0.338	41.697	41.273	39.510	39.990	39.210	39.690	1.882	214.2	188.
D43 D43A EOS JOIN	300	7.000 3.778	37.8 43.0	0.013	0.54	0.015	40.741 34.970	0.00	0.006	40.748 34.974	0.000	0.073	40.821 34.974	40.412 36.015	39.480 34.442	39.540 34.867	39.180 34.142	39.240 34.567	0.857 11.255	37.8 43.0	125. 468.
D111 D112	750	45.021	2422.7	0.013	5.34	1.455	39.945	0.02	1.083	44.728	0.500	0.728	45.455	52.146	39.690	45.060	38.930	44.300	11.928	2422.7	5448
D44 D45	300	33.685	184.2	0.013	2.61	0.346	41.273	0.02	0.609	41.883	1.297	0.449	42.332	41.976	40.040	40.660	39.740	40.360	1.841	184.2	185.
JOIN JOIN	300	9.355	43.1	0.013	0.61	0.019	34.974	0.00	0.011	35.694	0.000	0.000	35.694	36.899	34.867	35.920	34.567	35.620	11.255	43.1	468
D112 D113	750	43.950	2398.3	0.013	5.29	1.426	45.455	0.02	1.037	49.578	1.056	1.505	51.082	52.670	45.140	49.900	44.380	49.140	10.830	2398.3	5189
D45 D46 D45 D45A	300	56.315 7.889	87.3 57.0	0.013	0.81	0.078	41.976	0.00	0.243	42.219 41.991	1.897 5.000	0.148	42.366 42.157	43.151 41.872	40.710	41.870	40.410	41.570	2.060 0.634	87.3 57.0	196. 106.
JOIN D34	300	18.473	43.3	0.013	0.61	0.019	35.694	0.00	0.013	37.773	1.276	0.024	37.798	39.252	35.920	37.999	35.620	37.699	11.255	43.3	468
D113 D114	750	44.939	2008.8	0.013	4.43	1.000	51.082	0.02	0.749	51.948	2.543	2.544	54.490	53.173	49.980	52.202	49.220	51.442	4.944	2008.8	3491
D46 D47	300	27.238	34.0	0.013	0.48	0.012	42.366	0.00	0.020	42.386	5.000	0.059	42.445	43.509	41.920	42.280	41.620	41.980	1.322	34.0	156.
D34 D35	300	30.116	21.2	0.013	0.30	0.005	37.800	0.00	0.009	41.670	1.000	0.005	41.675	43.421	38.050	41.920	37.750	41.620	12.850	21.2	501.
D34 D34A D35 D36	300	7.287 9.624	12.6 12.7	0.013	0.18	0.002	37.807 41.730	0.00	0.001	38.007 41.950	5.000	0.008	38.015 41.958	39.355 43.576	38.050 41.970	38.250 42.190	37.750 41.670	37.950 41.890	2.744	12.6 12.7	228.
000		7.024	12.1	LI 0.0	0.10	3.002	1.1.750	0.00	0.001	> 50	2.000	3,300	. 1.750		. 1.710	12.170	, 1.070	, 1.070	2.200	12.1	

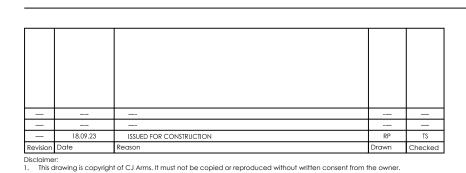

an appropriate level of experience who have prepared appropriate Safe Work Method Statements (SWMS) relating to these works. The contractor is responsible for the management of all risks associated with the construction activities stated on this drawing.

This drawing should not be issued in part and must be read in conjunction with all appropriate specifications, notes pages, details and authority drawings as appropriate.

Dial before you dig. BEWARE OF UNDERGROUND SERVICES. The location of underground services are approximate only and their exact position should be proven on site. No guarantee is given that existing services are shown.

Note for Contractors

The works described on this drawing must be undertaken by competent Contractors with

FOR CONSTRUCTION



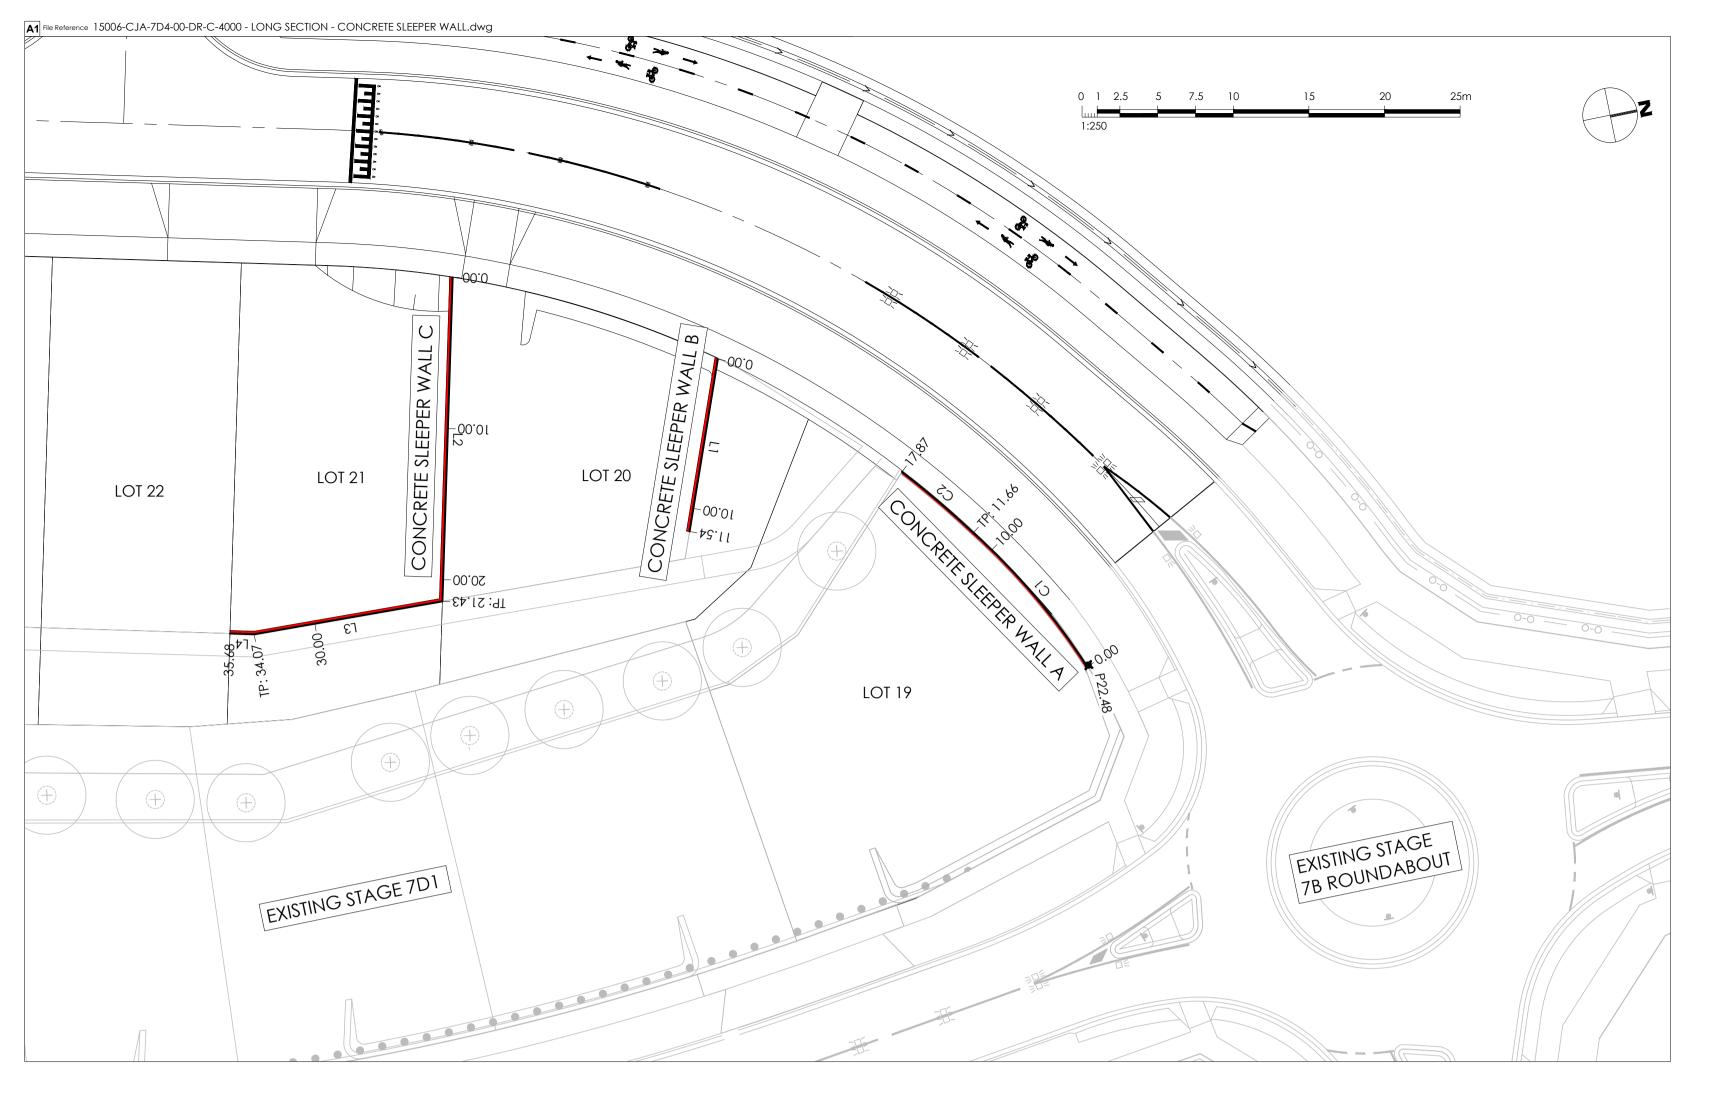


Project RIVER VALLEY - STAGE 7D4 Drawing Title HGL PIPE CAPACITY REPORT

Client YOURLAND Purpose of Issue
FOR CONSTRUCTION Checked By Drawn Scale Date of First Issue


www.cjarms.com

TS N/A @ A1 18.09.23 Number 2105 15006 CJA 7D4 XX DR C



Set Out Table for CONCRETE SLEEPER WALL A - BOW												
TAG		CHAINAGE	EASTING	NORTHING	LENGTH	RADIUS	BEARING					
C1	TP IP TP	0.00 5.87 11.66	310333.804 310328.331 310323.608	5819138.826 5819136.711 5819133.233	11.66	43.8	241° 15′ 04.10′					
C2	TP IP TP	11.66 14.77 17.87	310323.608 310321.070 310318.714	5819133.233 5819131.443 5819129.420	6.21	65.1	232° 04' 40.45'					

	Set Out Table for CONCRETE SLEEPER WALL B - BOW										
TAG		CHAINAGE	EASTING	NORTHING	LENGTH	RADIUS	BEARING				
L1	START END	0.00 11.54	310308.968 310319.750	5819118.983 5819114.859	11.54		110° 55′ 54″				

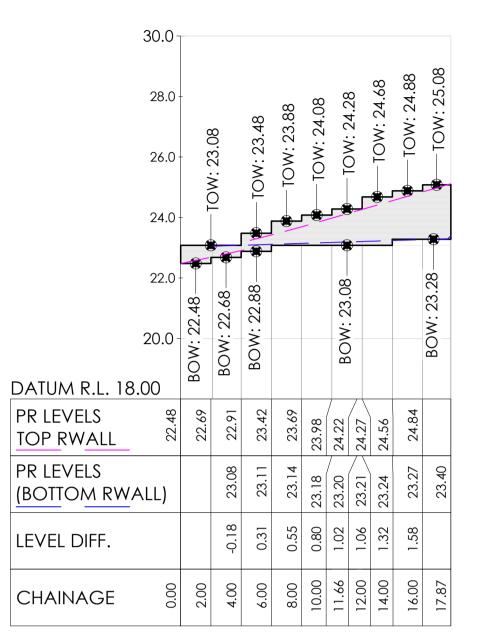


CONCRETE SLEEPER WALL A - BOW - LONG SECTION SCALES: HORIZONAL 1:250 VERTICAL 1:125 (2x)


34.0	-					
32.0	_		ON 00 MO	7.4.7		
30.0						
28.0					0	00:
26.0	00.	27.40	BOW: 27.80—	BOW: 28.20	BOW: 28.60	BOW: 29.00
24.0	BOW: 27.00	BOW: 27.40	BOW	BO	BC	
DATUM R.L. 22.00						
PR LEVELS 8.	29.35	29.36	29.37	29.38	29.39	29.40
PR LEVELS 8. (BOTTOM RWALL)	27.42	27.83	28.25	28.66	29.08	29.40
LEVEL DIFF.	1.93	1.53	1.12	0.72	0.31	
CHAINAGE 8	2.00	4.00	9.00	8.00	10.00	11.54


CONCRETE SLEEPER WALL B - BOW - LONG SECTION SCALES: HORIZONAL 1:250 VERTICAL 1:125 (2x)

	Set	Out Table	for CONC	RETE SLEEP	ER WALI	C - BO	W
TAG		CHAINAGE	EASTING	NORTHING	LENGTH	RADIUS	BEARIN
L2	START END	0.00 21.43	310300.130 310320.978	5819102.901 5819097.923	21.43		103° 25′ 5
L3	START END	21.43 34.07	310320.978 310320.605	5819097.923 5819085.291	12.64		181° 41′ 18
L4	START END	34.07 35.68	310320.605 310320.234	5819085.291 5819083.731	1.60		193° 22′ 23
			,				
			2			35	
I	30.95		31.13			31.3	

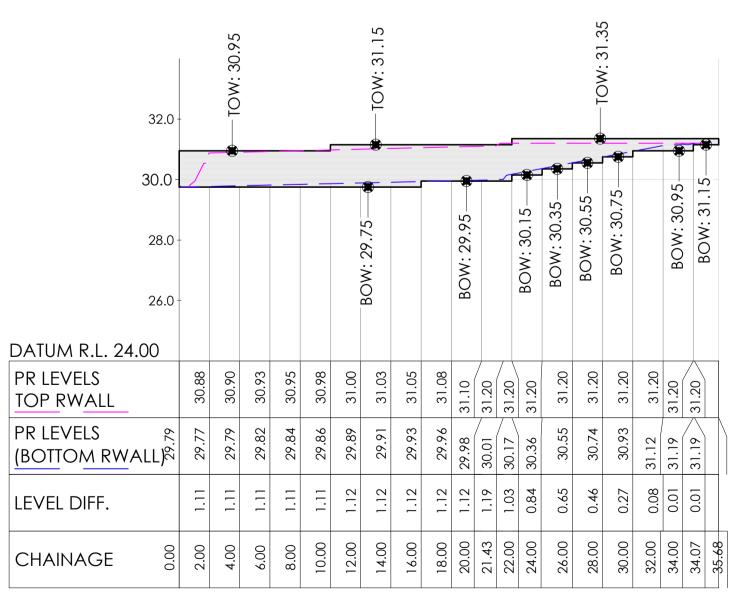

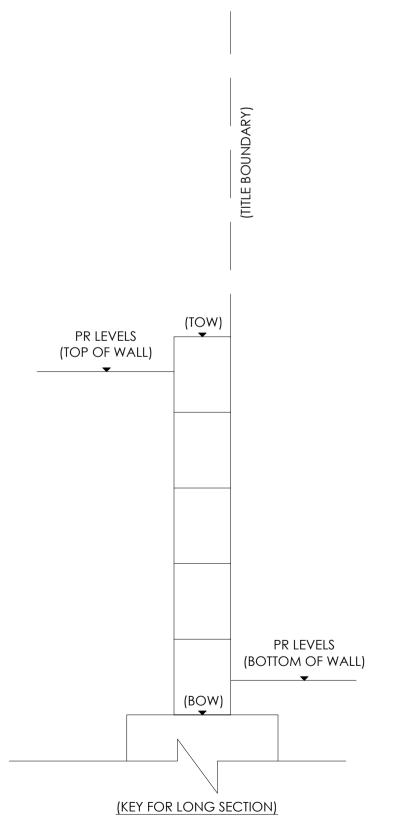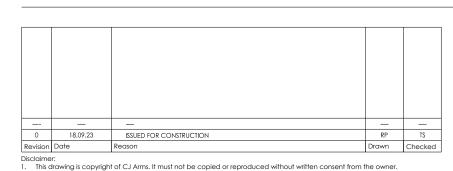CONCRETE SLEEPER WALL C - BOW - LONG SECTION SCALES: HORIZONAL 1:250 VERTICAL 1:125 (2x)





Note for Contractors

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RETAINING WALL SECTIONS ARE PROVIDED BY CJ ARMS TO REPRESENT THE PROPOSED GROUND LEVEL AT THE TOP AND BOTTOM OF RETAINING WALLS.

THE CONTRACTOR IS TO DETERMINE OPTIMAL CONCRETE SLEEPER HEIGHT/POST SPACING AND ASSOCIATED FOUNDATIONS TO ACHIEVE THE PROPOSED GROUND LEVELS SHOWN BY CJA.

FOR CONSTRUCTION

REFER TO DRAWING C-8021 FOR RETAINING WALL DETAILS.





•		A	
		Λ	
J			


CIVIL SITEWORKS MELBOURNE SYDNEY
T: +61 3 9285 2800 | T: +61 2 8036 8370 | E: info@cjarms.com | W: www.cjarms.com Project RIVER VALLEY - STAGE 7D4 Drawing Title
LONG SECTION - CONCRETE SLEEPER WALL (SHEET 1 OF 3) YOURLAND

FOR CONSTRUCTION AS NOTED @ A1 18.09.23 DR 4000 15006 CJA 7D4


Set Out Table for CONCRETE SLEEPER WALL D - BOW											
TAG		CHAINAGE	EASTING	NORTHING	LENGTH	RADIUS	BEARING				
С3	TP IP TP	0.00 2.06 4.13	310309.415 310307.405 310305.405	5818849.632 5818850.102 5818850.614	4.13	198.0	283° 45' 28.63"				
C4	TP IP TP	4.13 15.70 27.24	310305.405 310294.197 310283.400	5818850.614 5818853.482 5818857.636	23.11	198.0	287° 41' 56.89"				
L5	START END	27.24 31.81	310283.400 310279.135	5818857.636 5818859.277	4.57		291° 02′ 35″				

30.0 - 28.0										1.54	24.94	TOW: 25.14			TOW: 25.34		
26.0	_					4	7	4/.1.	TOW: 23.34	TOW: 24.54	——TOW: 24.94	TOW:		_	WOT —		
24.0	-		TOW: 20.34			-TOW: 20.94	() () () () () () () () () ()	47.12 :V4	*/			<u> </u>	3.54				3.54
20.0				*	-	*	4	34	BOW: 21.34	BOW: 22.54			BOW: 23.54				BOW: 23.54
18.0 ·		BOW: 18.74—		BOW: 19.14—	BOW: 19.74		BOW: 20.14	BOW: 20.34	BOW								
DATUM R.L. 14.00								10			~	10					
PR LEVELS TOP RWALL	18.78	18.82	10.01	19.82	20.24	20.93	21.64	21.75	23.26	24.72	24.93	25.15	25.21	70.70	72.24	25.24	
PR LEVELS (BOTTOM RWALL)	20.29	20.23	00.00	20.30	20.30	20.30	20.36	21.29	22.37	23.51	23.60	23.57	23.59	0 > 00	73.67	25.24	
LEVEL DIFF.	-1.51	-1.41	-1.42	-0.47	-0.06	0.63	1.27	0.46	0.89	1.21	1.33	1.58	1.61	1.62	1.55	0.00	
CHAINAGE 8	2.00	4.00	4.13	8.00	10.00	12.00	14.00	16.00	18.00	20.00	22.00	24.00	26.00	27.25	28.00	30.00	31.79

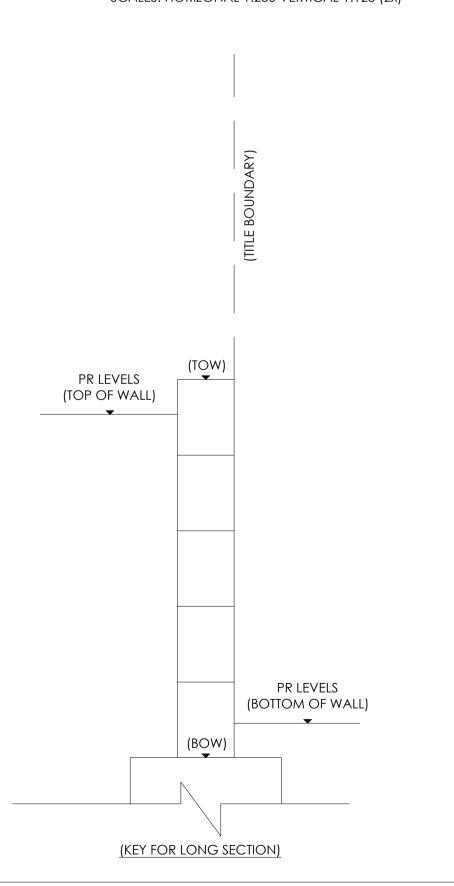
CONCRETE SLEEPER WALL D - BOW - LONG SECTION SCALES: HORIZONAL 1:250 VERTICAL 1:125 (2x)




Set Out Table for CONCRETE SLEEPER WALL E - BOW											
TAG		CHAINAGE	EASTING	NORTHING	LENGTH	RADIUS	BEARING				
L6	START END	0.00 7.23	310214.421 310207.993	5818853.033 5818856.332	7.23		297° 10′ 02				
L7	START END	7.23 14.43	310207.993 310211.281	5818856.332 5818862.739	7.20		027° 10′ 04				

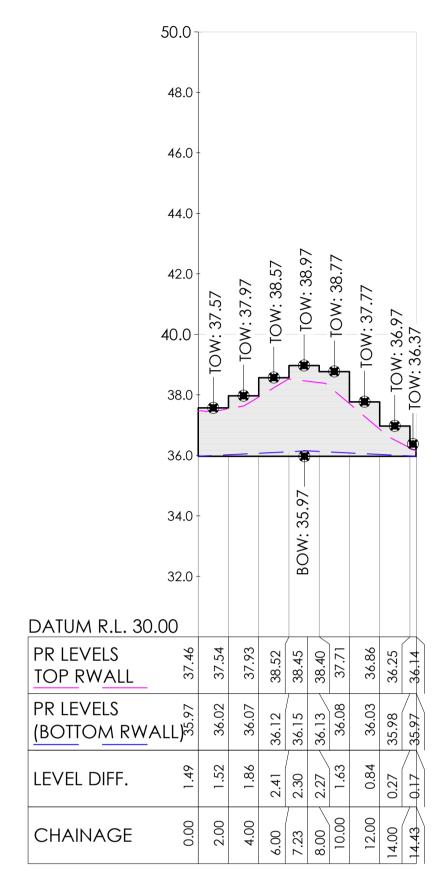

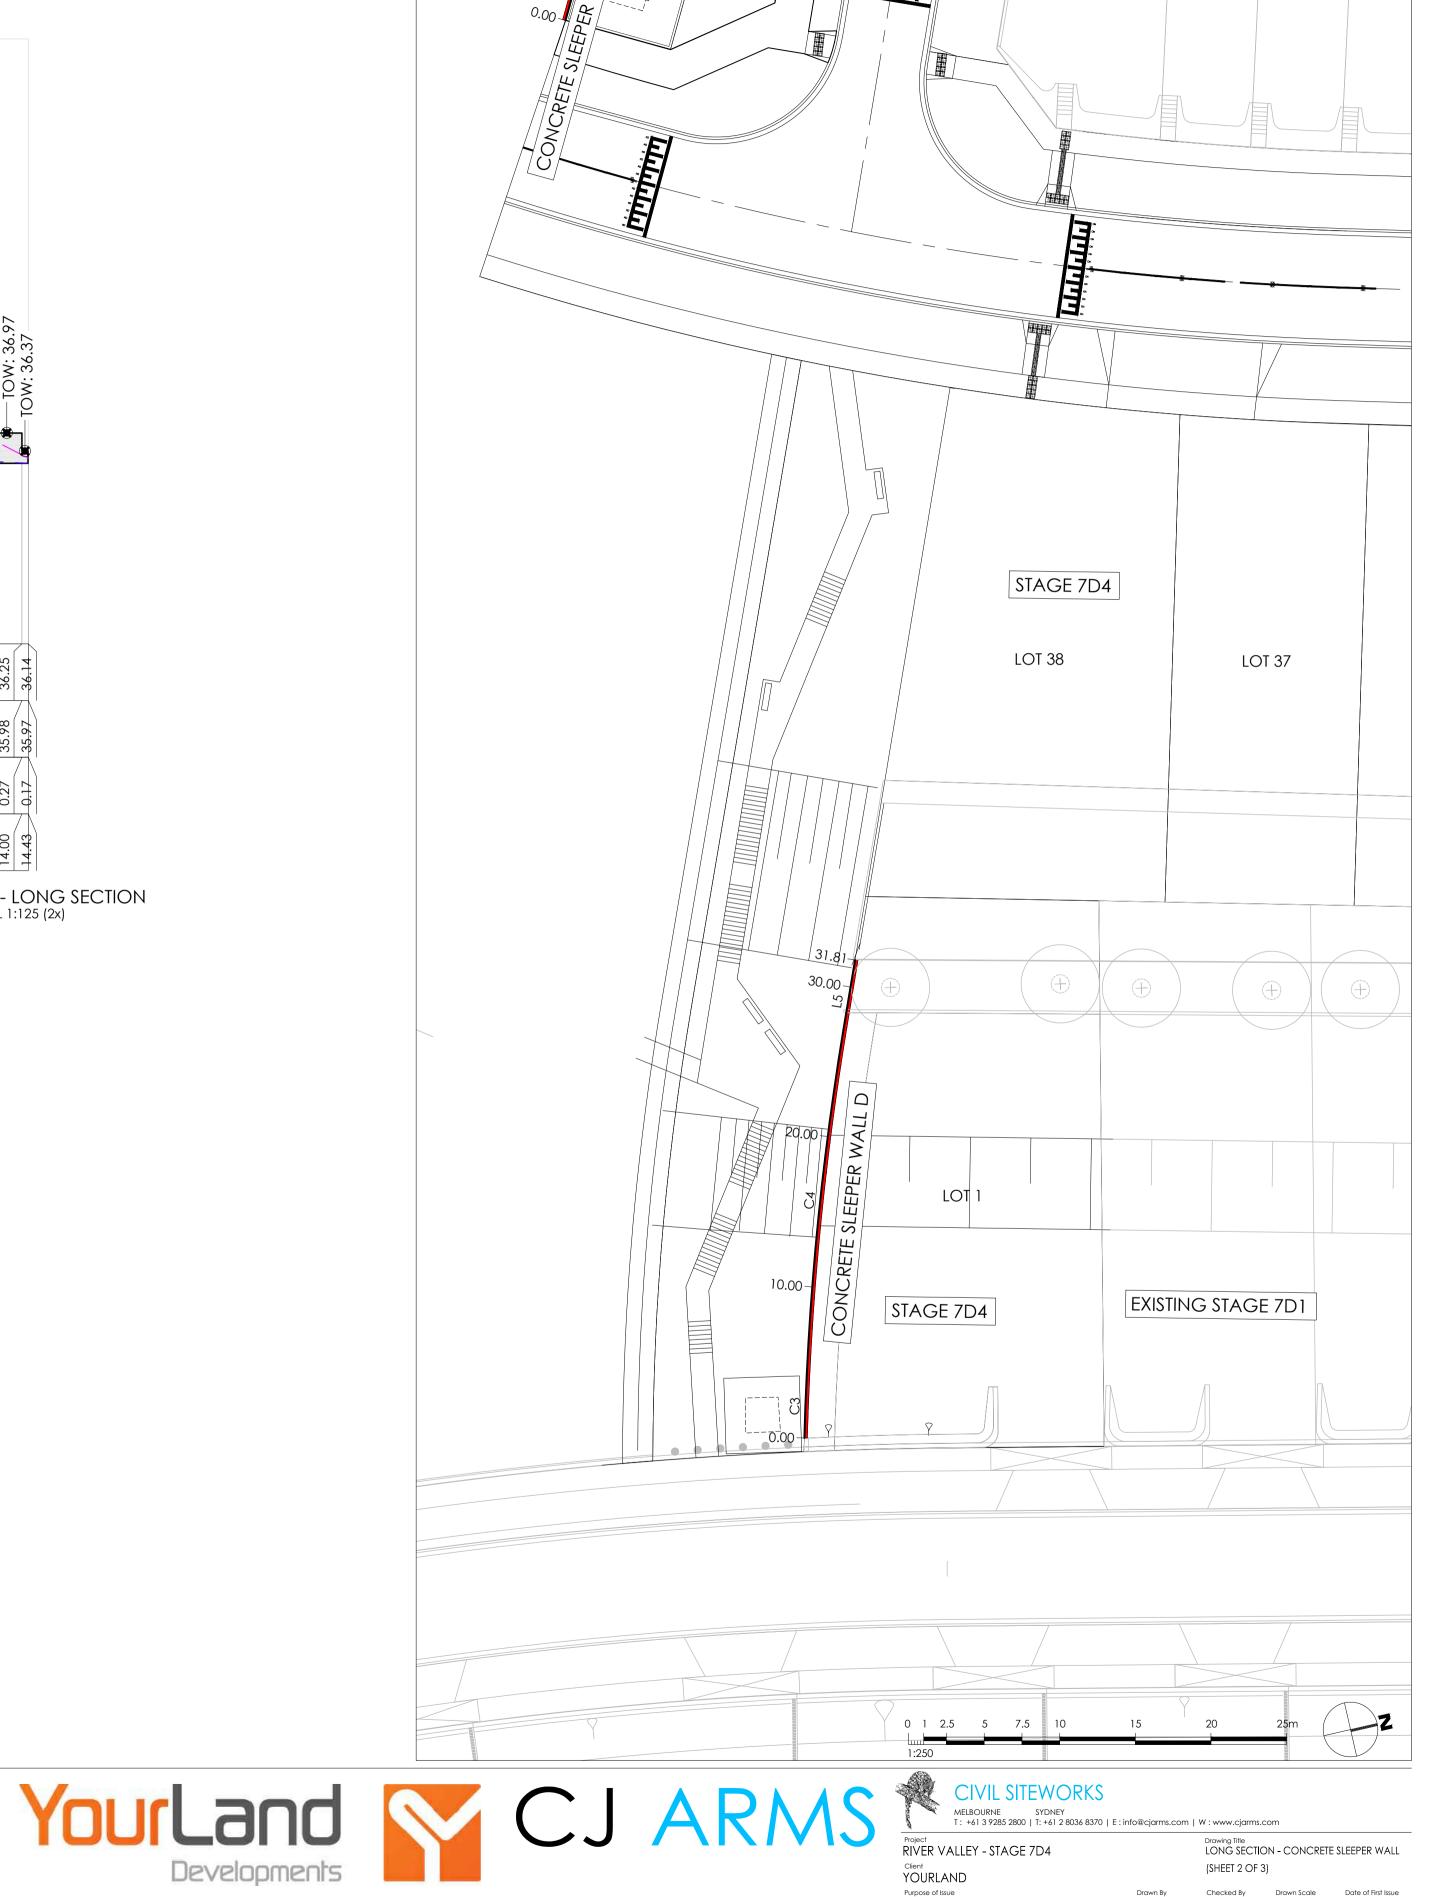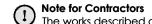CONCRETE SLEEPER WALL E - BOW - LONG SECTION SCALES: HORIZONAL 1:250 VERTICAL 1:125 (2x)





drawing.

 0
 18.09.23
 ISSUED FOR CONSTRUCTION

 Revision
 Date
 Reason

Note for Contractors

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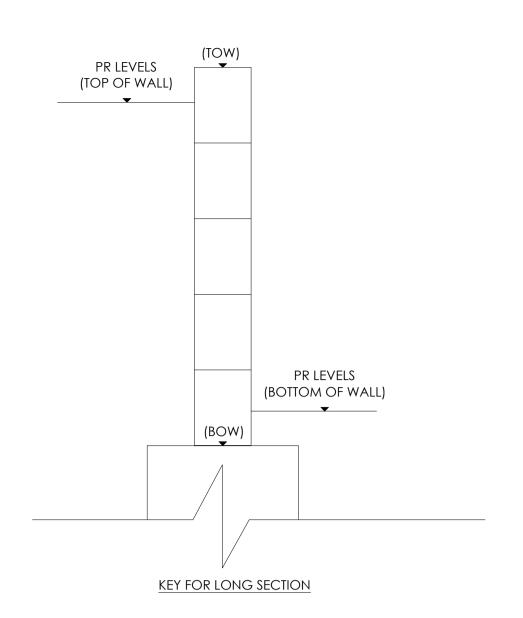
REFER TO DRAWING C-8021 FOR RETAINING WALL DETAILS.




FUTURE STAGE 7D2


LOT 39

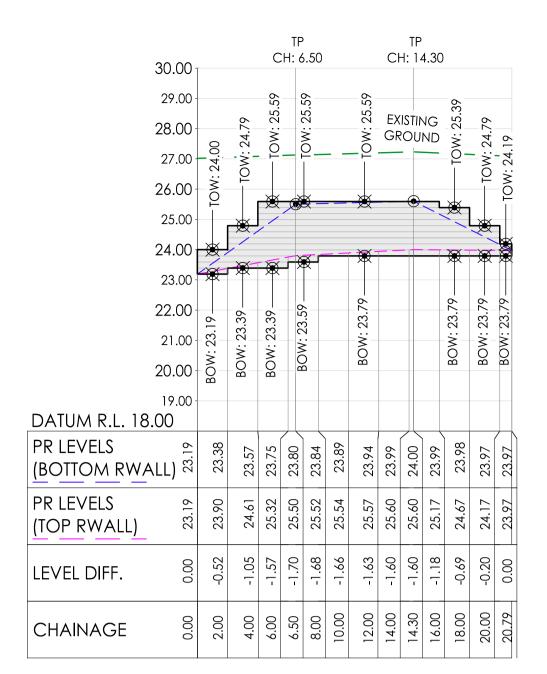
LOT 41 LOT 4





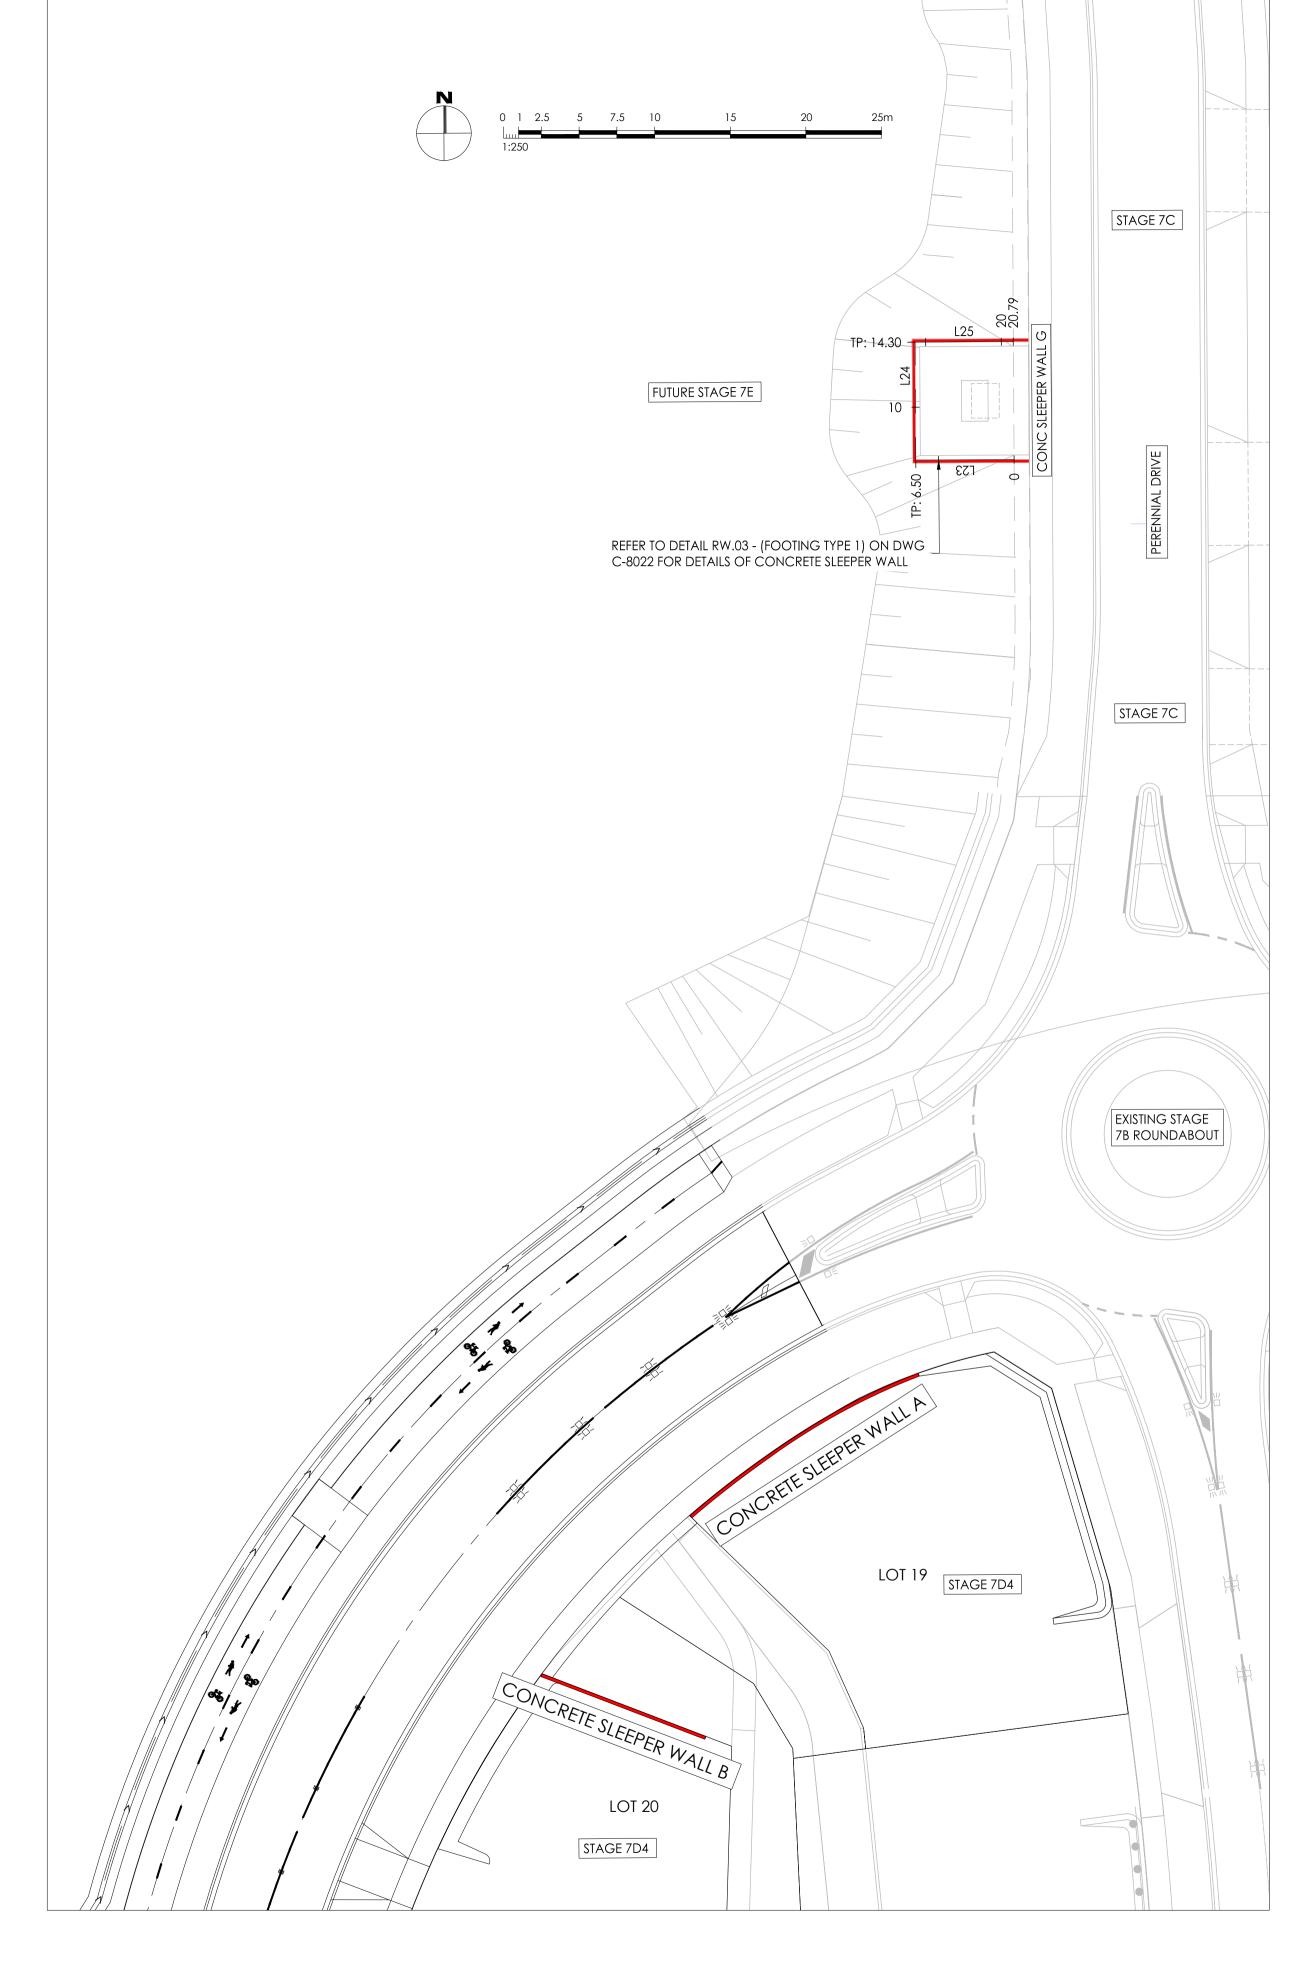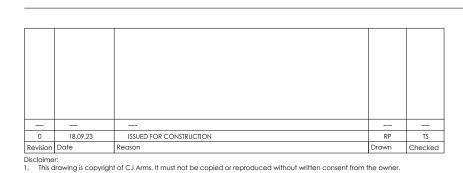CONCRETE SLEEPER WALL G - BOW - LONG SECTION SCALES: HORIZONAL 1:250 VERTICAL 1:125 (2x)





Note for Contractors

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REFER TO C-8021 FOR CONSTRUCTION DETAILS

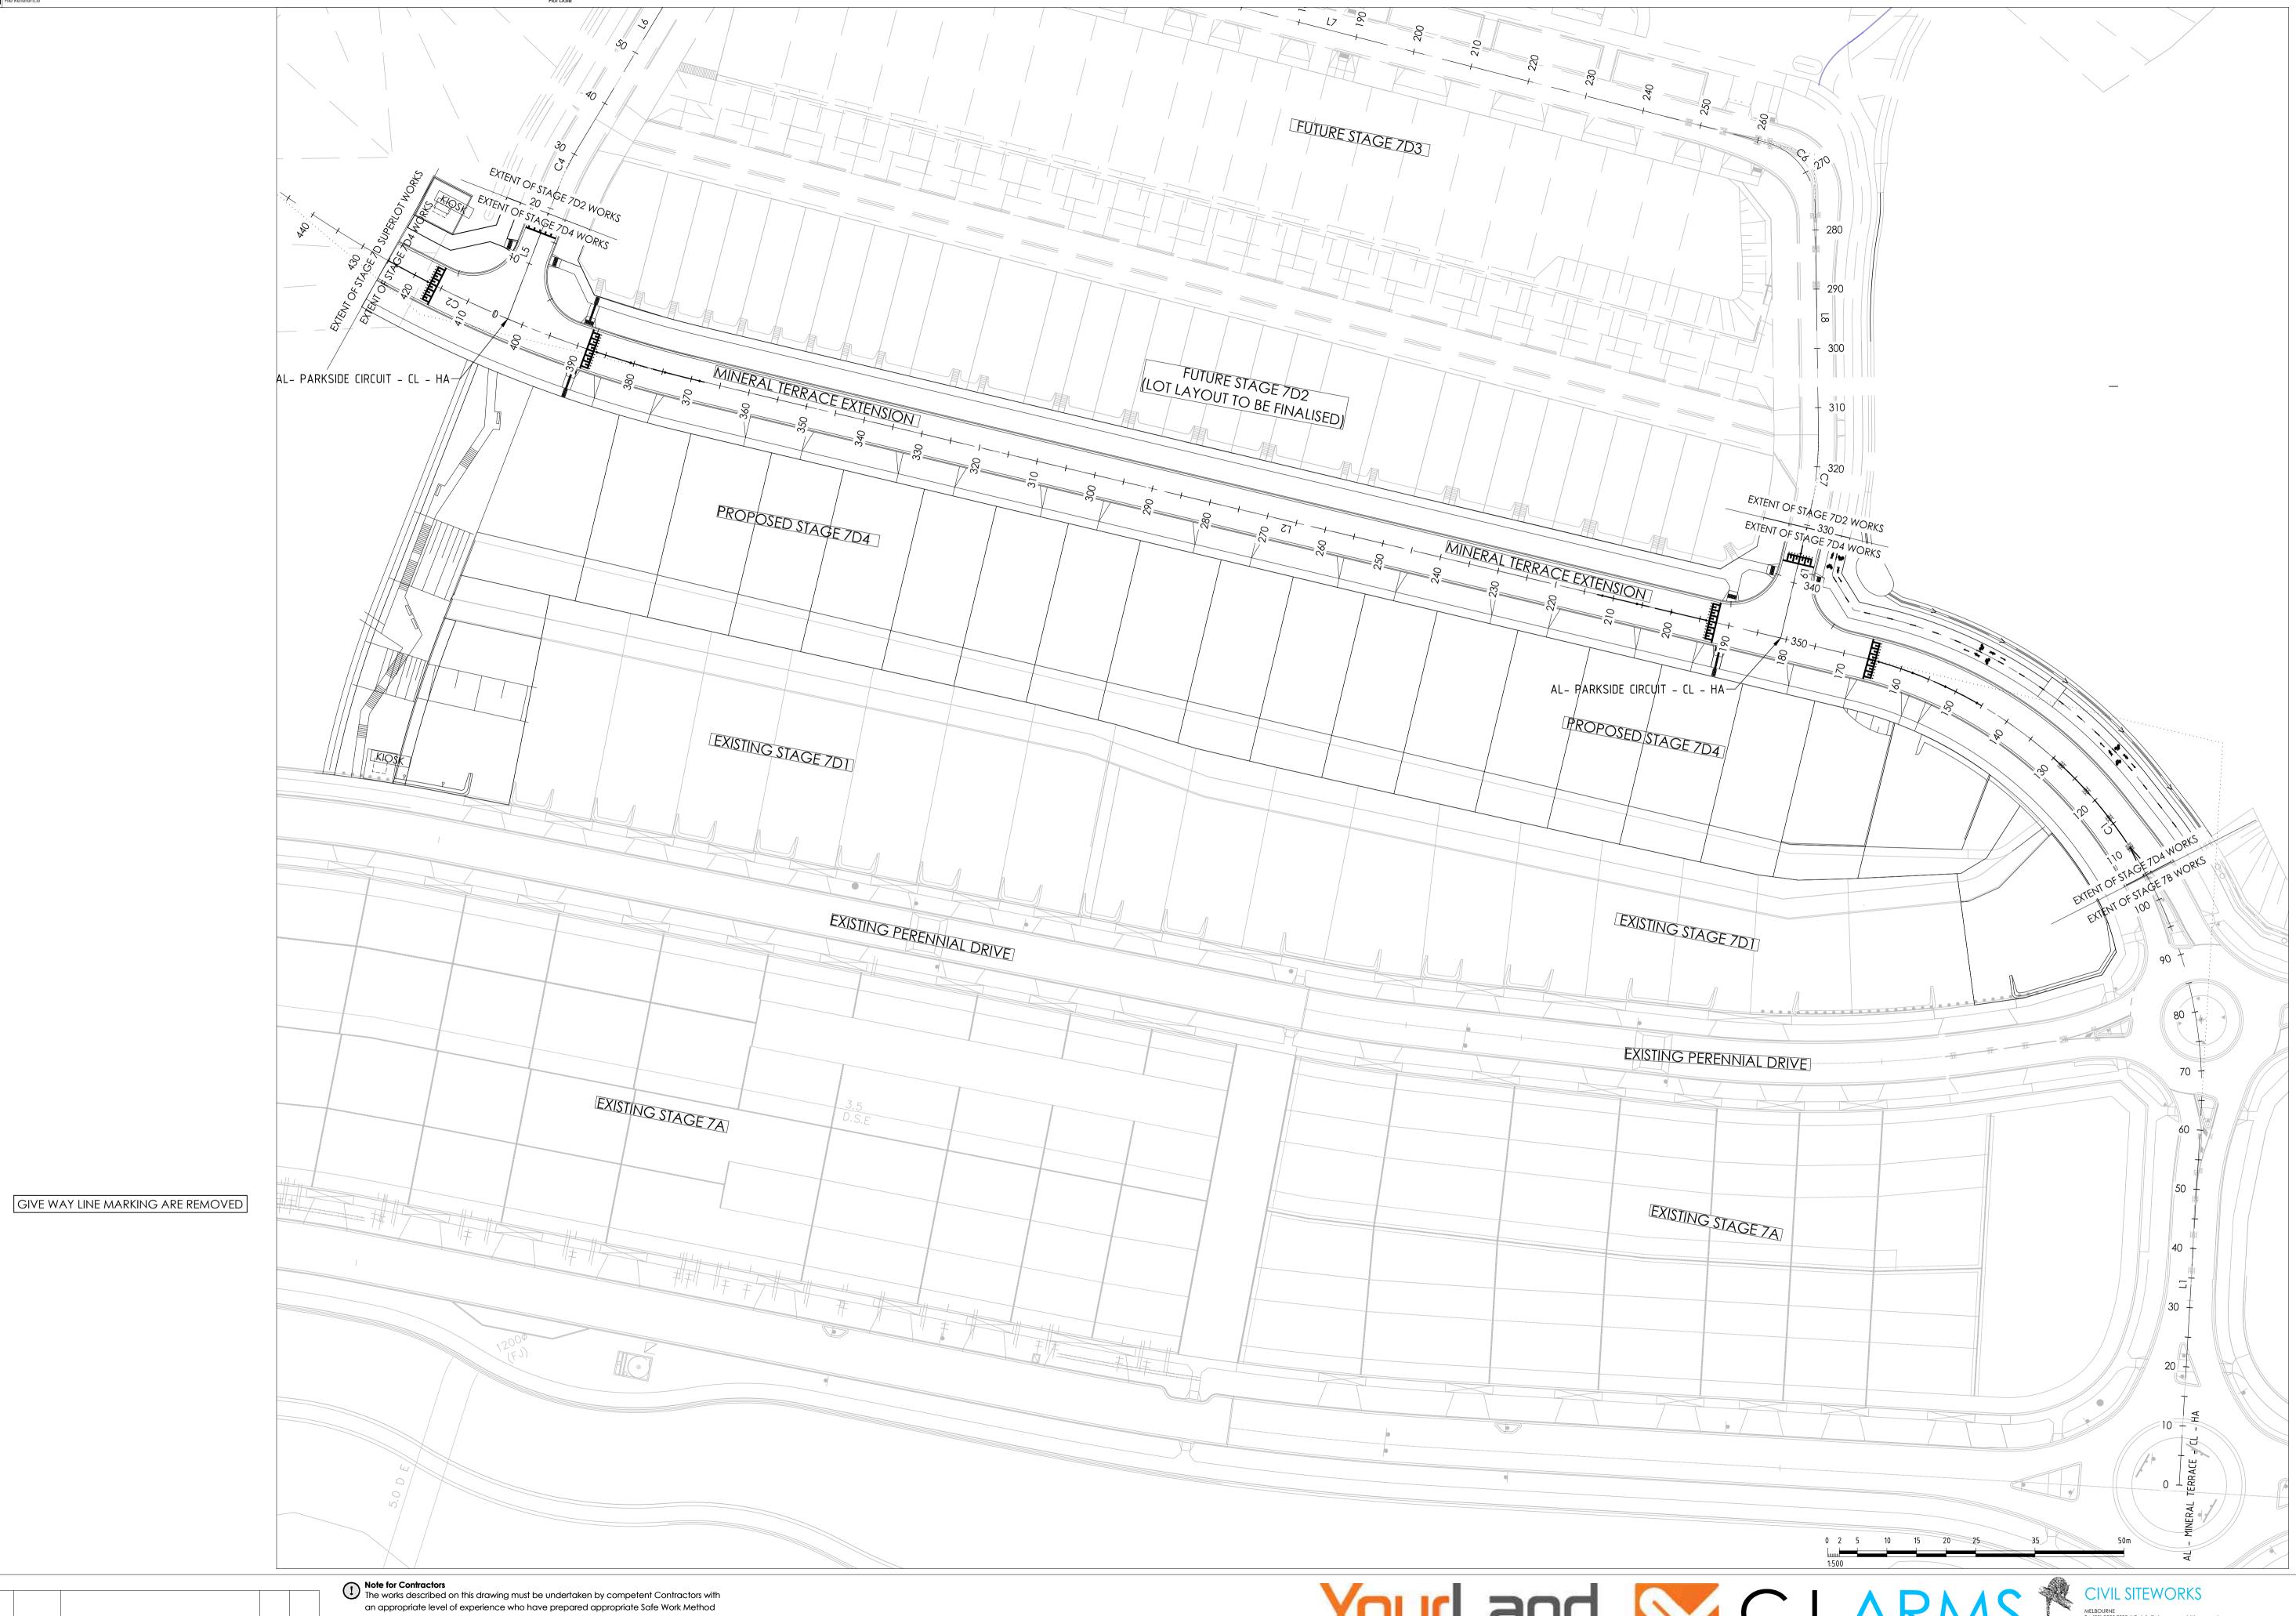
FOR CONSTRUCTION







Project RIVER VALLEY - STAGE 7D4 Client YOURLAND Purpose of Issue Drawing Title
LONG SECTION - CONCRETE SLEEPER WALL (SHEET 3 OF 3) FOR CONSTRUCTION AS SHOWN @ A1 18.09.23 15006 CJA 7D4 XX DR 4002



Statements (SWMS) relating to these works. The contractor is responsible for the management of all risks associated with the construction activities stated on this drawing.

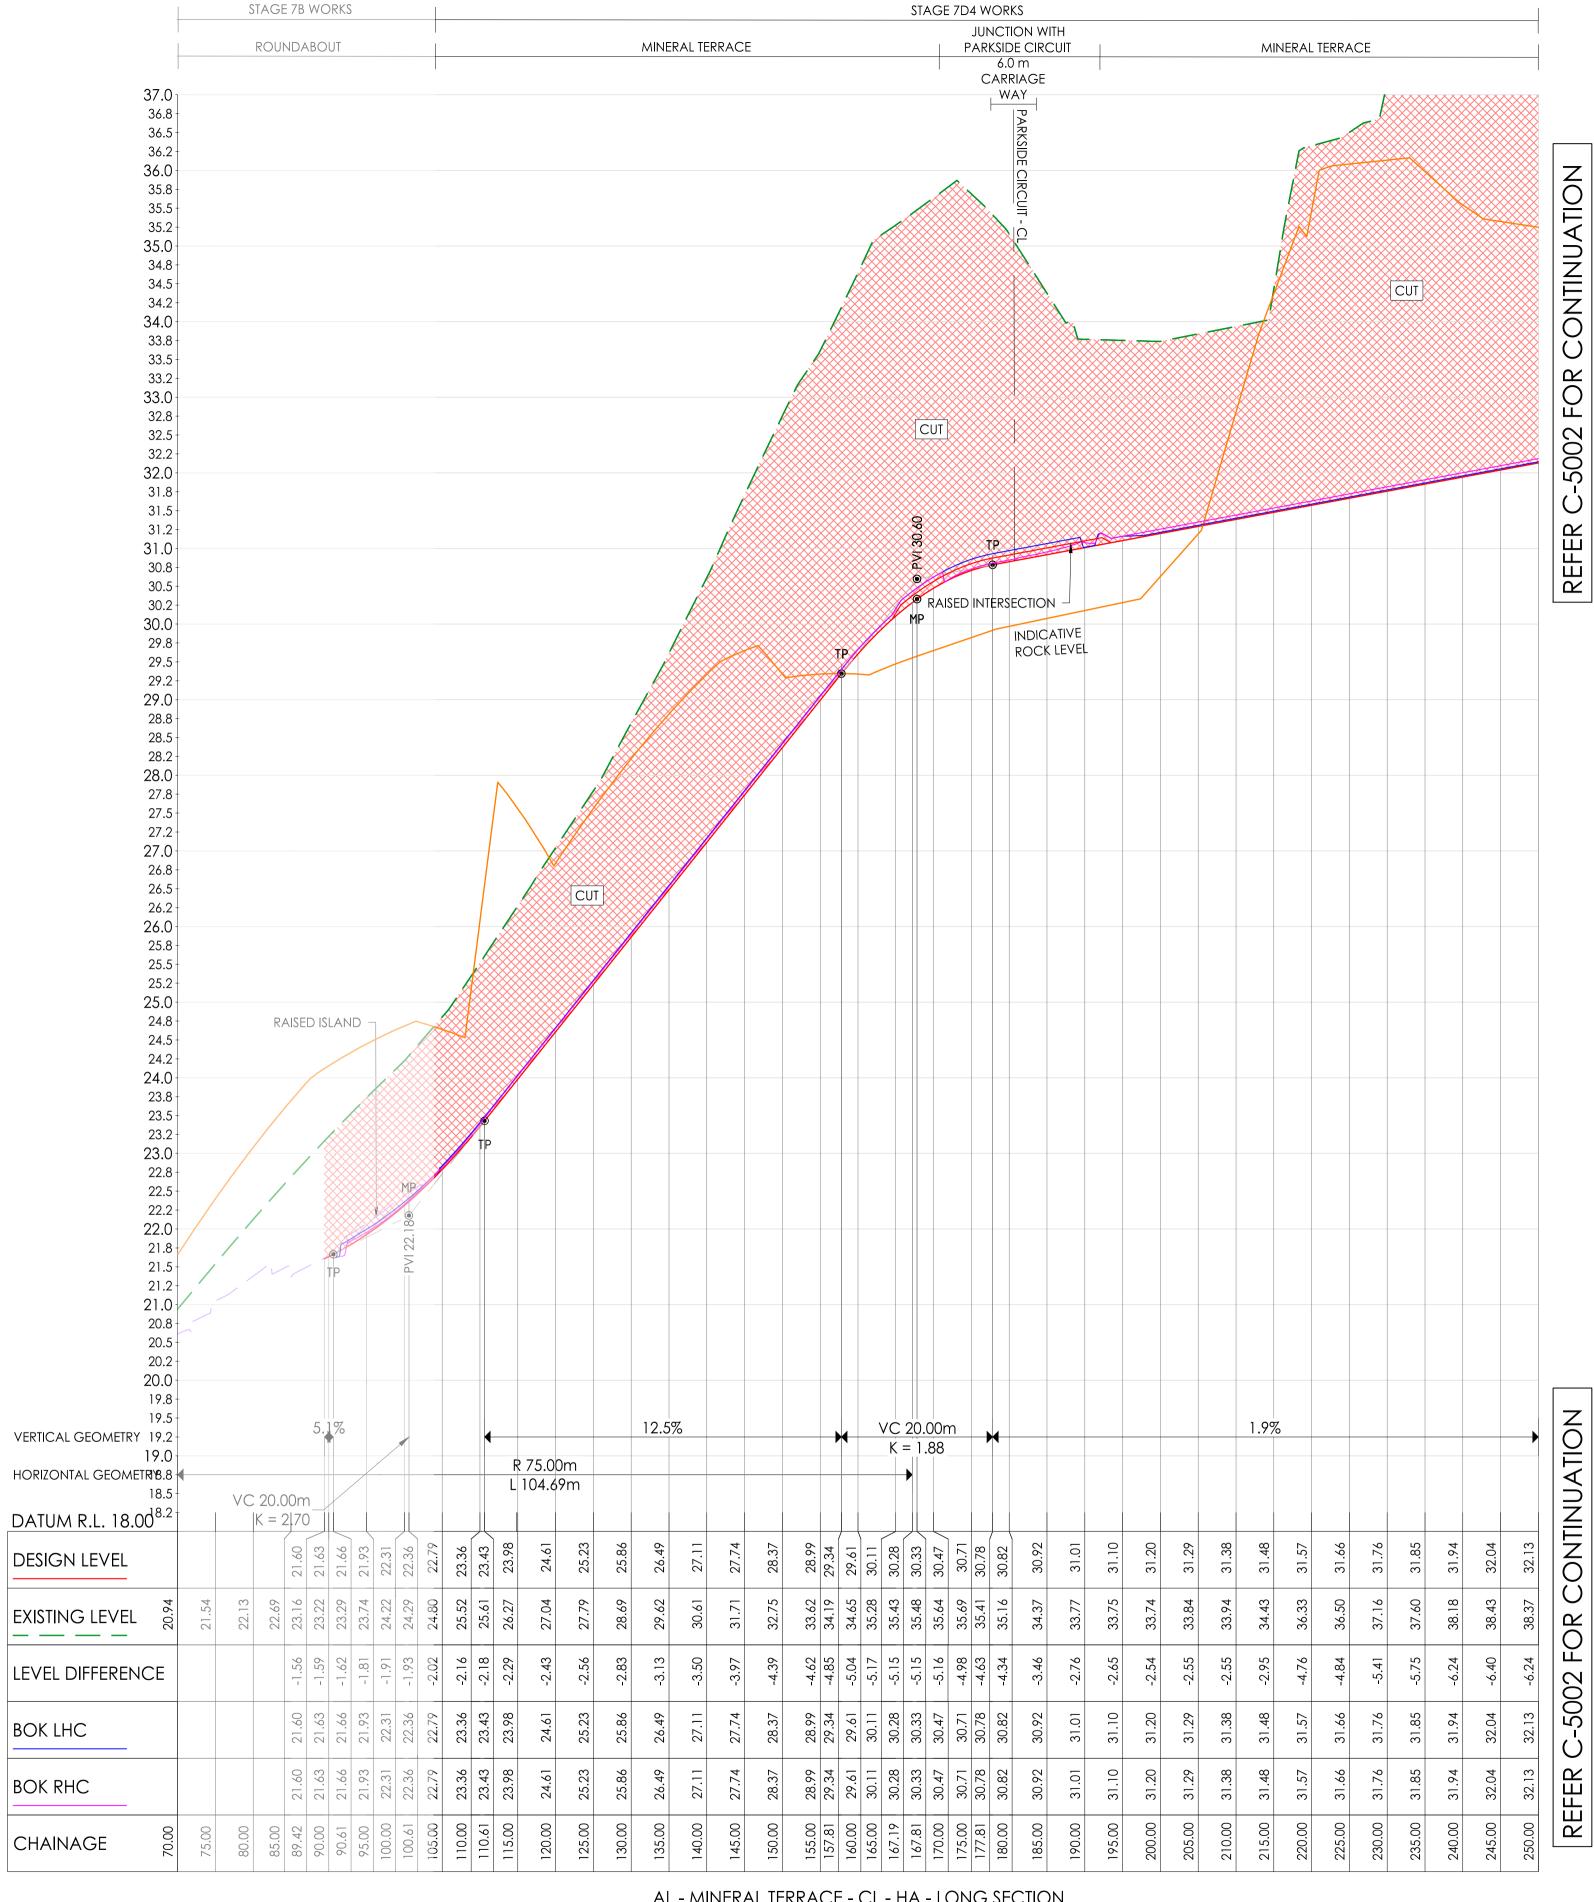
This drawing should not be issued in part and must be read in conjunction with all appropriate specifications, notes pages, details and authority drawings as appropriate.

Dial before you dig. BEWARE OF UNDERGROUND SERVICES. The location of underground services are approximate only and their exact position should be proven on site. No guarantee is given that existing services are shown.

FOR CONSTRUCTION



Project RIVER VALLEY - STAGE 7D4



Set Out Table for A											
TAG		CHAINAGE	EASTIN								
L1	START END	0.00 62.50	310428.7 310366.3								
C1	TP IP TP	62.50 125.41 167.19	310366.3 310303.5 310288.9								
		–									

LONG SECTION ARE NOW **REPORTED IN 5m INTERVALS.**

AL - MINERAL TERRACE - CL - HA - LONG SECTION SCALES: HORIZONAL 1:500 VERTICAL 1:50 (10x)

	_	_	_	
	_	_	_	_
	_	_	_	_
	_	_	_	_
	_	_		
0	18.09.23	ISSUED FOR CONSTRUCTION	RP	TS
Povision	Date	Pegson	Drawn	Chackad

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Dial before you dig. BEWARE OF UNDERGROUND SERVICES. The location of underground bidi before you aig. BEWARE OF UNDERGROUND SERVICES. The location of underground services are approximate only and their exact position should be proven on site. No guarantee is given that existing services are shown.

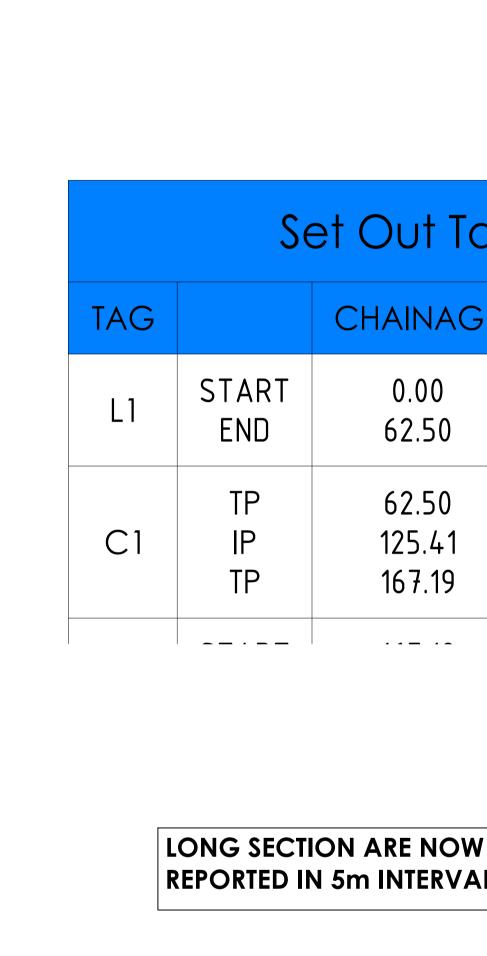


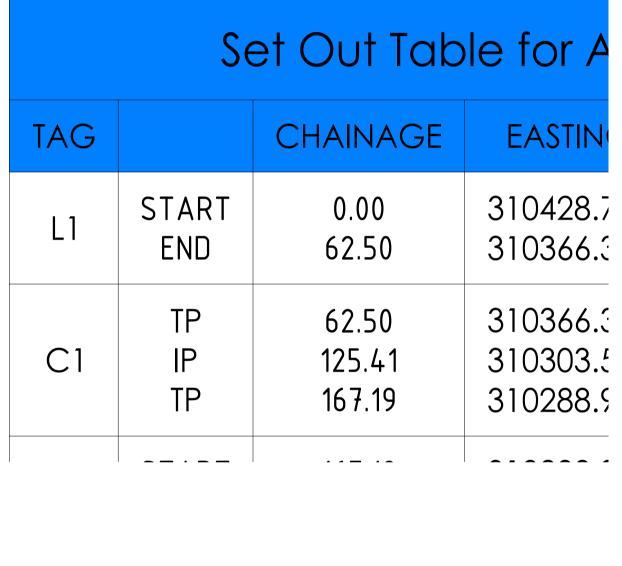







Project RIVER VALLEY - STAGE 7D4 Drawing Title
ROAD LONG SECTION Client
YOURLAND
Purpose of Issue (SHEET 2 OF 4) FOR CONSTRUCTION 1:500H, 1:50V @ A1 18.09.23 Zone 7D4 Level XX 15006 CJA DR 5001





REPORTED IN 5m INTERVALS.

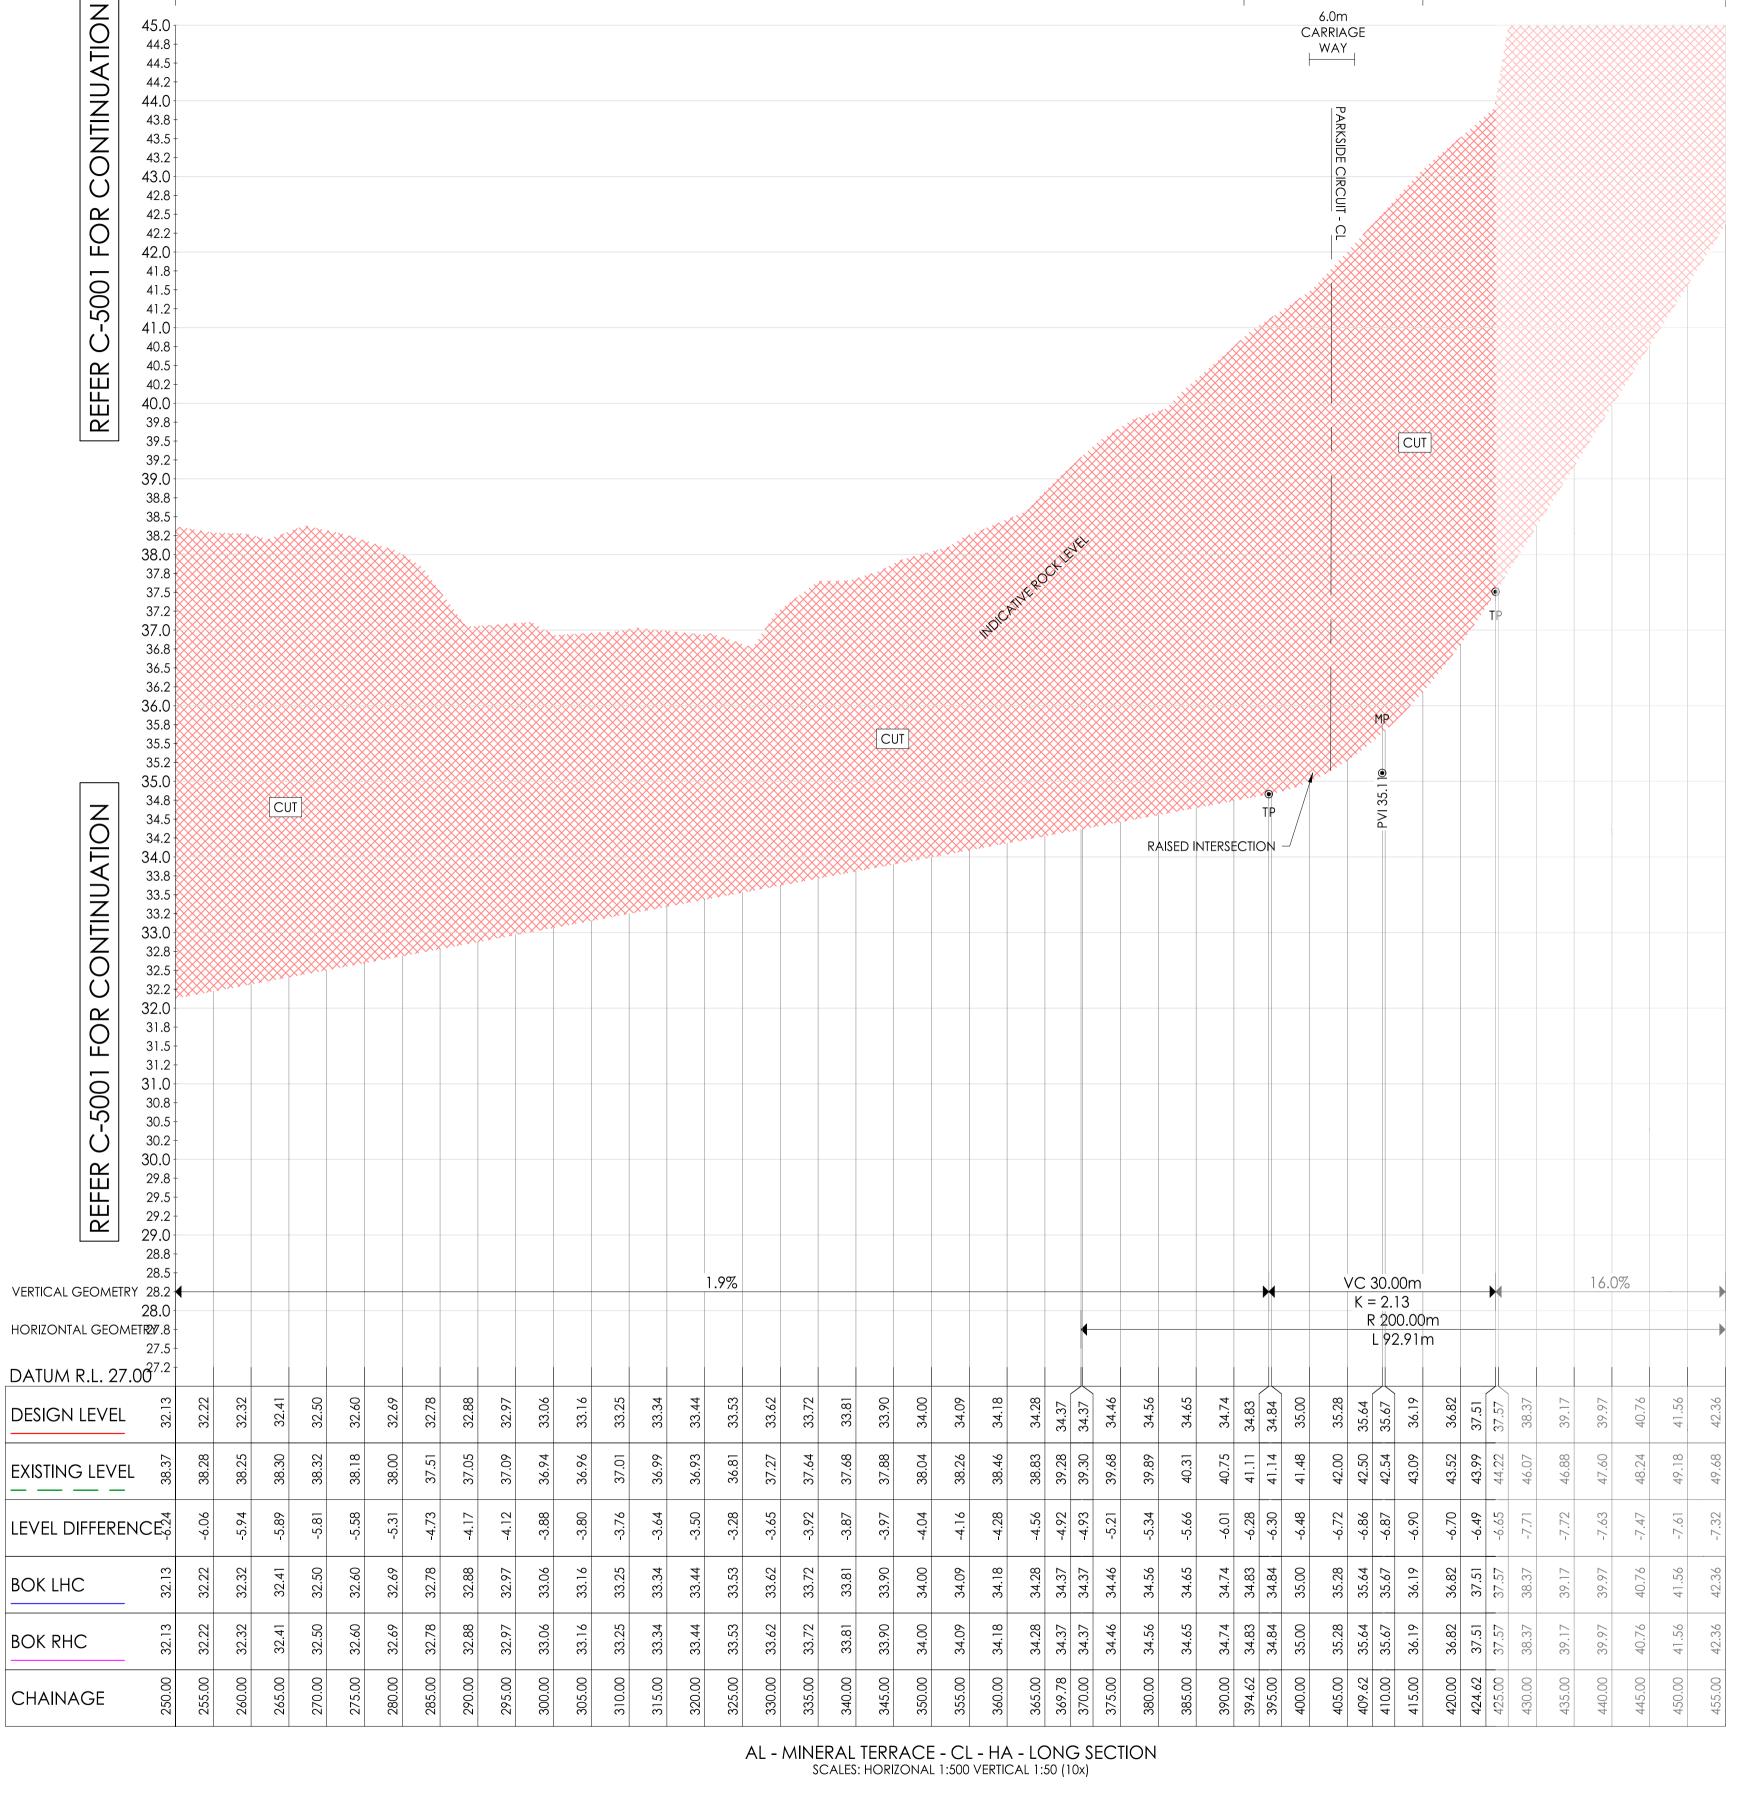

STAGE 7D4

MINERAL TERRACE

18.09.23 ISSUED FOR CONSTRUCTION
On Date Reason

Note for Contractors

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DENOTES EXTENT OF CUT (AS PART OF EARLY WORKS)







FUTURE STAGE 7D SUPER LOT WORKS

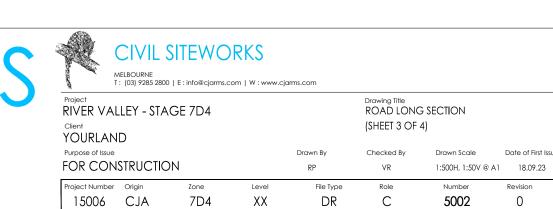
MINERAL TERRACE

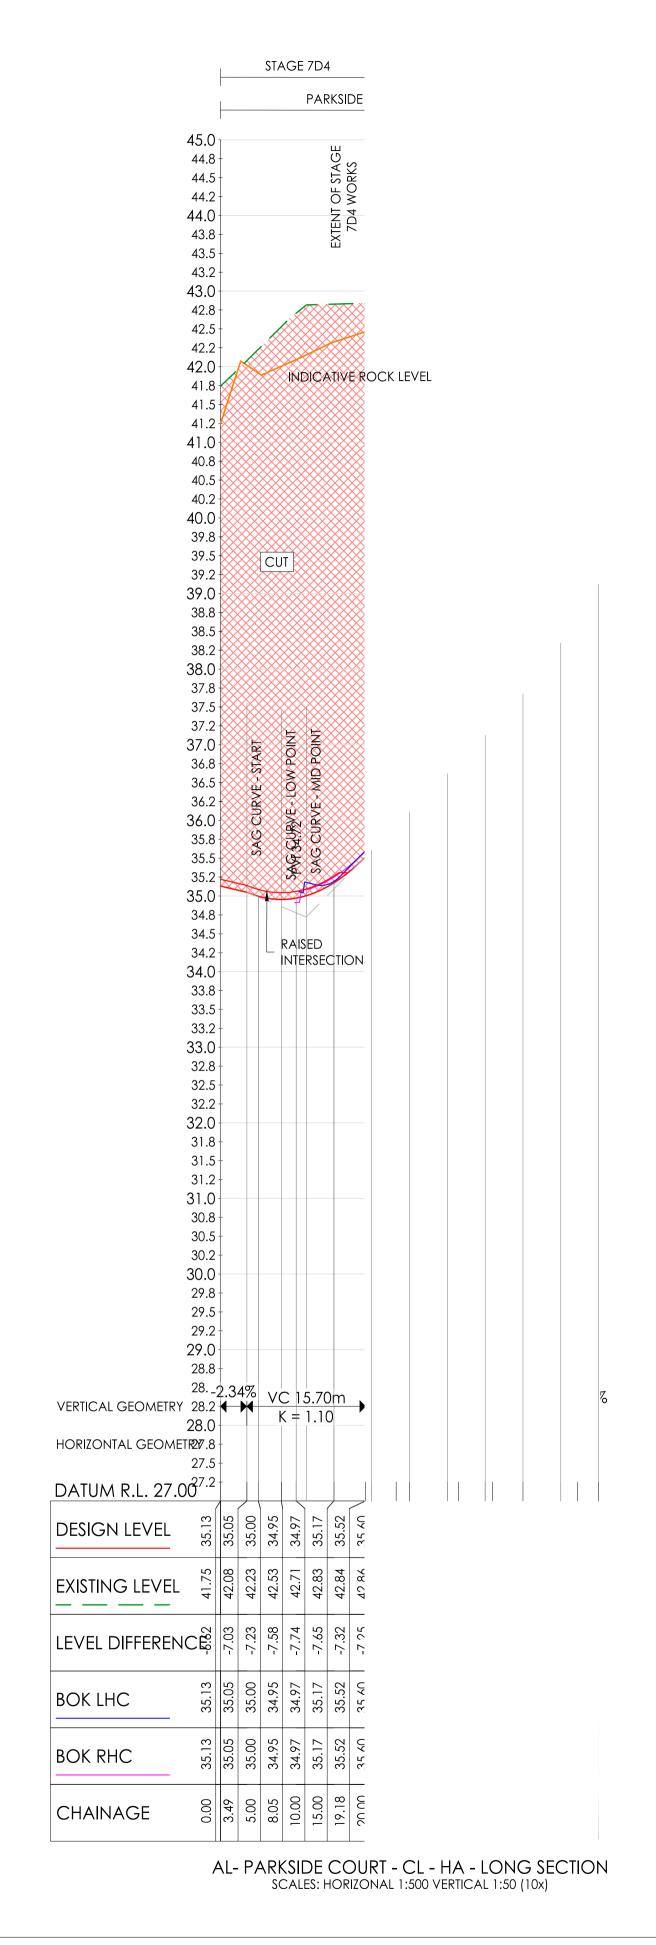
JUNCTION WITH

PARKSIDE CIRCUIT

6.0m CARRIAGE

WAY





STAGE 7D4 PARKSIDE CIRCUIT 45.0 44.8 44.5 44.0 43.8 43.5 43.2 43.0 42.8 42.5 42.2 42.0 41.8 41.2 41.0 40.8 40.5 40.2 40.0 39.8 39.5 39.2 39.0 38.8 38.5 38.2 38.0 37.8 37.5 37.2 37.0 36.8 36.5 36.2 36.0 35.8 35.5 35.2 35.0 34.8 34.5 34.2 34.0 33.8 CUT 33.5 33.2 -33.0 -32.8 -32.2 32.0 31.8 31.5 31.2 31.0 30.8 **RAISED** 30.5 INTERSECTION 30.2 30.0 29.8 29.5 29.2 29.0 28.8 VERTICAL GEOMETRY 28.2 28.0 HORIZONTAL GEOMETR27.8 27.5 DATUM R.L. 27.06^{77.2} DESIGN LEVEL 34.59 34.48 34.33 34.31 EXISTING LEVEL _ _ _ _ LEVEL DIFFERENCE BOK LHC BOK RHC CHAINAGE AL- PARKSIDE COURT - CL - HA - LONG SECTION SCALES: HORIZONAL 1:500 VERTICAL 1:50 (10x)

Set Out Table for AL- PARKSIDE COURT - CL - HA											
TAG		CHAINAGE	EASTING	NORTHING	LENGTH	RADIUS	BEARING				
L5	START END	0.00 23.22	310231.920 310210.254	5818868.763 5818877.112	23.22		291° 04′ 26″				
C4	TP IP TP	23.22 27.35 31.45	310210.254 310206.403 310202.868	5818877.112 5818878.596 5818880.727	8.23	47.2	296° 04' 33.41"				
L6	START END	31.45 78.33	310202.868 310162.716	5818880.727 5818904.927	46.88		301° 04′ 41″				
C5	TP IP TP	78.33 84.29 88.57	310162.716 310157.615 310159.098	5818904.927 5818908.001 5818913.769	10.24	8.0	337° 44' 43.78"				
L7	START END	88.57 261.26	310159.098 310202.082	5818913.769 5819081.023	172.69		014° 24′ 47″				
C6	TP IP TP	261.26 269.83 275.90	310202.082 310204.216 310212.787	5819081.023 5819089.326 5819089.450	14.64	11.2	051° 47' 25.13"				
L8	START END	275.90 313.86	310212.787 310250.746	5819089.450 5819090.002	37.96		089° 10′ 04″				
C7	TP IP TP	313.86 321.23 328.53	310250.746 310258.113 310265.286	5819090.002 5819090.109 5819088.430	14.66	60.0	096° 10' 04.96"				
L9	START END	328.53 349.57	310265.286 310285.777	5819088.430 5819083.636	21.04		103° 10′ 06″				

FOR CONSTRUCTION

Bevision Date Reason Drawn Checke

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0.5 1.0 1.5 2.0 2.5

DR

5003

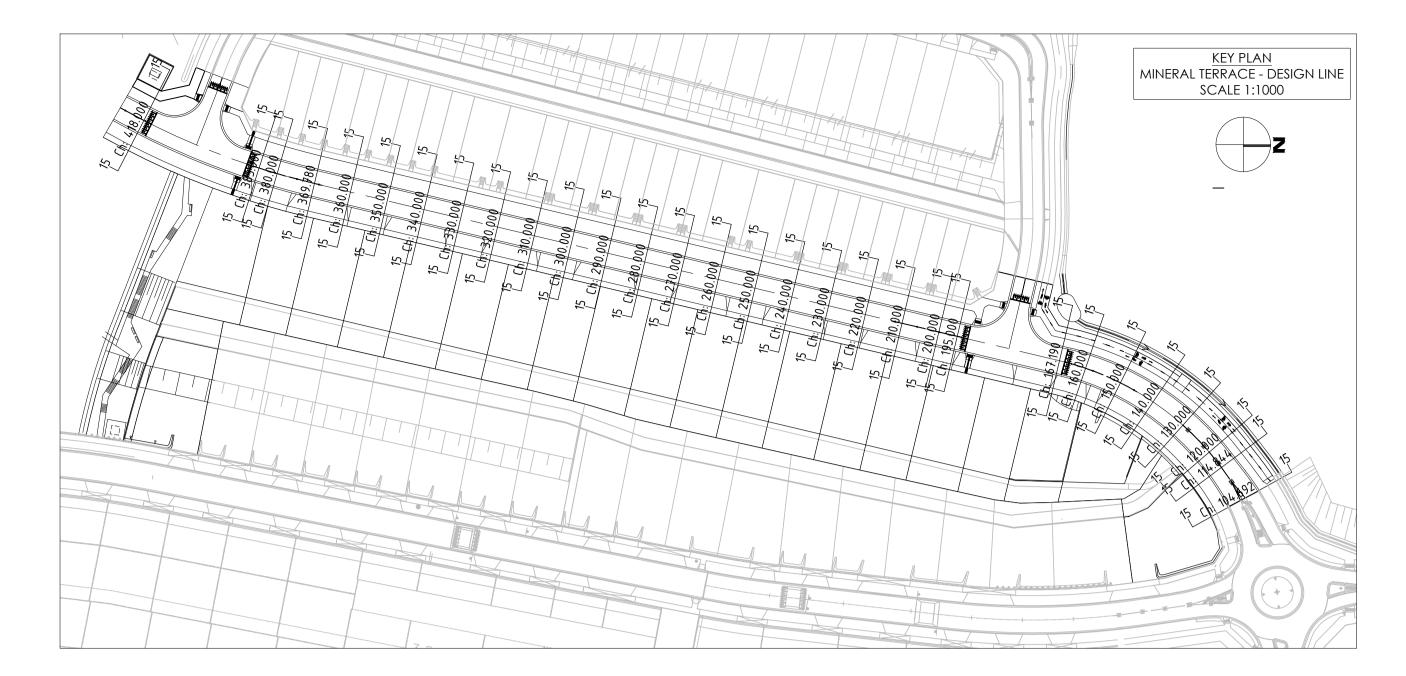
CIVIL SITEWORKS

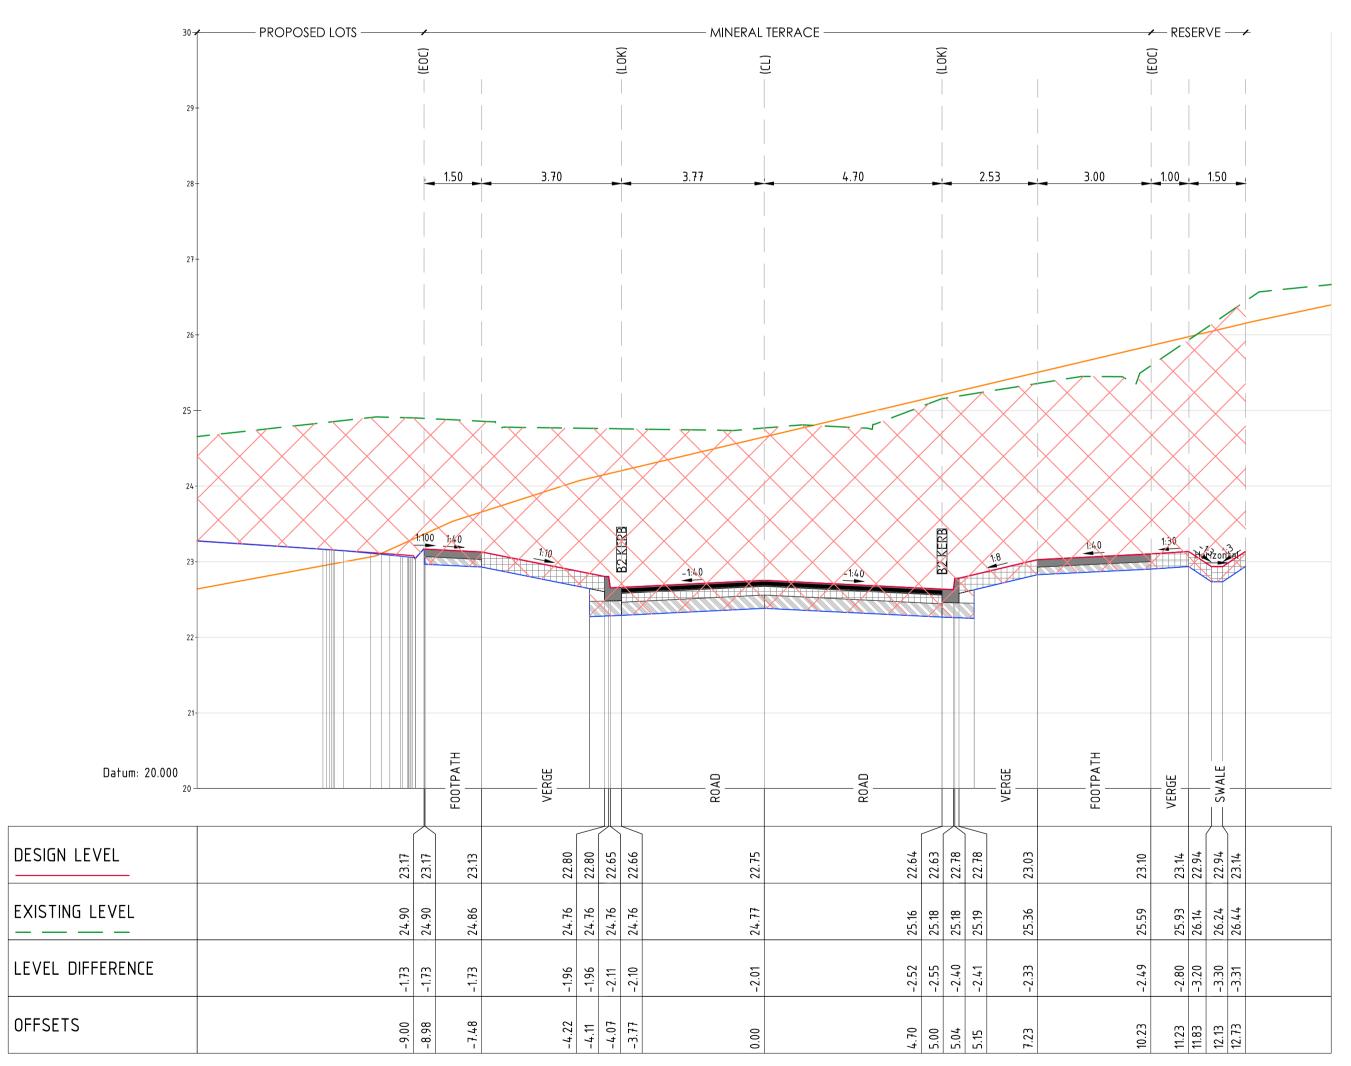
7D4

15006 CJA


Project RIVER VALLEY - STAGE 7D4 Drawing Title
ROAD LONG SECTION Client
YOURLAND
Purpose of Issue (SHEET 4 OF 4) FOR CONSTRUCTION 1:250H. 1:50V @ A1 18.09.23

XX





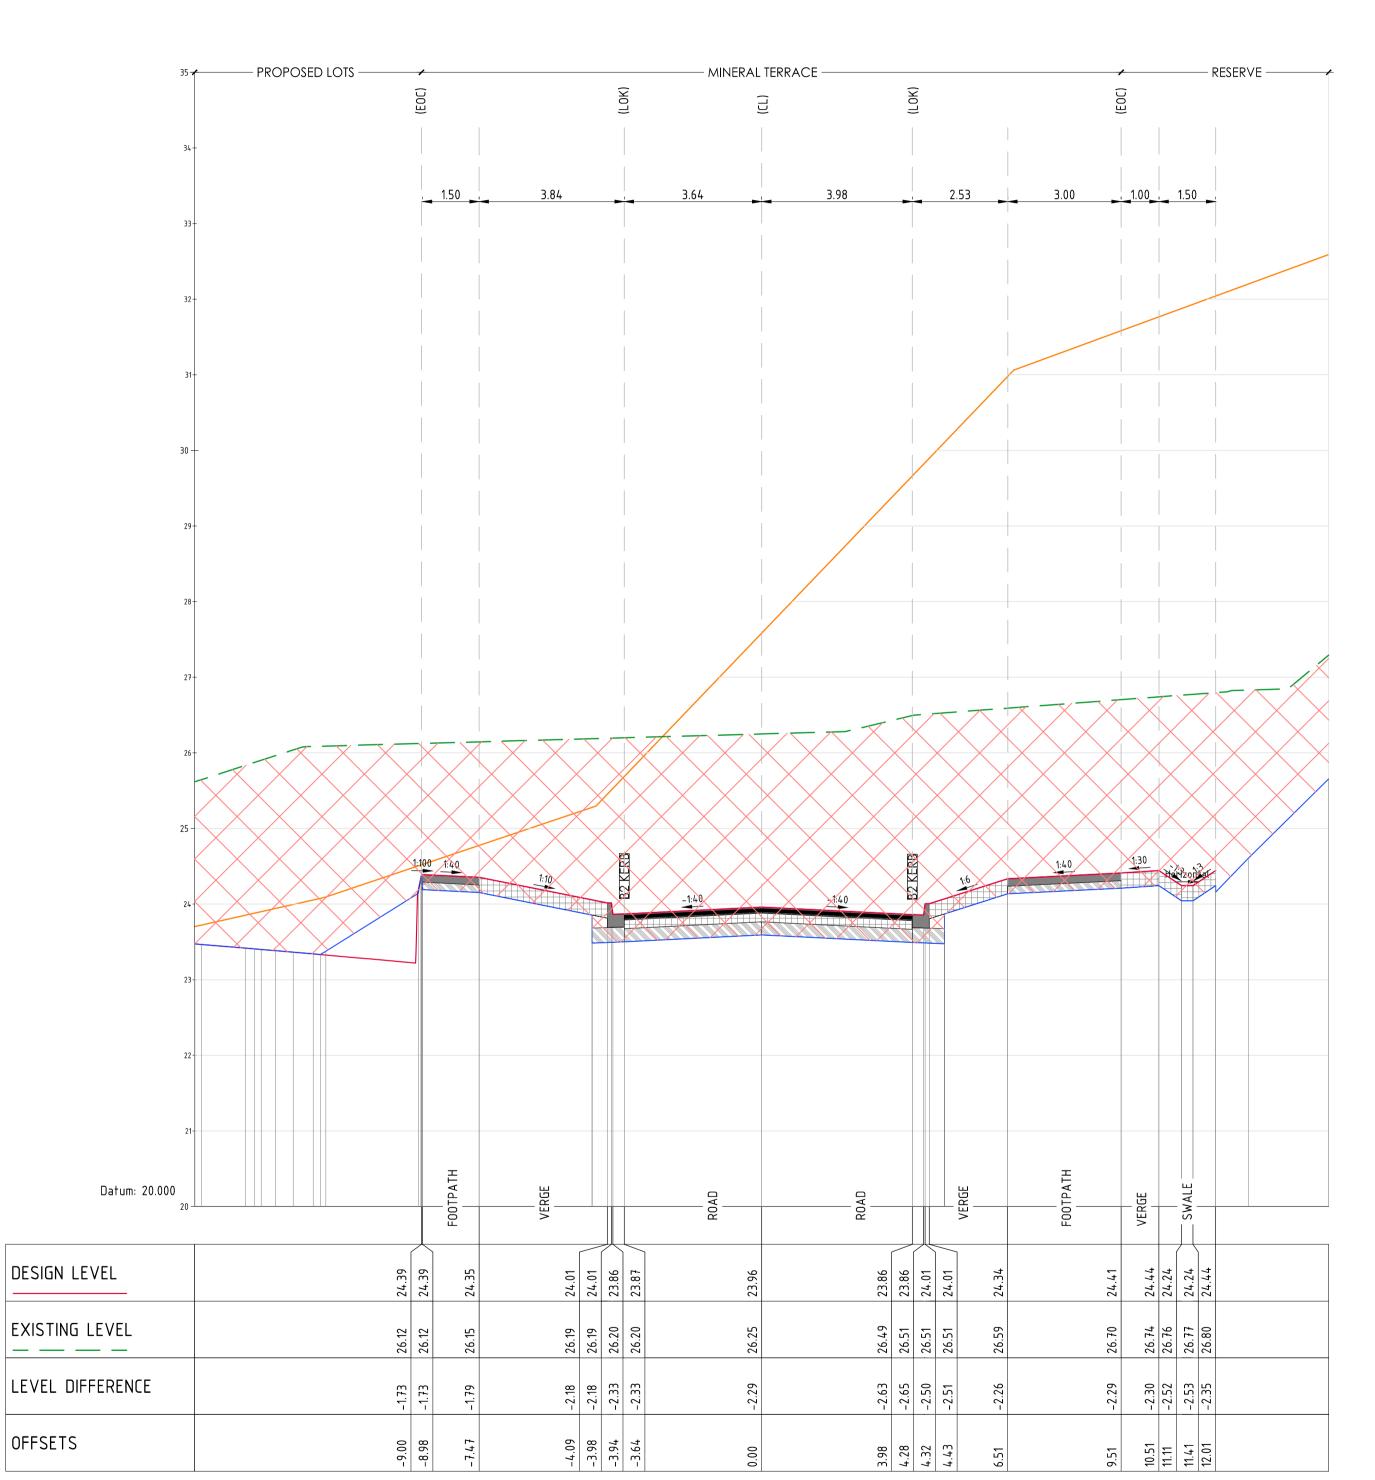AL - MINERAL TERRACE - CL - HA CHAINAGE 104.69 SCALE HORIZ. 1:100 SCALE VERT. 1:50 (X2)



AL - MINERAL TERRACE - CL - HA CHAINAGE 114.84 SCALE HORIZ. 1:100

SCALE VERT. 1:50 (X2)

0 18.09.23 ISSUED FOR CONSTRUCTION
Revision Date Reason

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DENOTES ENGINEERED FILL TO T+T TYPE 2 SPECIFICATION (1000780.1000.S1.REV4) AND PREPARED UNDER LEVEL 1 SUPERVISION. (AS PART OF EARLY WORKS).

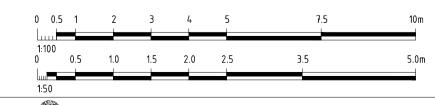
DENOTES EXTENT OF CUT (AS PART OF EARLY WORKS)

FOR CONSTRUCTION










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15006 CJA 7D4 XX

Project RIVER VALLEY - STAGE 7D4 Drawing Title
CROSS SECTIONS - MINERAL TERRACE (SHEET 1 OF 15) Client YOURLAND FOR CONSTRUCTION 1:100H, 1:50V @ A1 18.09.23

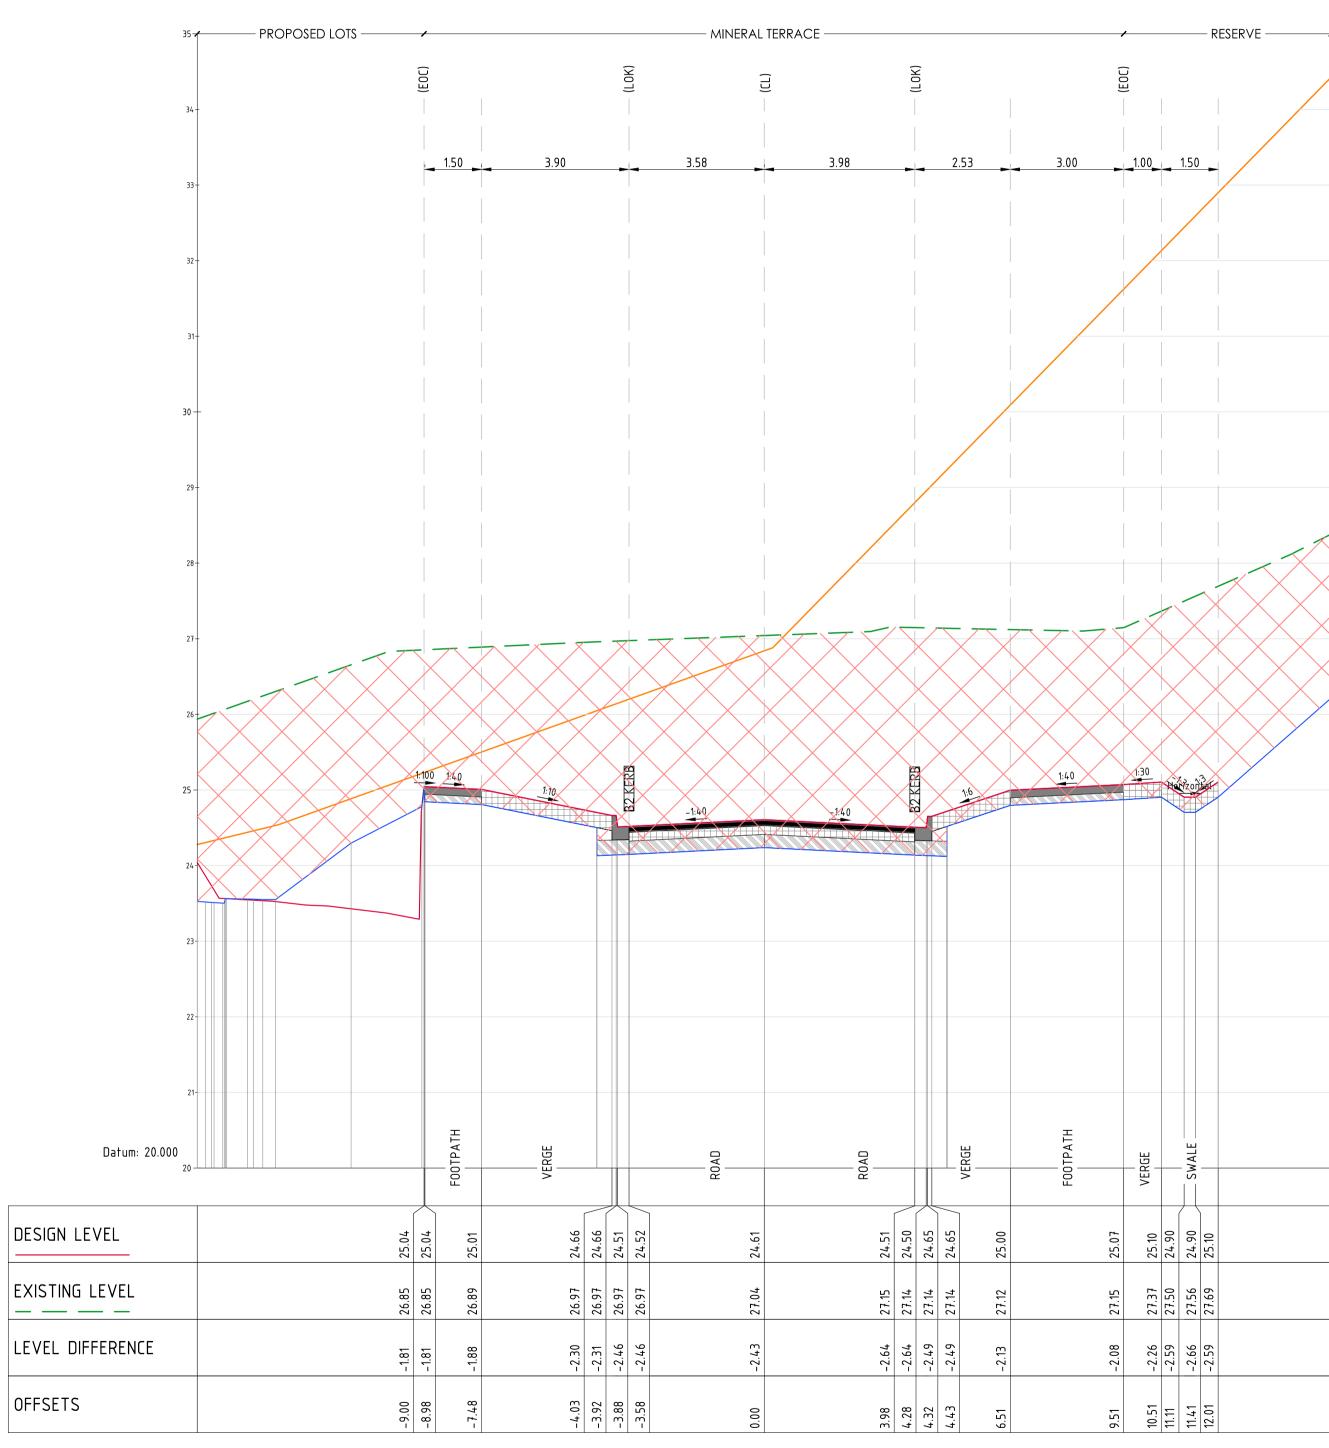DR



AL - MINERAL TERRACE - CL - HA CHAINAGE 120.00 SCALE HORIZ. 1:100

> Note for Contractors
>
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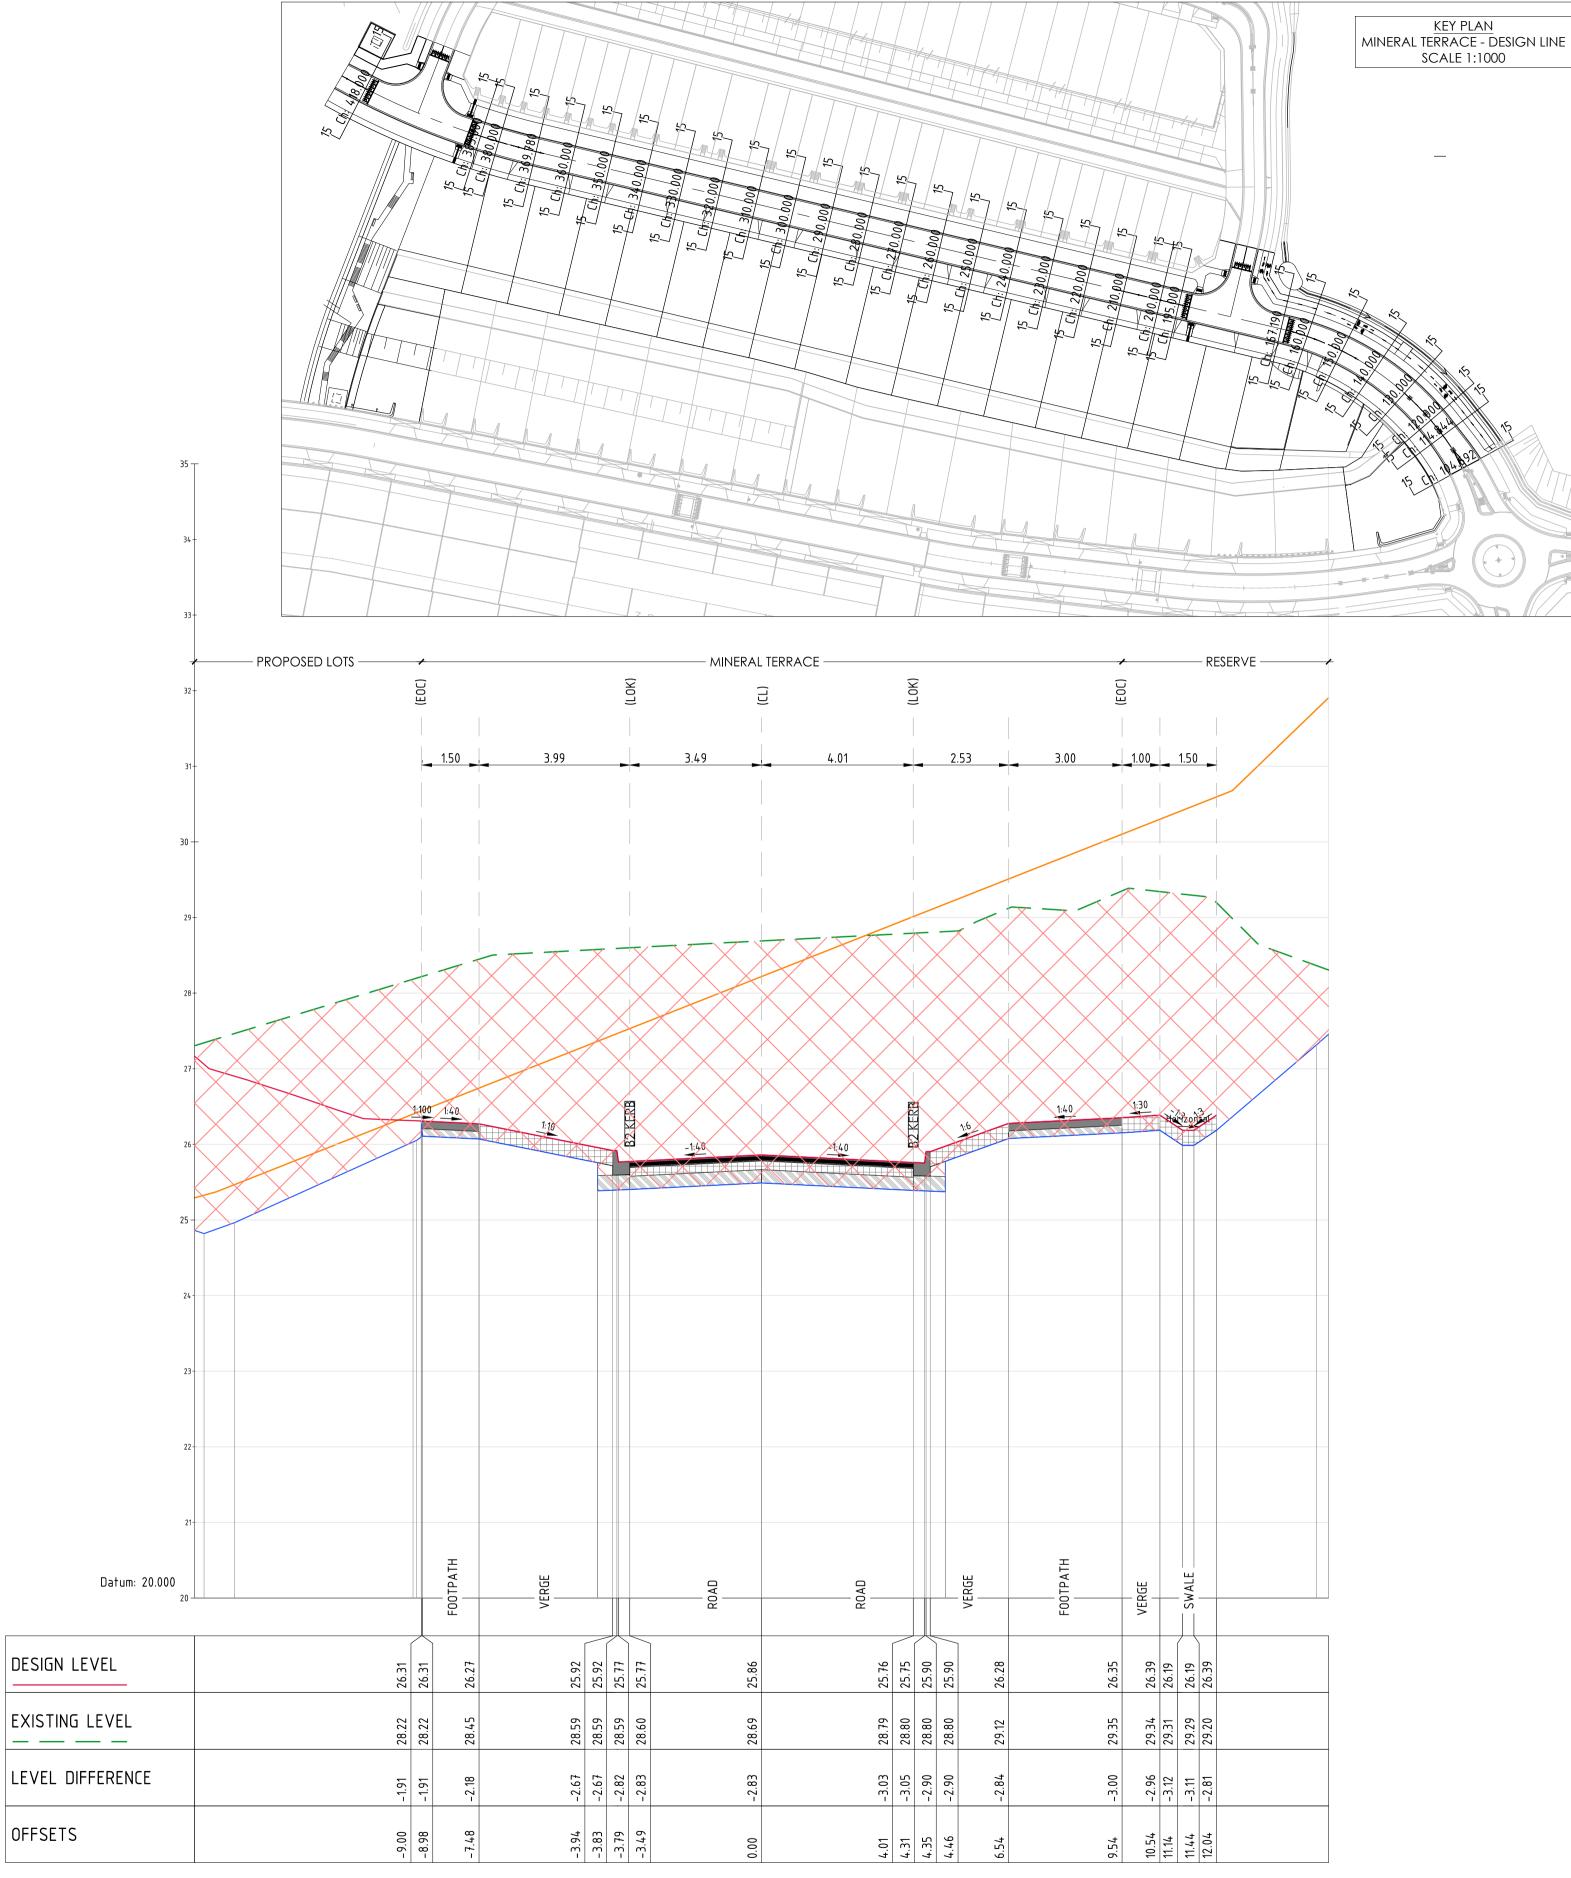
This drawing should not be issued in part and must be read in conjunction with all appropriate specifications, notes pages, details and authority drawings as appropriate.

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DENOTES EXTENT OF CUT (AS PART OF EARLY WORKS)

FOR CONSTRUCTION



AL - MINERAL TERRACE - CL - HA CHAINAGE 130.00 SCALE HORIZ. 1:100

SCALE VERT. 1:50 (X2)



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0 0.5 1 2 3 4 5

Project RIVER VALLEY - STAGE 7D4 Drawing Title
CROSS SECTIONS - MINERAL TERRACE (SHEET 2 OF 15) YOURLAND FOR CONSTRUCTION 1:100H, 1:50V @ A1 18.09.23 DR 5101 15006 CJA 7D4 XX

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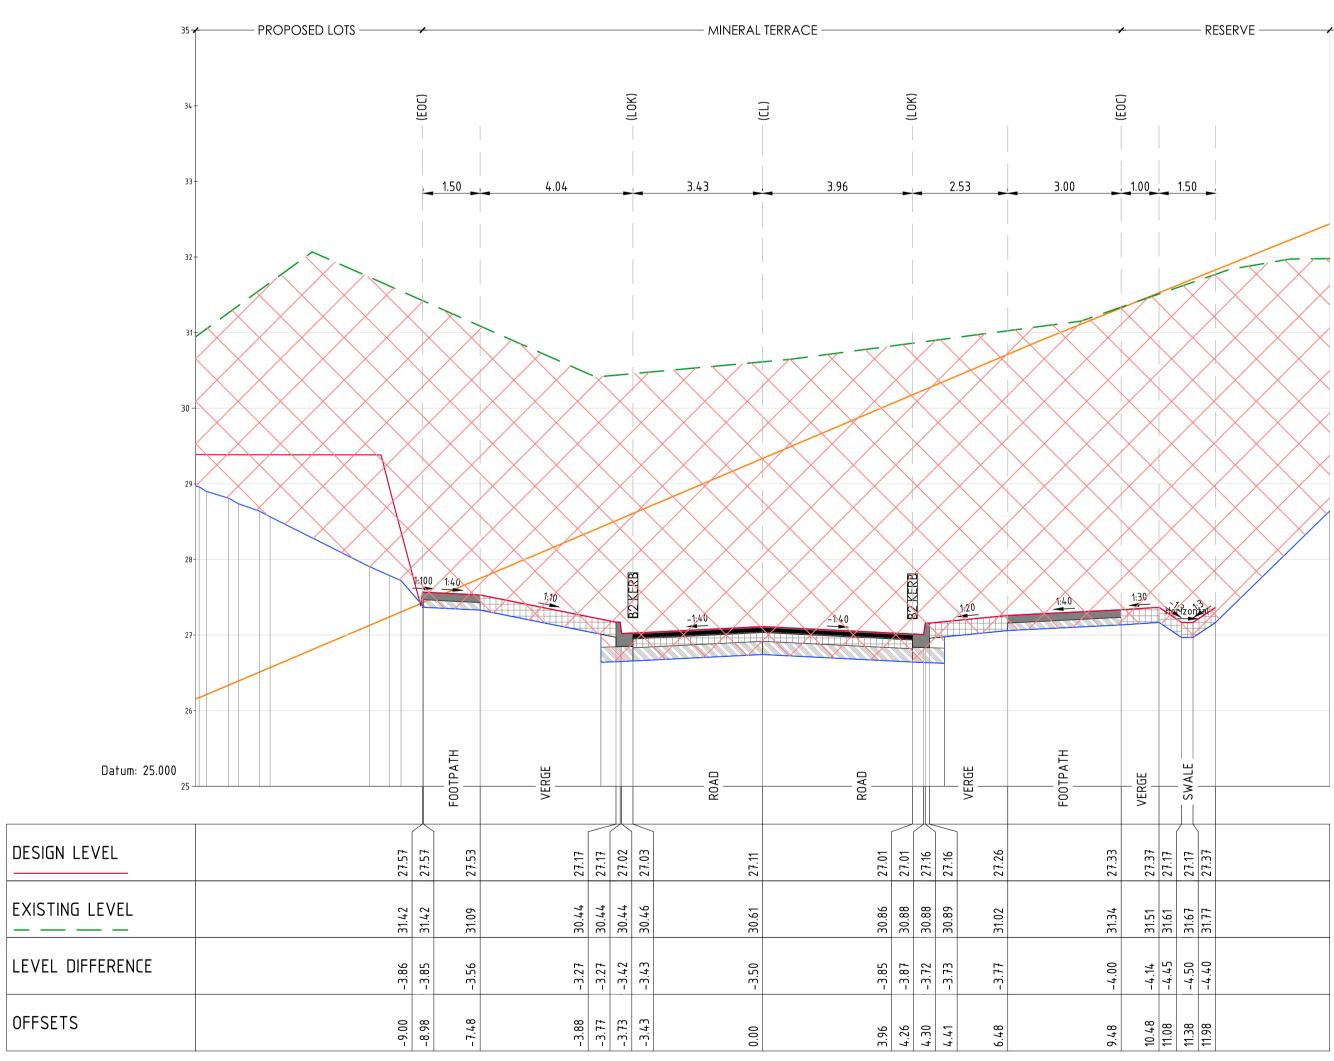
0 18.09.23 ISSUED FOR CONSTRUCTION
Revision Date Reason

SCALE VERT. 1:50 (X2)

DESIGN LEVEL

OFFSETS





AL – MINERAL TERRACE – CL – HA CHAINAGE 140.00

SCALE HORIZ. 1:100 SCALE VERT. 1:50 (X2)

0 18.09.23 ISSUED FOR CONSTRUCTION
Revision Date Reason

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DENOTES ENGINEERED FILL TO T+T TYPE 2 SI SUPERVISION. (AS PART OF EARLY WORKS). DENOTES ENGINEERED FILL TO T+T TYPE 2 SPECIFICATION (1000780.1000.S1.REV4) AND PREPARED UNDER LEVEL 1

AL – MINERAL TERRACE – CL – HA CHAINAGE 150.00







28.27 28.26 28.26 28.41 28.41

8 3 3 9

33 33 33

-4.68 -4.91 -4.92 -4.74

10.35 10.95 11.25 11.85

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CROSS SECTIONS - MINERAL TERRACE (SHEET 3 OF 15) YOURLAND

XX

DR

5102

RESERVE —

NOT FOR CONSTRUCTION

- 110N	ULTIUN

SCALE HORIZ. 1:100

SCALE VERT. 1:50 (X2)

Datum: 25.000

DESIGN LEVEL

EXISTING LEVEL

LEVEL DIFFERENCE

OFFSETS

– PROPOSED LOTS -

DENOTES EXTENT OF CUT (AS PART OF EARLY WORKS)

28.42 28.42 28.27 28.28

32. 32.

-4.56 -4.54 -4.68 -4.63

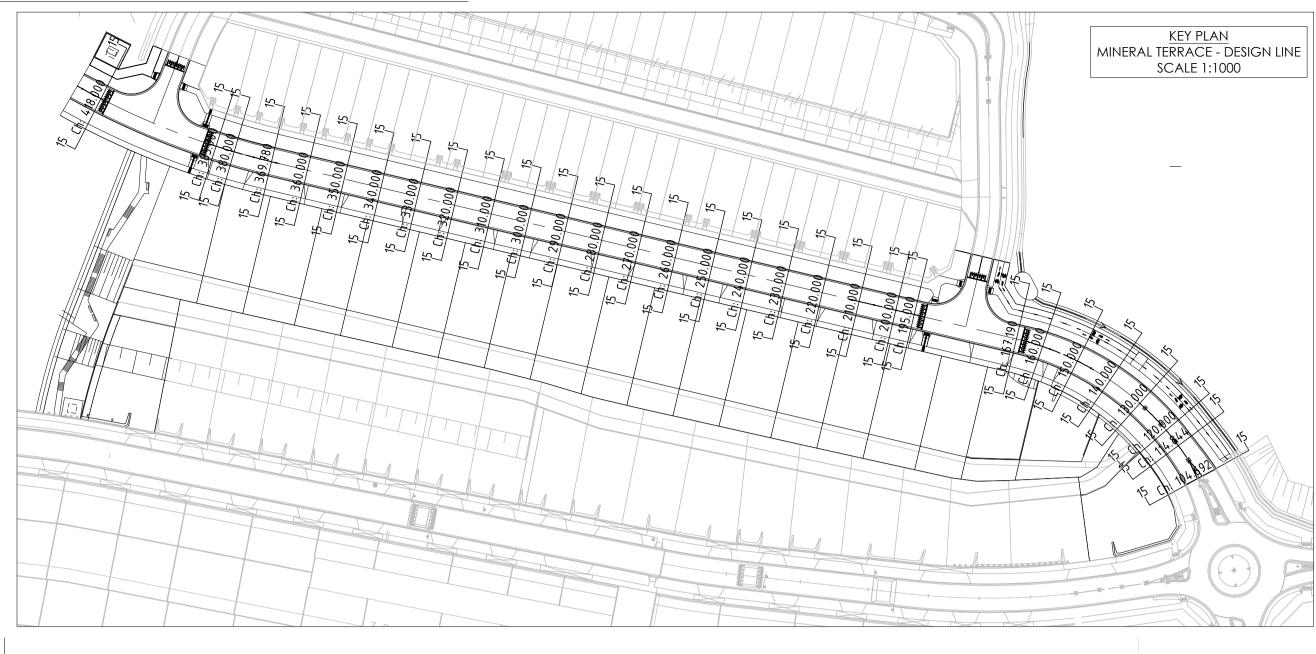
-3.86 -3.75 -3.71 -3.71

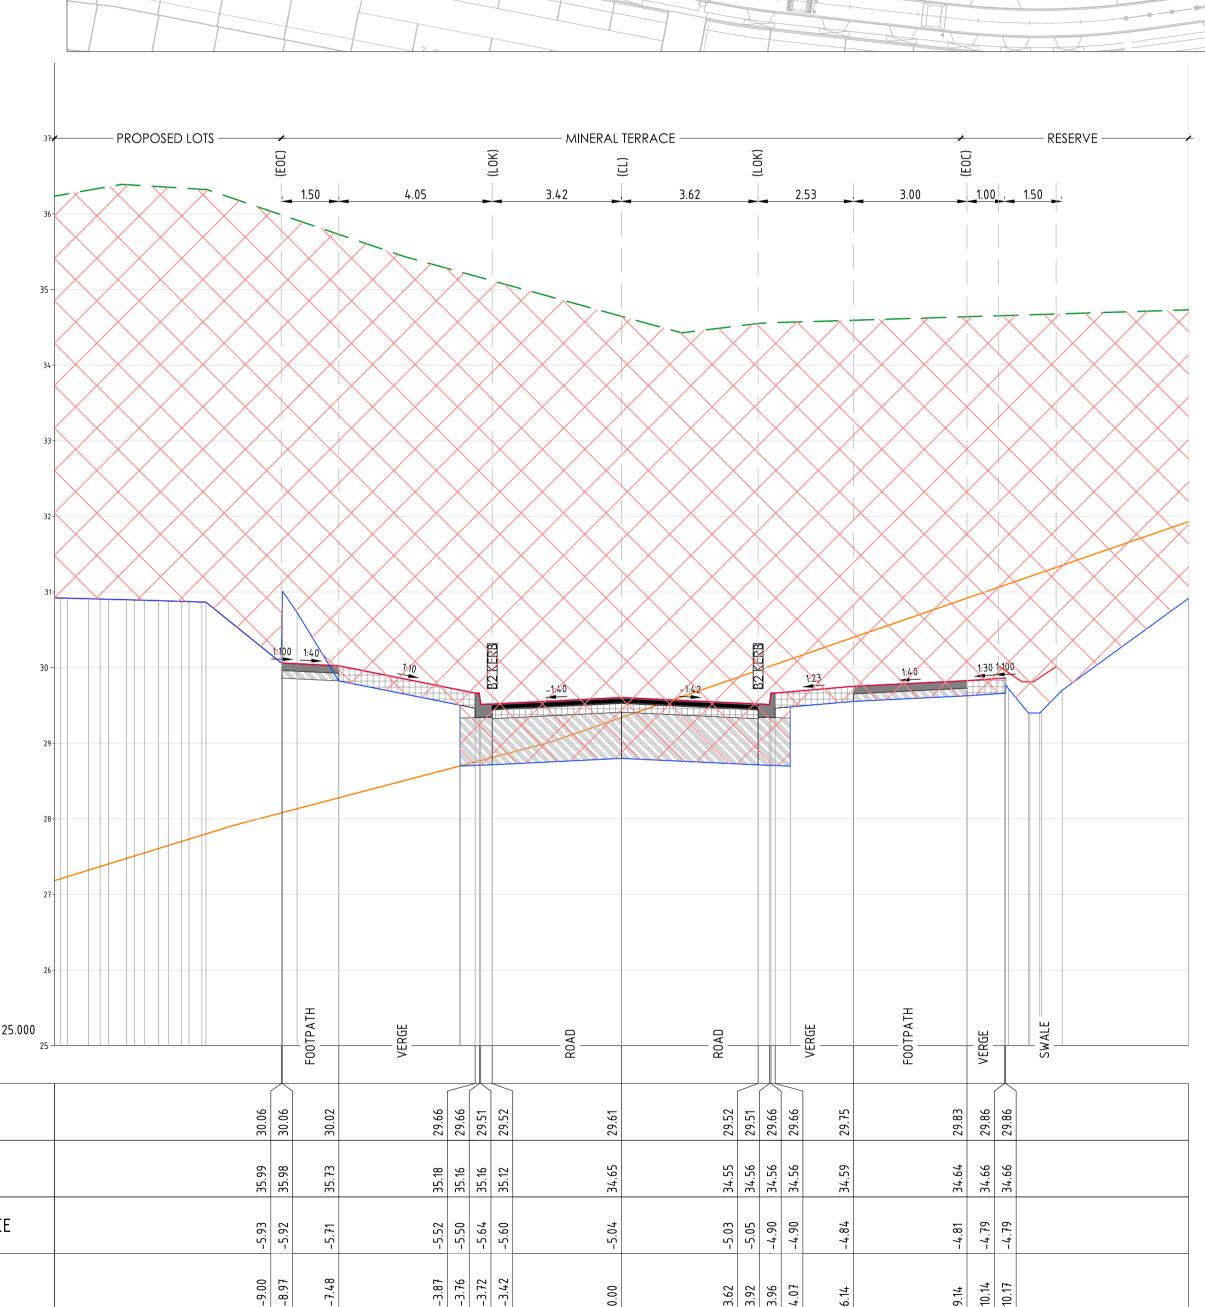


Yourland CJ ARMS

Developments FOR CONSTRUCTION 15006 CJA 7D4

- MINERAL TERRACE -





Datum: 25.000 DESIGN LEVEL EXISTING LEVEL LEVEL DIFFERENCE OFFSETS 9.14 10.14 10.17

AL - MINERAL TERRACE - CL - HA CHAINAGE 160.00 SCALE HORIZ. 1:100 SCALE VERT. 1:50 (X2)

- RAISED INTERSECTION Datum: 25.000 DESIGN LEVEL 30.74 30.20 30.19 30.34 30.34 30.47 00 00 00 00 EXISTING LEVEL 34.98 34.99 34.99 36. 36. LEVEL DIFFERENCE -5.71 -5.69 -5.84 -5.78 -6.06

- MINERAL TERRACE -

AL - MINERAL TERRACE - CL - HA CHAINAGE 167.19

-9.00

SCALE HORIZ. 1:100 SCALE VERT. 1:50 (X2)

OFFSETS

- PROPOSED LOTS -



-3.90 -3.79 -3.75 -3.45

0.5 1.0 1.5 2.0 2.5

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15006 CJA 7D4 XX

Project RIVER VALLEY - STAGE 7D4 Drawing Title
CROSS SECTIONS - MINERAL TERRACE (SHEET 4 OF 15) YOURLAND FOR CONSTRUCTION 1:100H, 1:50V @ A1 18.09.23

DR

5103

− RESERVE −−−−−

Note for Contractors

The works described on this drawing must be undertaken by competent Contractors with

0 18.09.23 ISSUED FOR CONSTRUCTION
Revision Date Reason

an appropriate level of experience who have prepared appropriate Safe Work Method Statements (SWMS) relating to these works. The contractor is responsible for the

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Dial before you dig. BEWARE OF UNDERGROUND SERVICES. The location of underground services are approximate only and their exact position should be proven on site. No guarantee is given that existing services are shown.

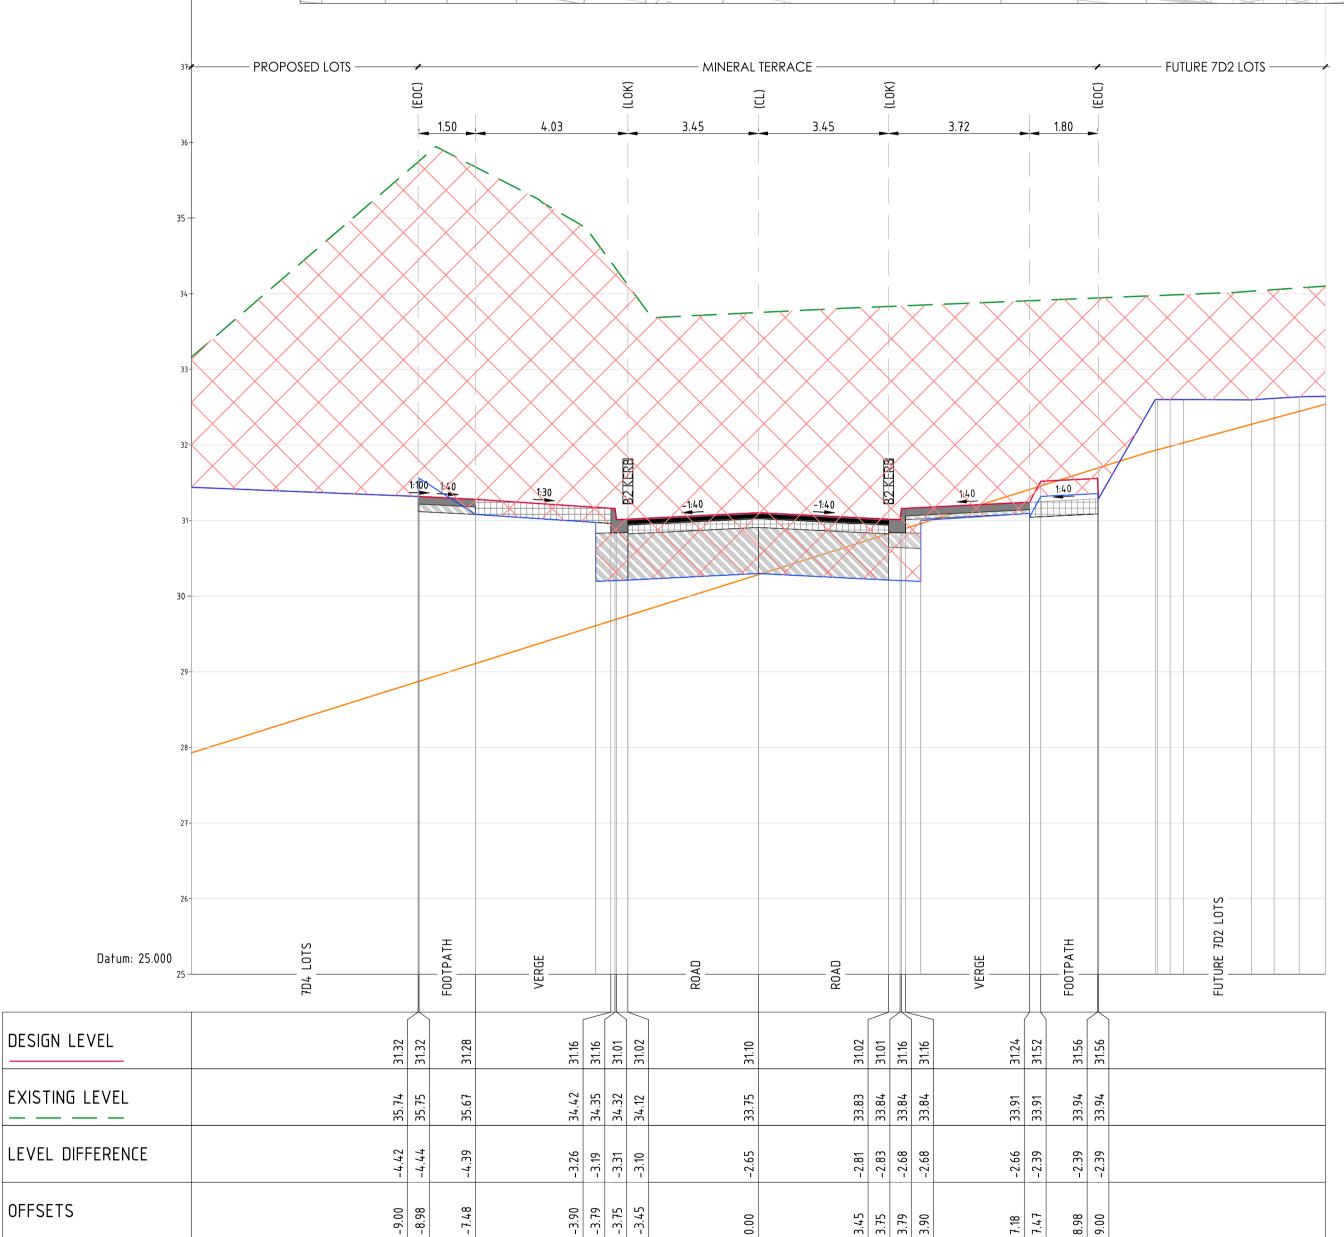


DENOTES ENGINEERED FILL TO T+T TYPE 2 SPECIFICATION (1000780.1000.S1.REV4) AND PREPARED UNDER LEVEL 1 DENOTES ENGINEERED FILL TO T+T TYPE 2 SI SUPERVISION. (AS PART OF EARLY WORKS).

DENOTES EXTENT OF CUT (AS PART OF EARLY WORKS)

FOR CONSTRUCTION





→ PROPOSED LOTS — MINERAL TERRACE − FUTURE 7D2 LOTS −−−− Datum: 25.000 DESIGN LEVEL EXISTING LEVEL 33.73 33.72 33.72 33.72 33.94 LEVEL DIFFERENCE -2.71 -2.72 -2.57 -2.58 -2.29 -2.51 -2.51 -2.66 -2.65 3.45 3.75 3.79 3.90 8.98

AL - MINERAL TERRACE - CL - HA CHAINAGE 200.00

SCALE HORIZ. 1:100

OFFSETS

SCALE VERT. 1:50 (X2)

 0
 18.09.23
 ISSUED FOR CONSTRUCTION

 Revision
 Date
 Reason

DESIGN LEVEL

EXISTING LEVEL

OFFSETS

Note for Contractors

The works described on this drawing must be undertaken by competent Contractors with an appropriate level of experience who have prepared appropriate Safe Work Method Statements (SWMS) relating to these works. The contractor is responsible for the management of all risks associated with the construction activities stated on this

AL - MINERAL TERRACE - CL - HA CHAINAGE 195.00

SCALE HORIZ. 1:100

SCALE VERT. 1:50 (X2)

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DENOTES ENGINEERED FILL TO T+T TYPE 2 SI SUPERVISION. (AS PART OF EARLY WORKS). DENOTES ENGINEERED FILL TO T+T TYPE 2 SPECIFICATION (1000780.1000.S1.REV4) AND PREPARED UNDER LEVEL 1

DENOTES EXTENT OF CUT (AS PART OF EARLY WORKS)

FOR CONSTRUCTION










CIVIL SITEWORKS

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CROSS SECTIONS - MINERAL TERRACE (SHEET 5 OF 15) YOURLAND FOR CONSTRUCTION 1:100H, 1:50V @ A1 18.09.23

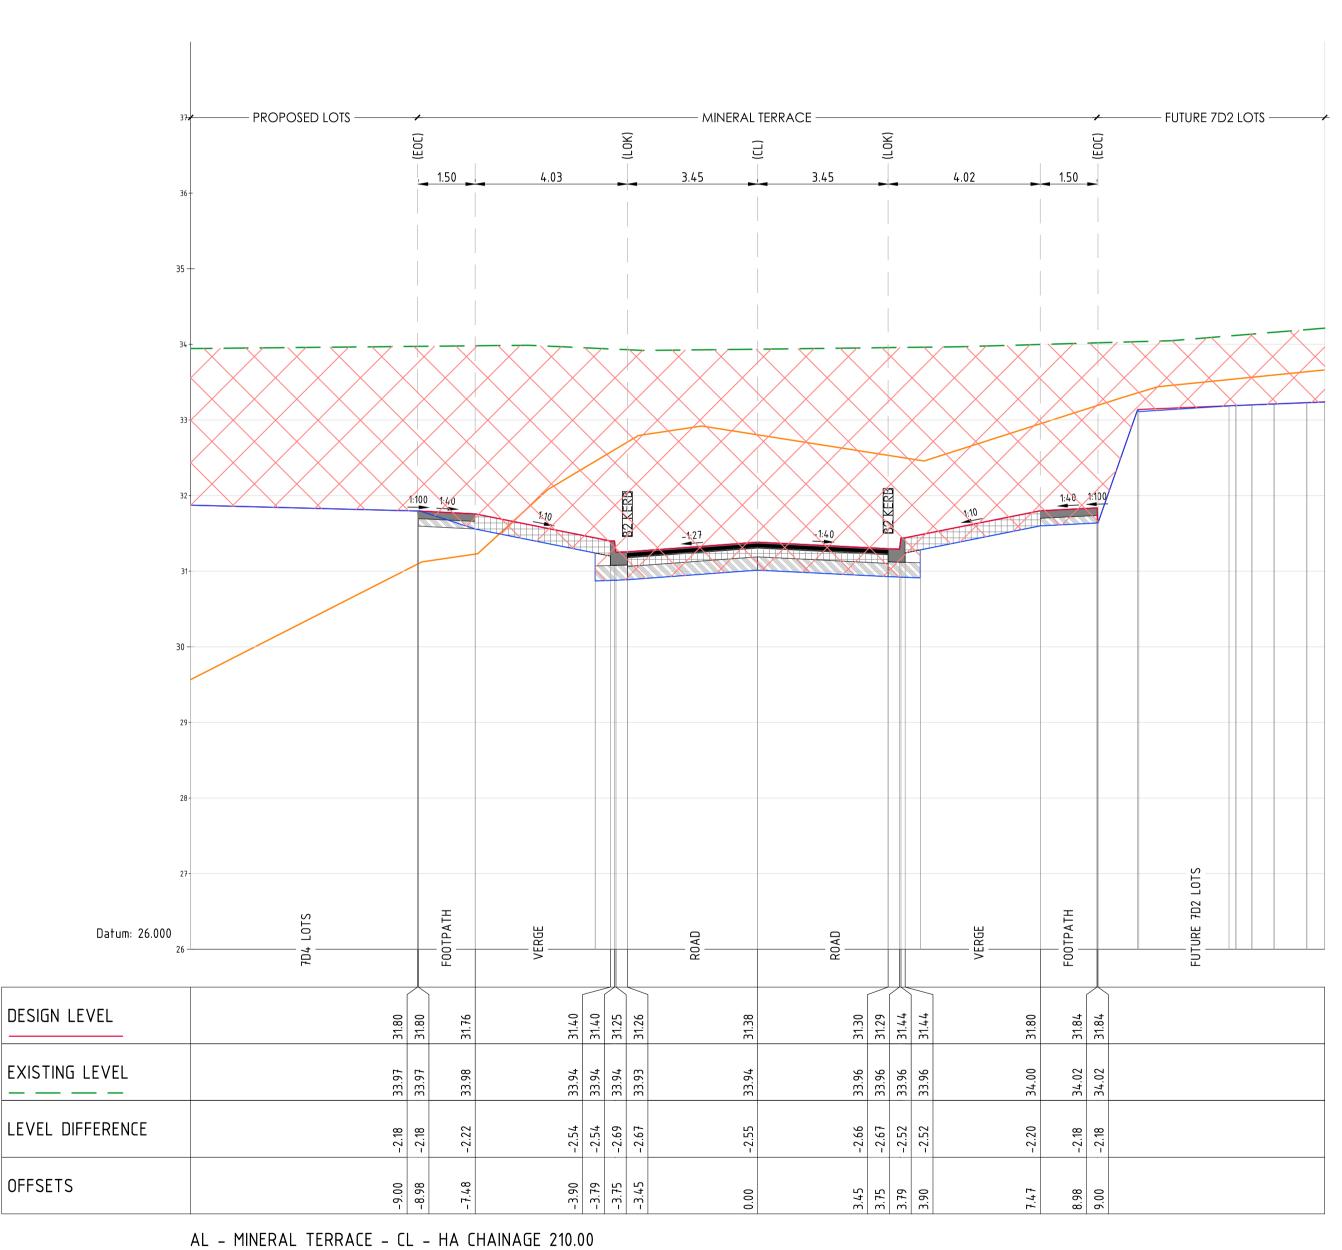DR





→ PROPOSED LOTS --- MINERAL TERRACE — FUTURE 7D2 LOTS — ✓ Datum: 28.000 DESIGN LEVEL 31.98 EXISTING LEVEL 39.40 35.27 35.31 35.33 35.45 37.06 37.23 37.25 37.32 4 4 34. LEVEL DIFFERENCE -2.16 -5.58 -5.75 -5.63 -5.69 -9.00 -3.90 -3.79 -3.75 -3.45 8.98 3.45 3.75 3.79 3.90

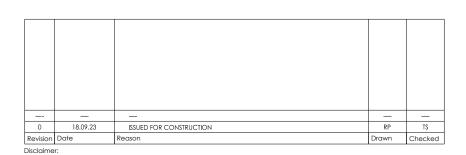
AL - MINERAL TERRACE - CL - HA CHAINAGE 220.00

SCALE HORIZ. 1:100 SCALE VERT. 1:50 (X2)

OFFSETS

SCALE HORIZ. 1:100

SCALE VERT. 1:50 (X2)



Note for Contractors

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DENOTES ENGINEERED FILL TO T+T TYPE 2 SI SUPERVISION. (AS PART OF EARLY WORKS). DENOTES ENGINEERED FILL TO T+T TYPE 2 SPECIFICATION (1000780.1000.S1.REV4) AND PREPARED UNDER LEVEL 1

DENOTES EXTENT OF CUT (AS PART OF EARLY WORKS)

FOR CONSTRUCTION







0 0.5 1 2 3 4 5


CIVIL SITEWORKS


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CROSS SECTIONS - MINERAL TERRACE (SHEET 6 OF 15) YOURLAND Checked By FOR CONSTRUCTION 1:100H, 1:50V @ A1 18.09.23


XX

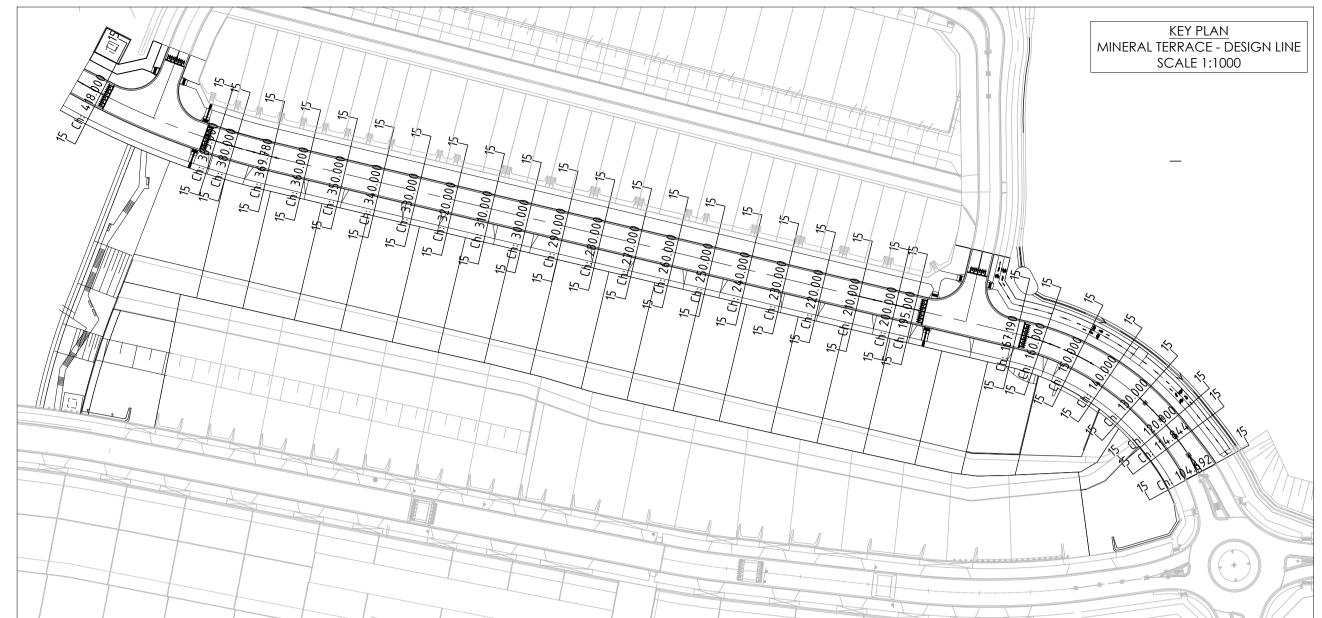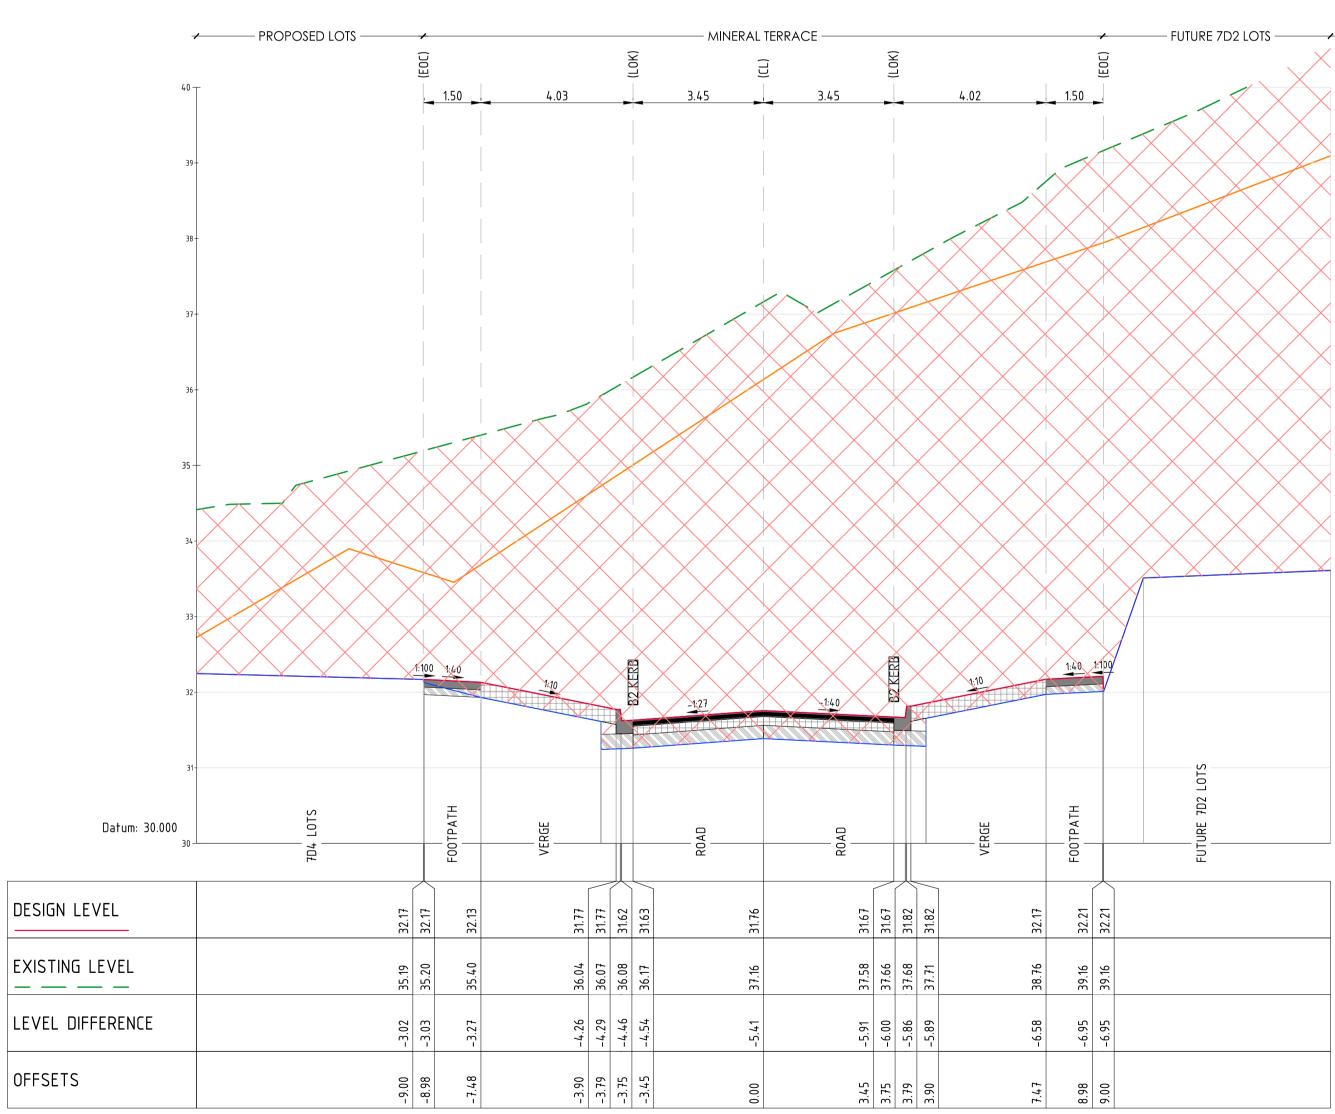DR





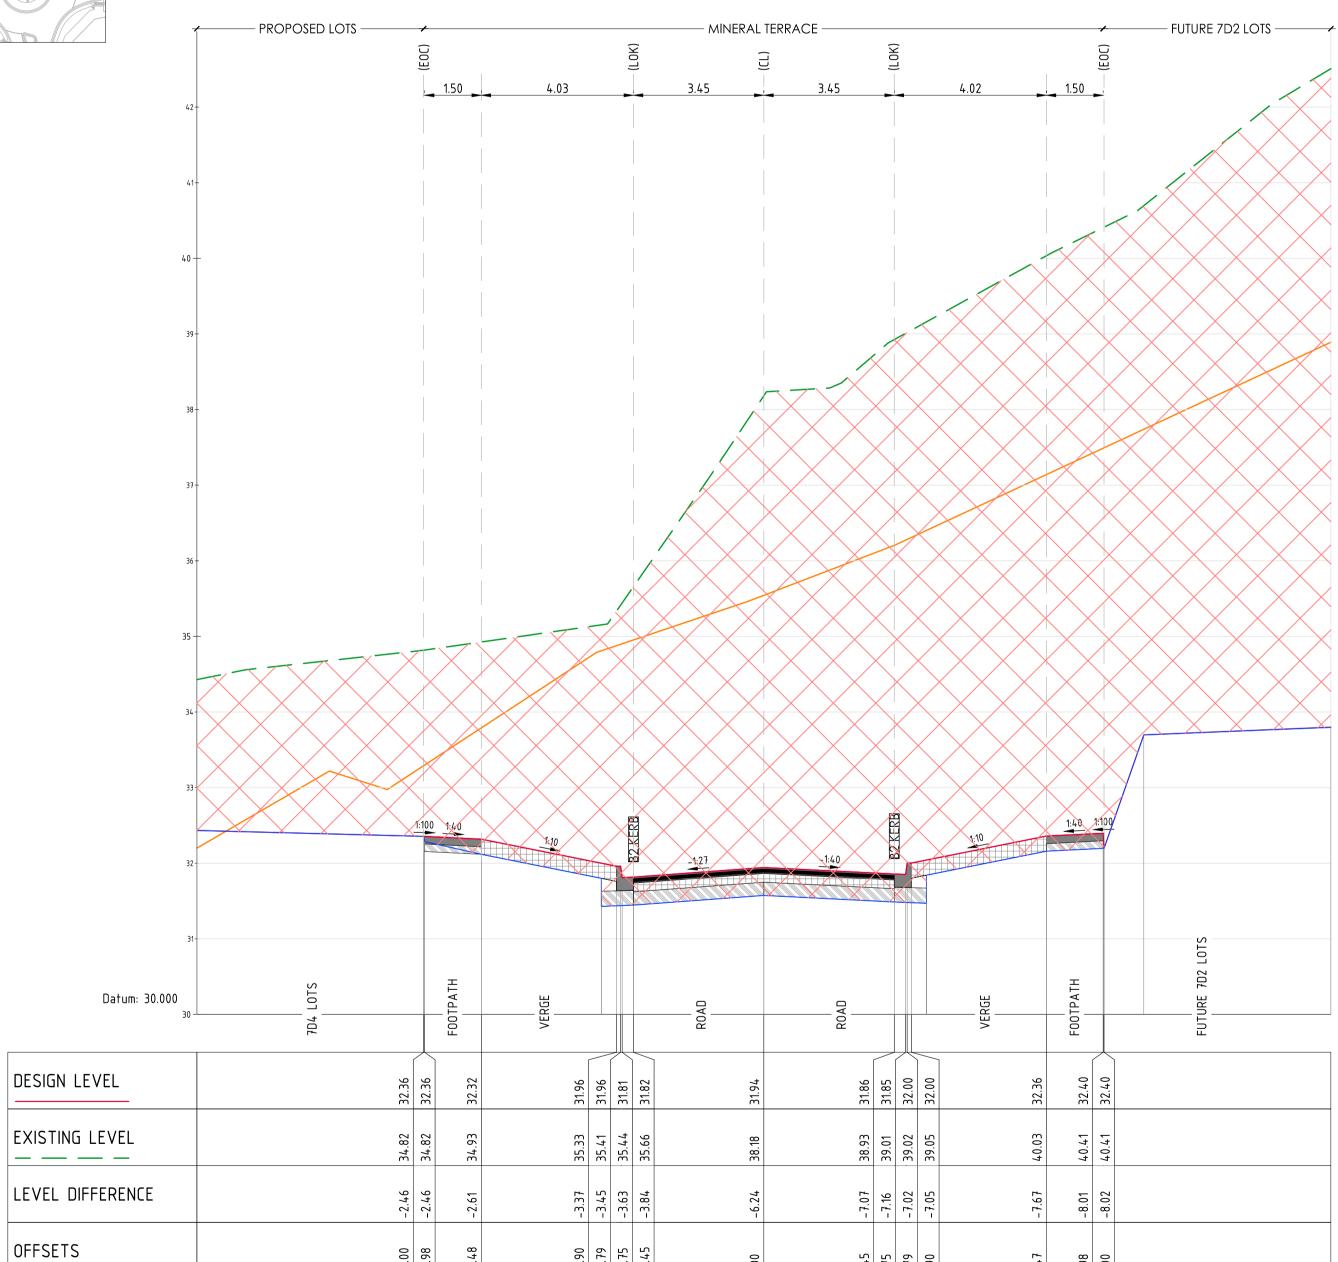AL - MINERAL TERRACE - CL - HA CHAINAGE 230.00 SCALE HORIZ. 1:100 SCALE VERT. 1:50 (X2)



AL - MINERAL TERRACE - CL - HA CHAINAGE 240.00 SCALE HORIZ. 1:100

SCALE VERT. 1:50 (X2)

0 18.09.23 ISSUED FOR CONSTRUCTION
Revision Date Reason

Note for Contractors

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DENOTES ENGINEERED FILL TO T+T TYPE 2 SI SUPERVISION. (AS PART OF EARLY WORKS). DENOTES ENGINEERED FILL TO T+T TYPE 2 SPECIFICATION (1000780.1000.S1.REV4) AND PREPARED UNDER LEVEL 1

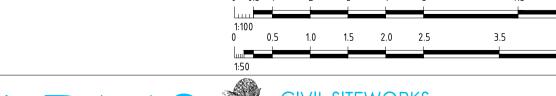
DENOTES EXTENT OF CUT (AS PART OF EARLY WORKS)

FOR CONSTRUCTION










15006 CJA 7D4

3.45 3.75 3.79 3.90

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CROSS SECTIONS - MINERAL TERRACE (SHEET 7 OF 15) YOURLAND FOR CONSTRUCTION

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MINERAL TERRACE -- PROPOSED LOTS -- FUTURE 7D2 LOTS ——— Datum: 30.000 DESIGN LEVEL 32.73 32.33 32.33 32.18 32.19 32.23 32.22 32.37 32.37 32.77 32.73 EXISTING LEVEL 37.34 37.36 37.37 37.43 39.07 39.14 39.15 39.18 39 40. LEVEL DIFFERENCE .92 .78 .80 -3.90 -3.79 -3.75 -3.45 3.45 3.75 3.79 3.90
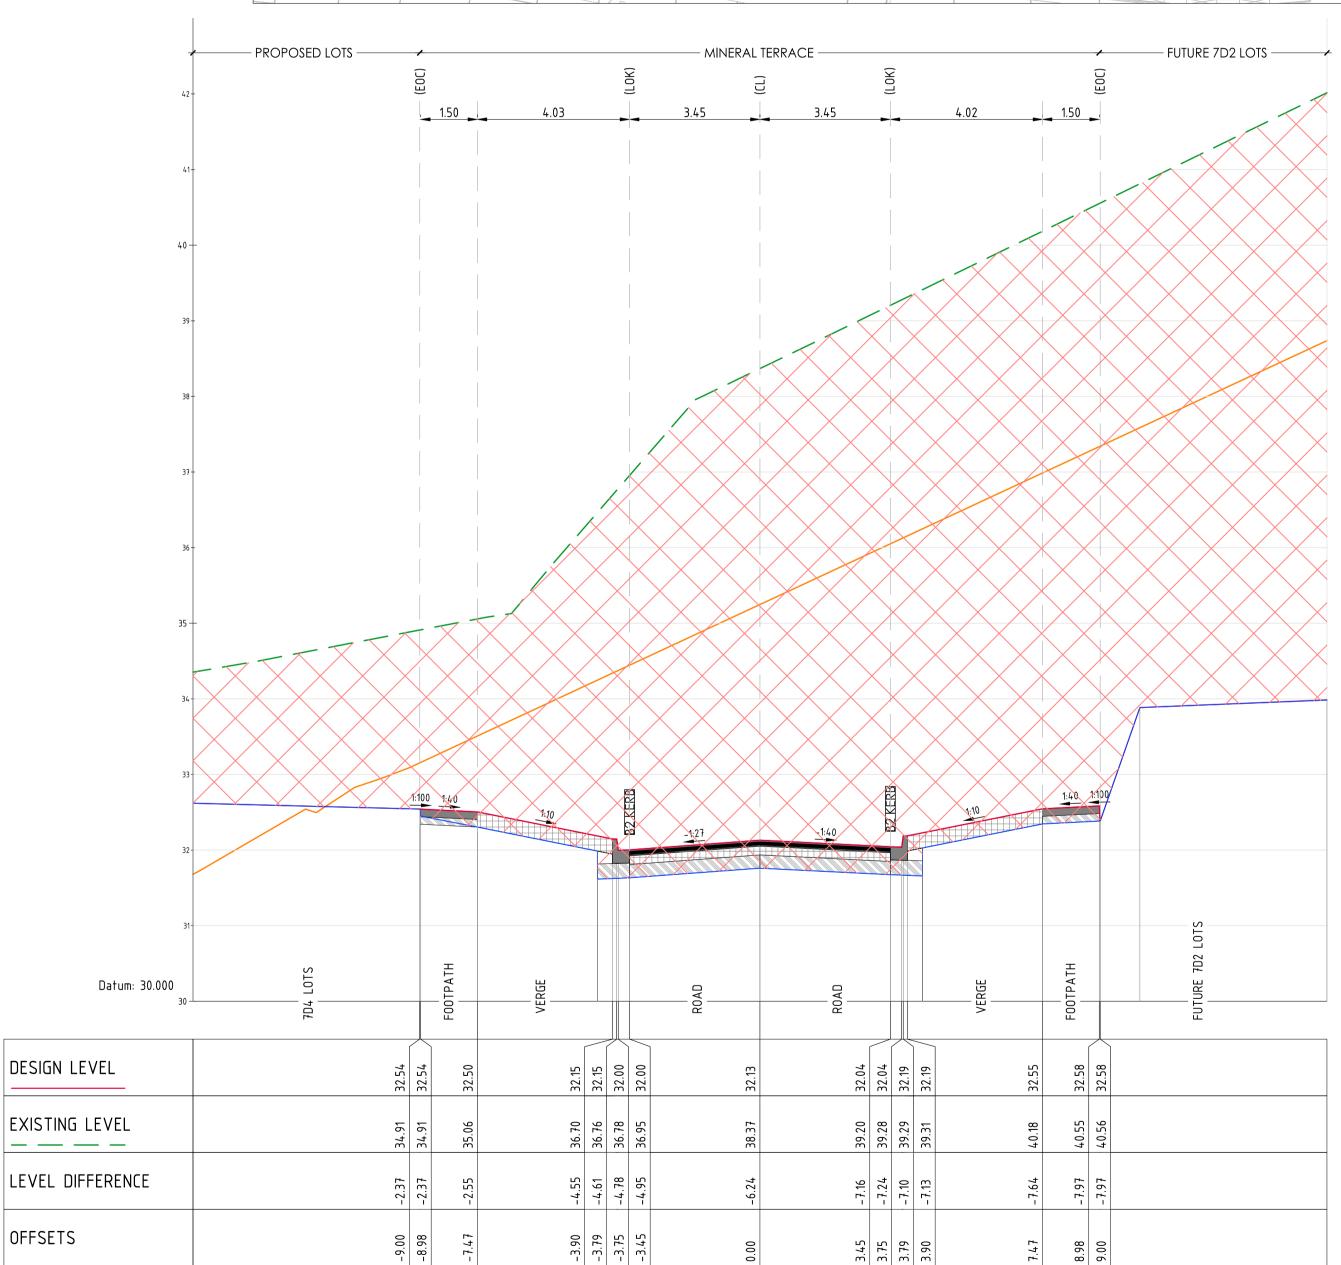
> AL - MINERAL TERRACE - CL - HA CHAINAGE 260.00 SCALE HORIZ. 1:100

SCALE VERT. 1:50 (X2)

OFFSETS

0 18.09.23 ISSUED FOR CONSTRUCTION
Revision Date Reason

DESIGN LEVEL

EXISTING LEVEL

OFFSETS

Note for Contractors

The works described on this drawing must be undertaken by competent Contractors with an appropriate level of experience who have prepared appropriate Safe Work Method Statements (SWMS) relating to these works. The contractor is responsible for the management of all risks associated with the construction activities stated on this

AL - MINERAL TERRACE - CL - HA CHAINAGE 250.00

SCALE HORIZ. 1:100

SCALE VERT. 1:50 (X2)

This drawing should not be issued in part and must be read in conjunction with all appropriate specifications, notes pages, details and authority drawings as appropriate.

Dial before you dig. BEWARE OF UNDERGROUND SERVICES. The location of underground services are approximate only and their exact position should be proven on site. No guarantee is given that existing services are shown.

DENOTES ENGINEERED FILL TO T+T TYPE 2 SI SUPERVISION. (AS PART OF EARLY WORKS). DENOTES ENGINEERED FILL TO T+T TYPE 2 SPECIFICATION (1000780.1000.S1.REV4) AND PREPARED UNDER LEVEL 1

DENOTES EXTENT OF CUT (AS PART OF EARLY WORKS)

FOR CONSTRUCTION



CIVIL SITEWORKS


15006 CJA 7D4


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CROSS SECTIONS - MINERAL TERRACE (SHEET 8 OF 15) YOURLAND FOR CONSTRUCTION 1:100H, 1:50V @ A1 18.09.23

XX

DR

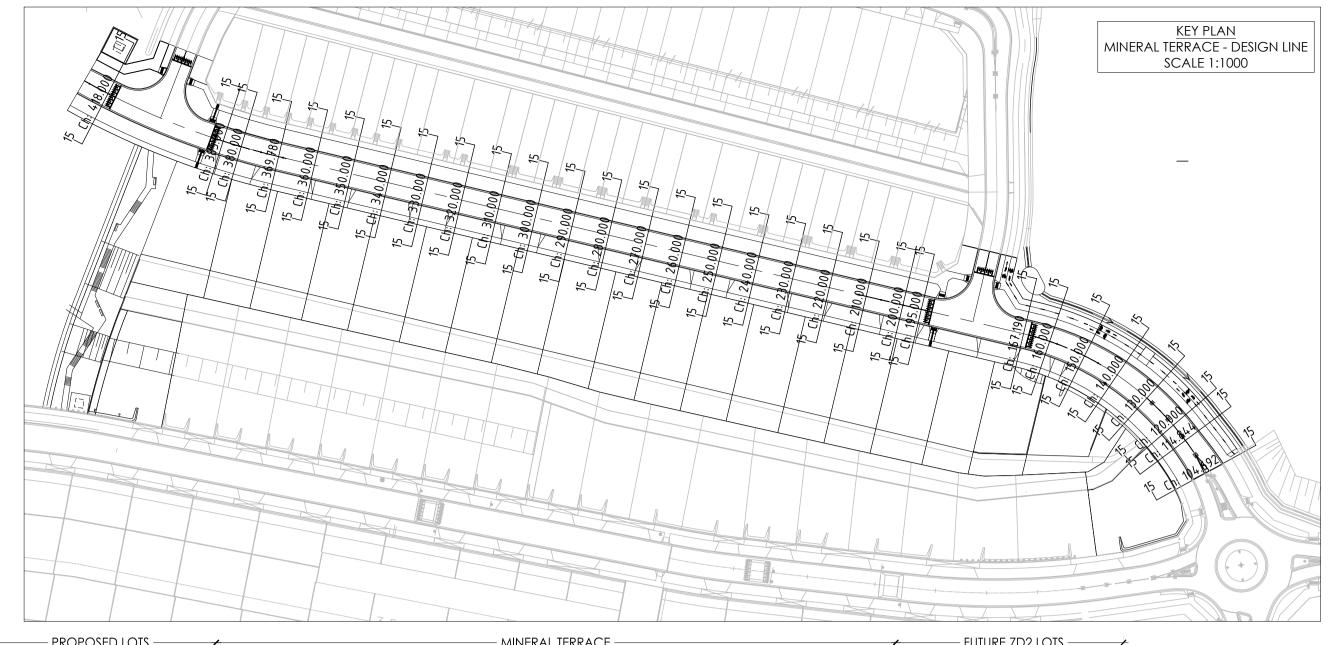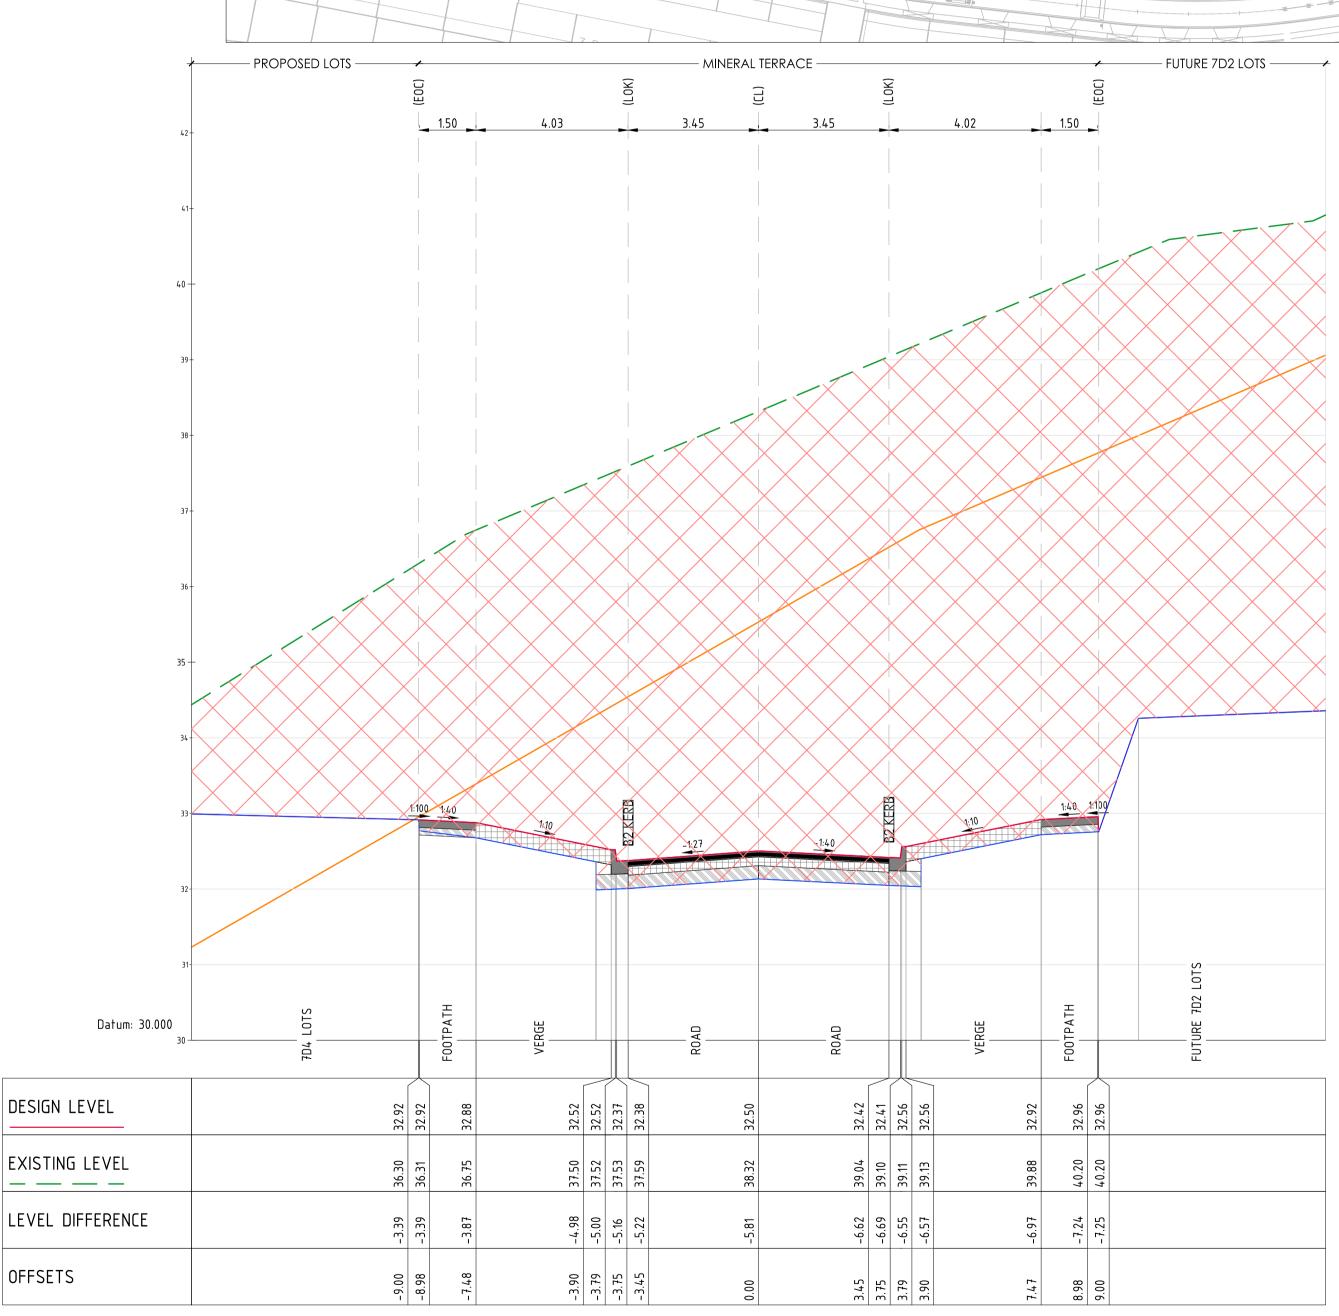Number 5107





Datum: 30.000 DESIGN LEVEL 32.71 32.71 32.56 32.56 32. 32. 32. EXISTING LEVEL 38.74 38.80 38.81 38.83 35.96 39.88 37.11 37.14 37.15 37.22 39.57 LEVEL DIFFERENCE -2.86 -6.13 -6.20 -6.06 -6.08 -9.00 -3.90 -3.79 -3.75 -3.45 3.45 3.75 3.79 3.90 8.98

MINERAL TERRACE

OFFSETS

AL - MINERAL TERRACE - CL - HA CHAINAGE 280.00 SCALE HORIZ. 1:100 SCALE VERT. 1:50 (X2)

PROPOSED LOTS —

0 18.09.23 ISSUED FOR CONSTRUCTION
Revision Date Reason

DESIGN LEVEL

EXISTING LEVEL

OFFSETS

Note for Contractors

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AL - MINERAL TERRACE - CL - HA CHAINAGE 270.00

SCALE HORIZ. 1:100

SCALE VERT. 1:50 (X2)

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DENOTES ENGINEERED FILL TO T+T TYPE 2 SPECIFICATION (1000780.1000.S1.REV4) AND PREPARED UNDER LEVEL 1 SUPERVISION. (AS PART OF EARLY WORKS).

DENOTES EXTENT OF CUT (AS PART OF EARLY WORKS)

Yourland CJ ARMS

Developments







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CROSS SECTIONS - MINERAL TERRACE (SHEET 9 OF 15) YOURLAND FOR CONSTRUCTION 1:100H, 1:50V @ A1 18.09.23

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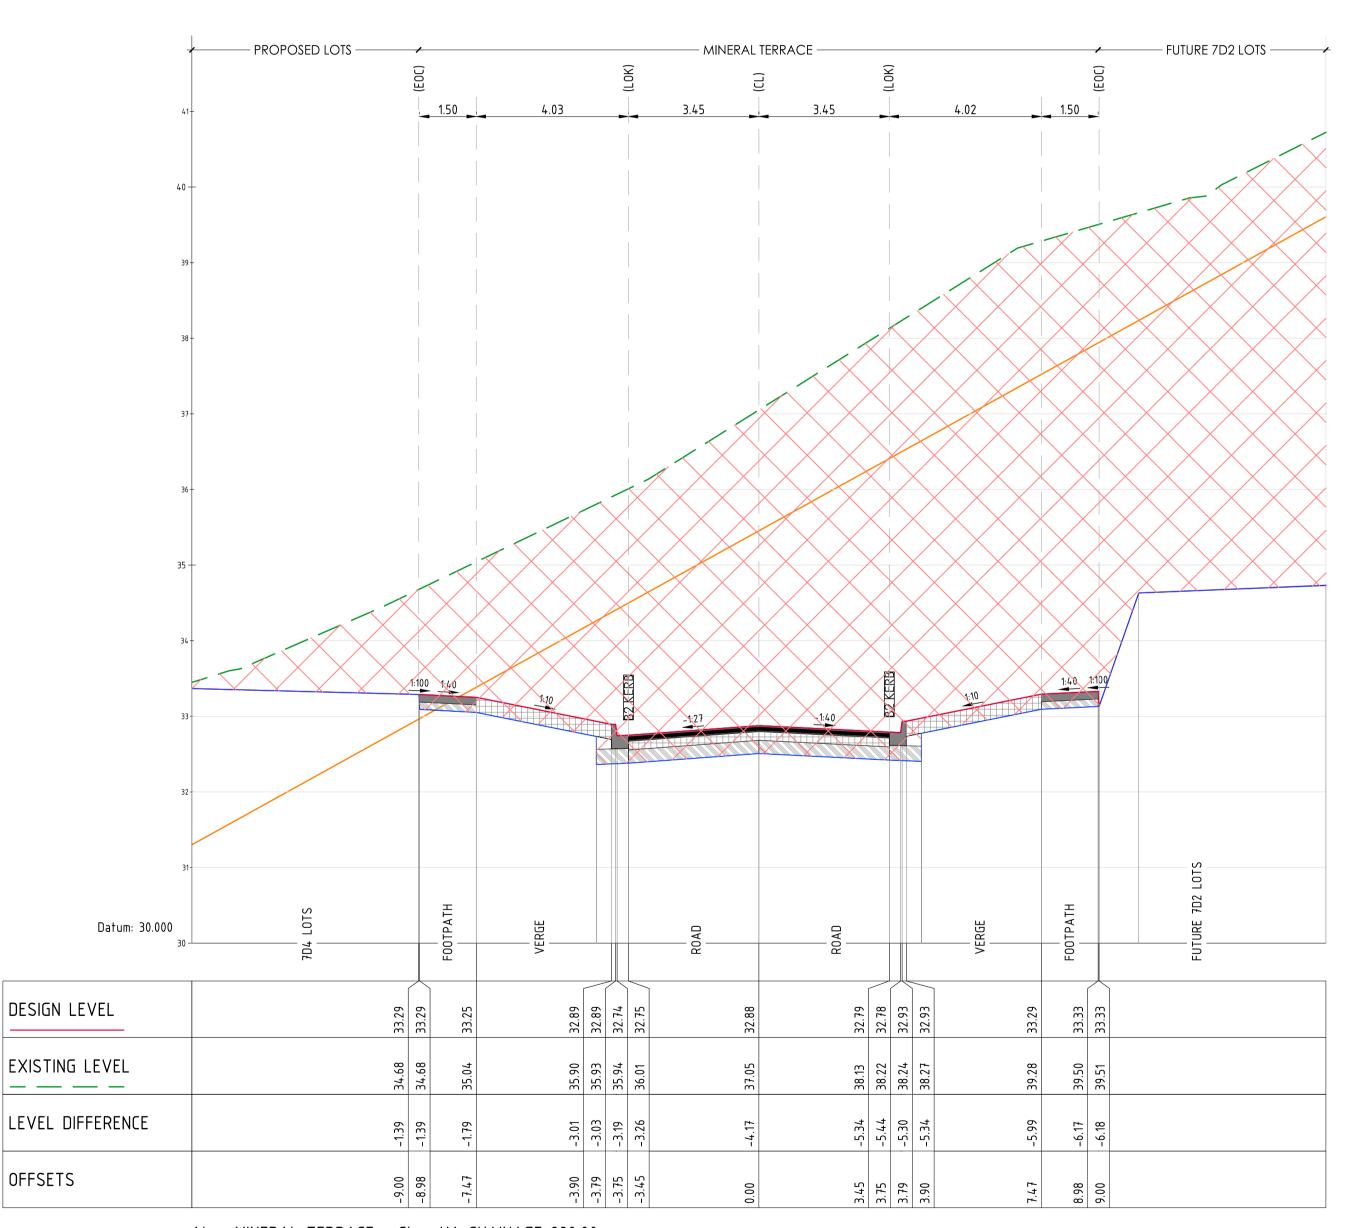
DR

5108

− FUTURE 7D2 LOTS −−−−

FOR CONSTRUCTION





Datum: 30.000 DESIGN LEVEL 33.52 33.08 33.08 32.93 32.94 98 97 12 12 32. 33. EXISTING LEVEL 35.64 35.68 35.69 35.79 5 5 15 26 27 31 38.65 34. 38 38 38 LEVEL DIFFERENCE 17 19 19 56 60 76 85 OFFSETS -9.00 -3.90 -3.79 -3.75 -3.45 3.45 3.75 3.79 3.90

MINERAL TERRACE -

AL - MINERAL TERRACE - CL - HA CHAINAGE 300.00

SCALE HORIZ. 1:100 SCALE VERT. 1:50 (X2)

AL - MINERAL TERRACE - CL - HA CHAINAGE 290.00 SCALE HORIZ. 1:100

SCALE VERT. 1:50 (X2)

drawing.

 0
 18.09.23
 ISSUED FOR CONSTRUCTION

 Revision
 Date
 Reason

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DENOTES ENGINEERED FILL TO T+T TYPE 2 SPECIFICATION (1000780.1000.S1.REV4) AND PREPARED UNDER LEVEL 1 SUPERVISION. (AS PART OF EARLY WORKS). DENOTES EXTENT OF CUT (AS PART OF EARLY WORKS)

FOR CONSTRUCTION



– PROPOSED LOTS –



CIVIL SITEWORKS


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CROSS SECTIONS - MINERAL TERRACE Client YOURLAND (SHEET 10 OF 15)

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FOR CONSTRUCTION 1:100H, 1:50V @ A1 18.09.23 DR 5109 15006 CJA 7D4 XX

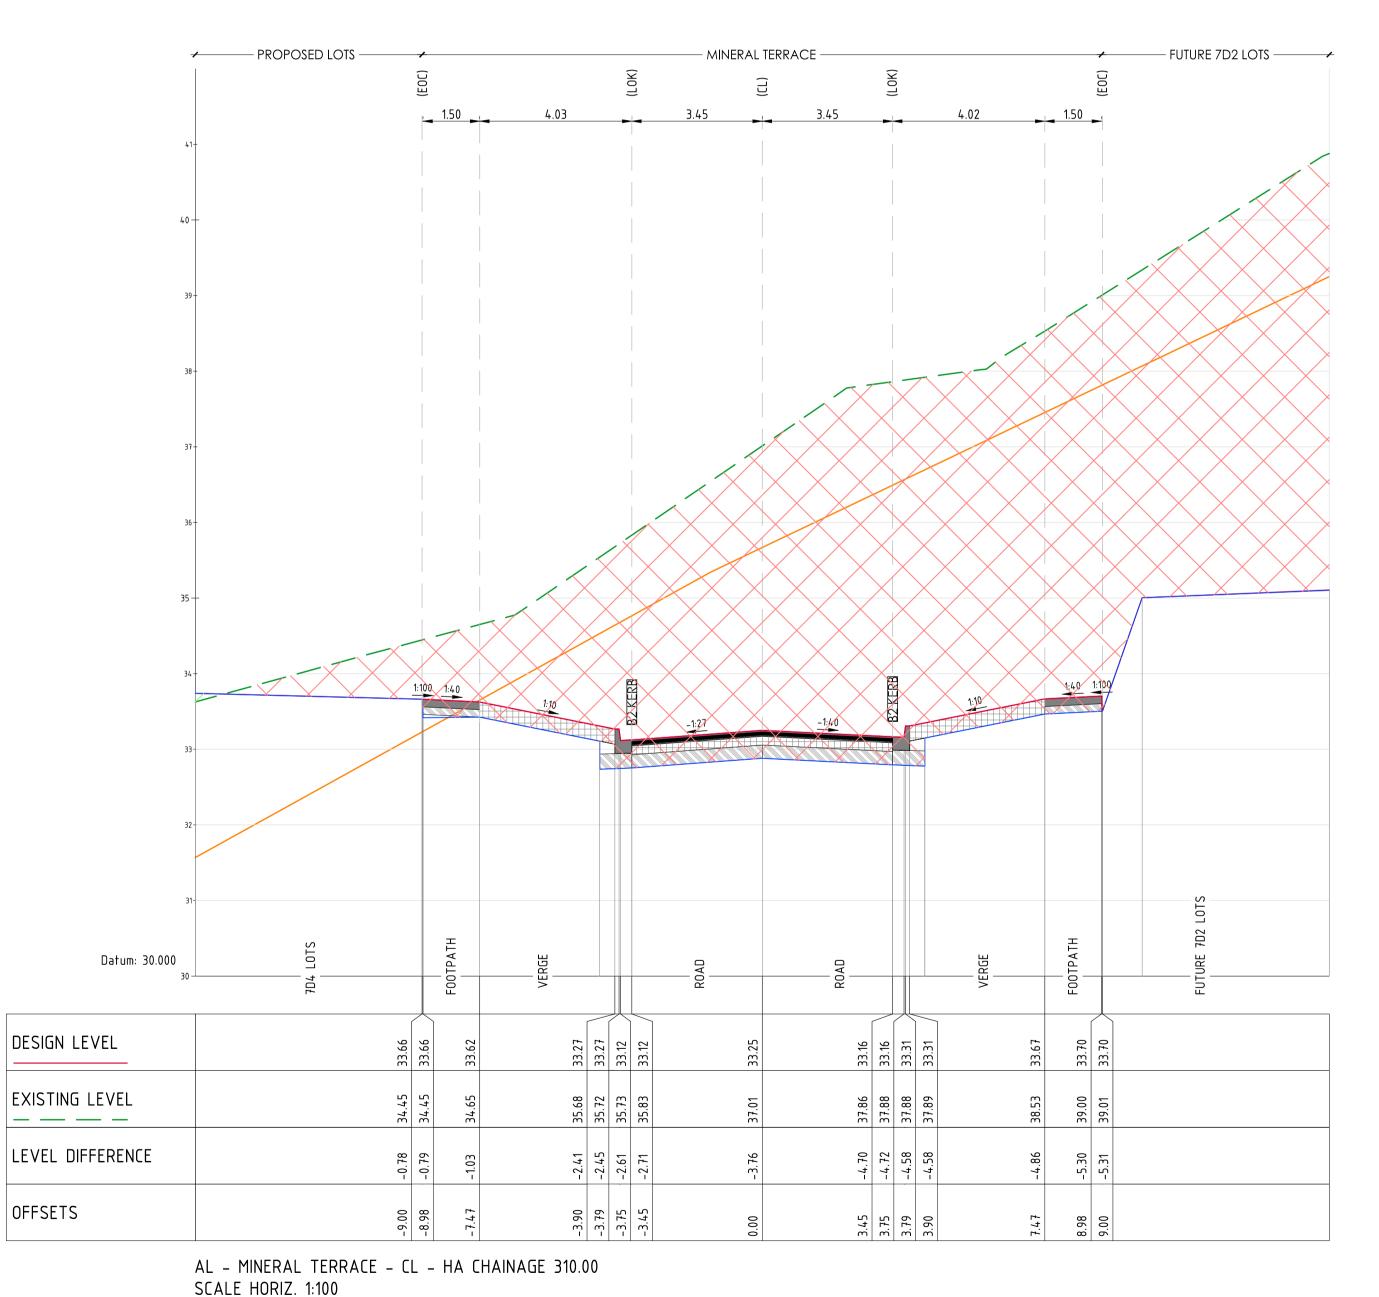− FUTURE 7D2 LOTS −−−−





SCALE HORIZ. 1:100 SCALE VERT. 1:50 (X2)

34.

AL - MINERAL TERRACE - CL - HA CHAINAGE 320.00

 0
 18.09.23
 ISSUED FOR CONSTRUCTION

 Revision
 Date
 Reason

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SCALE VERT. 1:50 (X2)

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DENOTES ENGINEERED FILL TO T+T TYPE 2 SI SUPERVISION. (AS PART OF EARLY WORKS). DENOTES ENGINEERED FILL TO T+T TYPE 2 SPECIFICATION (1000780.1000.S1.REV4) AND PREPARED UNDER LEVEL 1

DENOTES EXTENT OF CUT (AS PART OF EARLY WORKS)

FOR CONSTRUCTION





35.

-3.90 -3.79 -3.75 -3.45



– MINERAL TERRACE –



33.35 33.34 33.49 33.49

37.43 37.47 37.47 37.49

08 12 98 99

-4. -3.

3.45 3.75 3.79 3.90

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15006 CJA 7D4 XX

38.83

Project RIVER VALLEY - STAGE 7D4 Drawing Title
CROSS SECTIONS - MINERAL TERRACE Client YOURLAND (SHEET 11 OF 15) FOR CONSTRUCTION 1:100H, 1:50V @ A1 18.09.23

DR

— FUTURE 7D2 LOTS — ✓

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Datum: 30.000

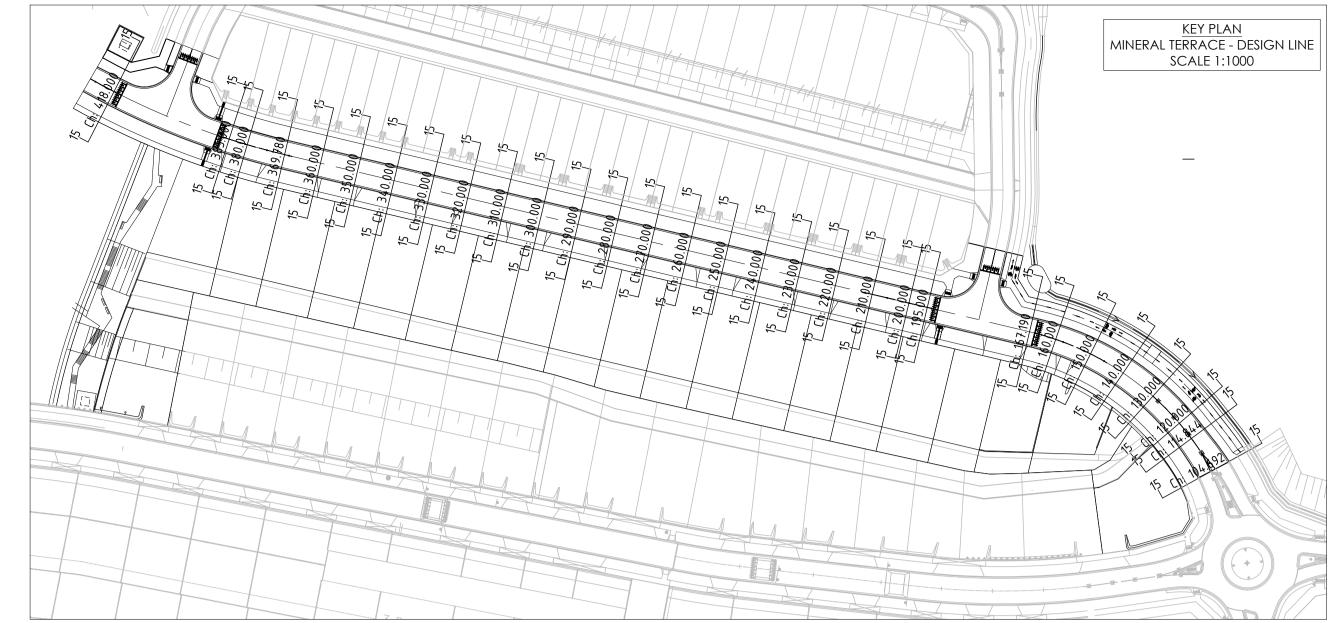
DESIGN LEVEL

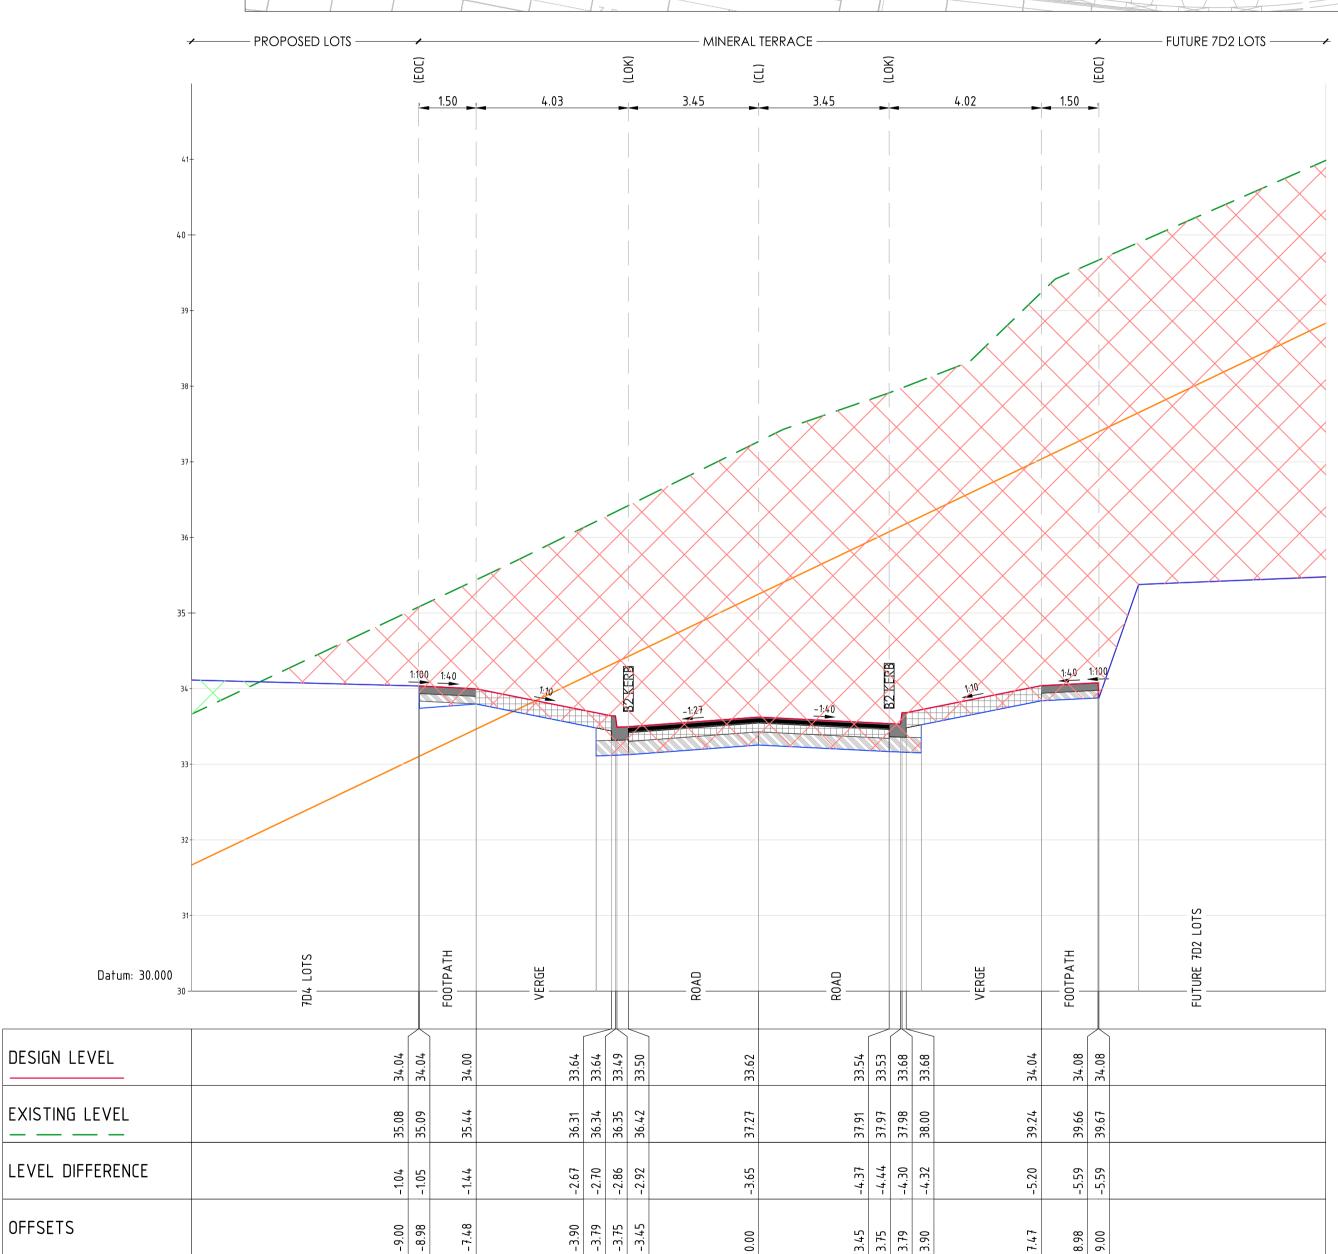
EXISTING LEVEL

_ _ _ _

OFFSETS

LEVEL DIFFERENCE





→ PROPOSED LOTS — - MINERAL TERRACE — − FUTURE 7D2 LOTS −−−− Datum: 30.000 DESIGN LEVEL 34.22 EXISTING LEVEL 35.53 39.56 39.90 39.91 36. 38 38. LEVEL DIFFERENCE -4.87 -4.95 -4.81 -4.84 -9.00 90 75 75 45 3.45 3.75 3.79 3.90

> AL - MINERAL TERRACE - CL - HA CHAINAGE 340.00 SCALE HORIZ. 1:100

SCALE VERT. 1:50 (X2)

OFFSETS

drawing.

SCALE HORIZ. 1:100

SCALE VERT. 1:50 (X2)

AL - MINERAL TERRACE - CL - HA CHAINAGE 330.00

Note for Contractors
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DENOTES EXTENT OF CUT (AS PART OF EARLY WORKS)

FOR CONSTRUCTION







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CROSS SECTIONS - MINERAL TERRACE Client YOURLAND (SHEET 12 OF 15) FOR CONSTRUCTION 1:100H, 1:50V @ A1 18.09.23

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5111

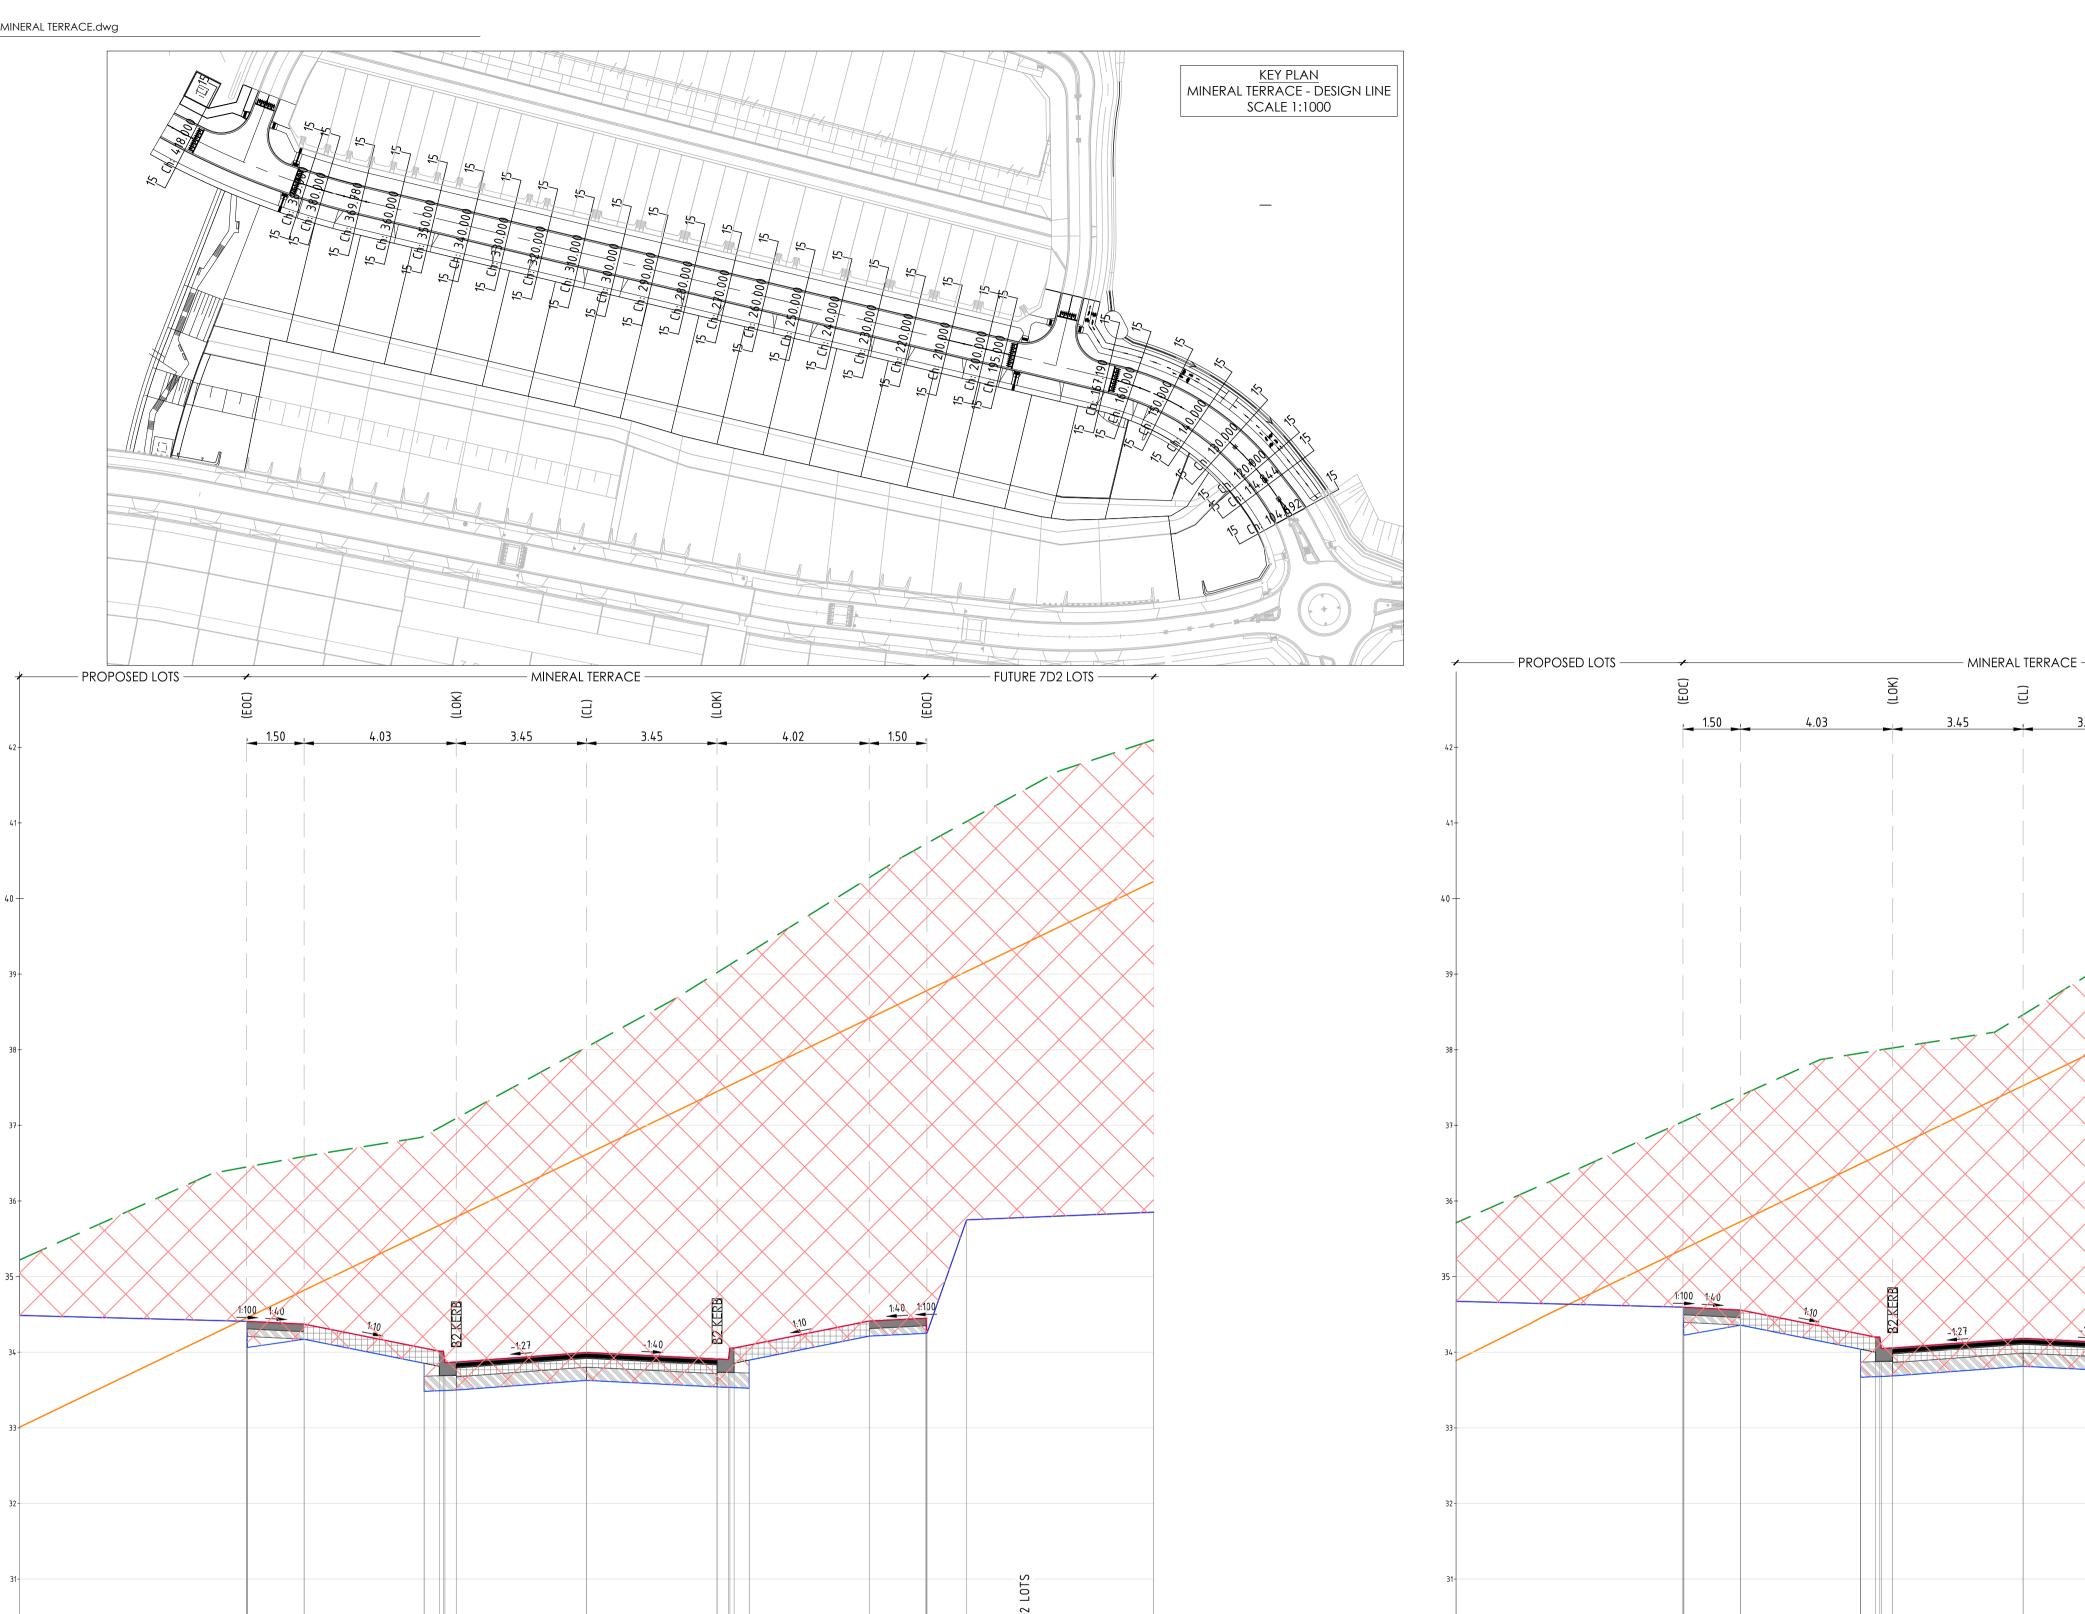
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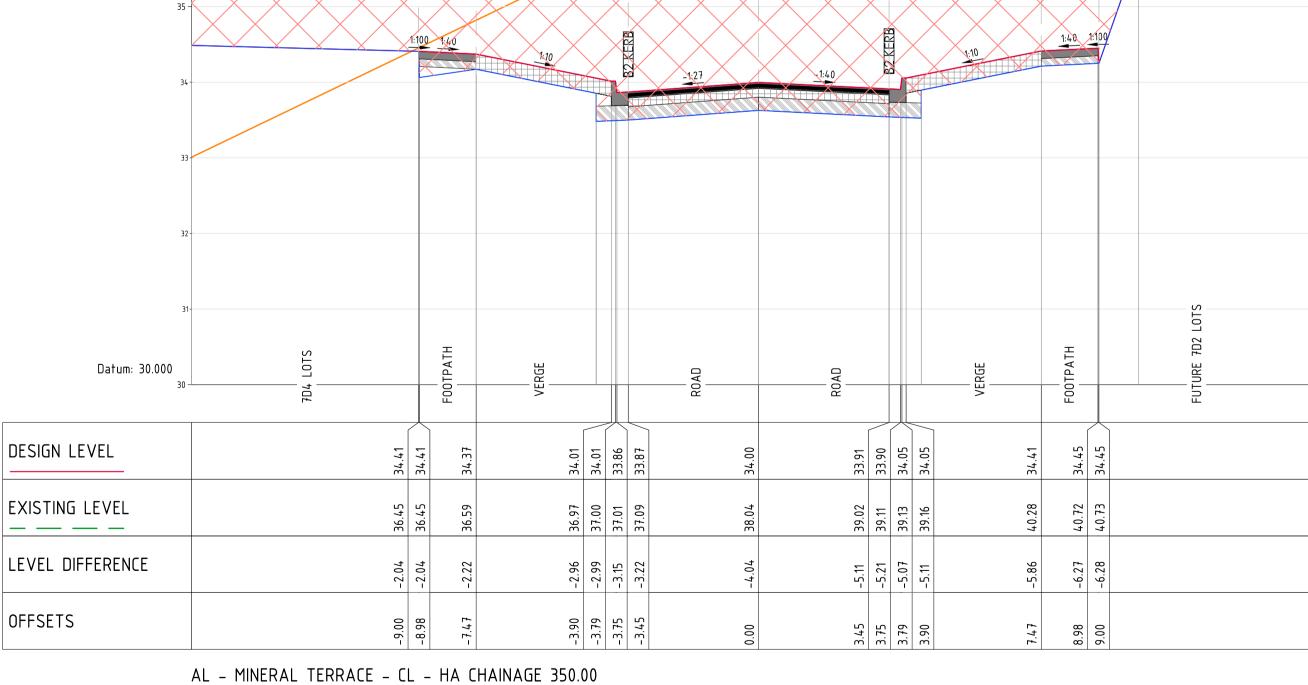
DESIGN LEVEL

EXISTING LEVEL

_ _ _ _ _

OFFSETS





-9.00 -3.90 -3.75 -3.75 AL - MINERAL TERRACE - CL - HA CHAINAGE 360.00

34.60

37.05

-2.45

SCALE HORIZ. 1:100 SCALE VERT. 1:50 (X2)

Datum: 30.000

DESIGN LEVEL

EXISTING LEVEL

LEVEL DIFFERENCE

OFFSETS



20 20 05 06

34.

99 00 00 02 02

34. 38. 38.

-3.79 -3.80 -3.95

15006 CJA 7D4 XX

34.64

-6.18

40.48

7.47 8.98 9.00

10 09 24 24

34. 34.

39.52 39.61 39.62 39.66

-5.42 -5.52 -5.38 -5.42

3.45 3.75 3.79 3.90

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CROSS SECTIONS - MINERAL TERRACE Client YOURLAND (SHEET 13 OF 15) FOR CONSTRUCTION 1:100H, 1:50V @ A1 18.09.23

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FUTURE 7D2 LOTS —

 0
 18.09.23
 ISSUED FOR CONSTRUCTION

 Revision
 Date
 Reason

SCALE HORIZ. 1:100

SCALE VERT. 1:50 (X2)

Note for Contractors

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Dial before you dig. BEWARE OF UNDERGROUND SERVICES. The location of underground services are approximate only and their exact position should be proven on site. No guarantee is given that existing services are shown.

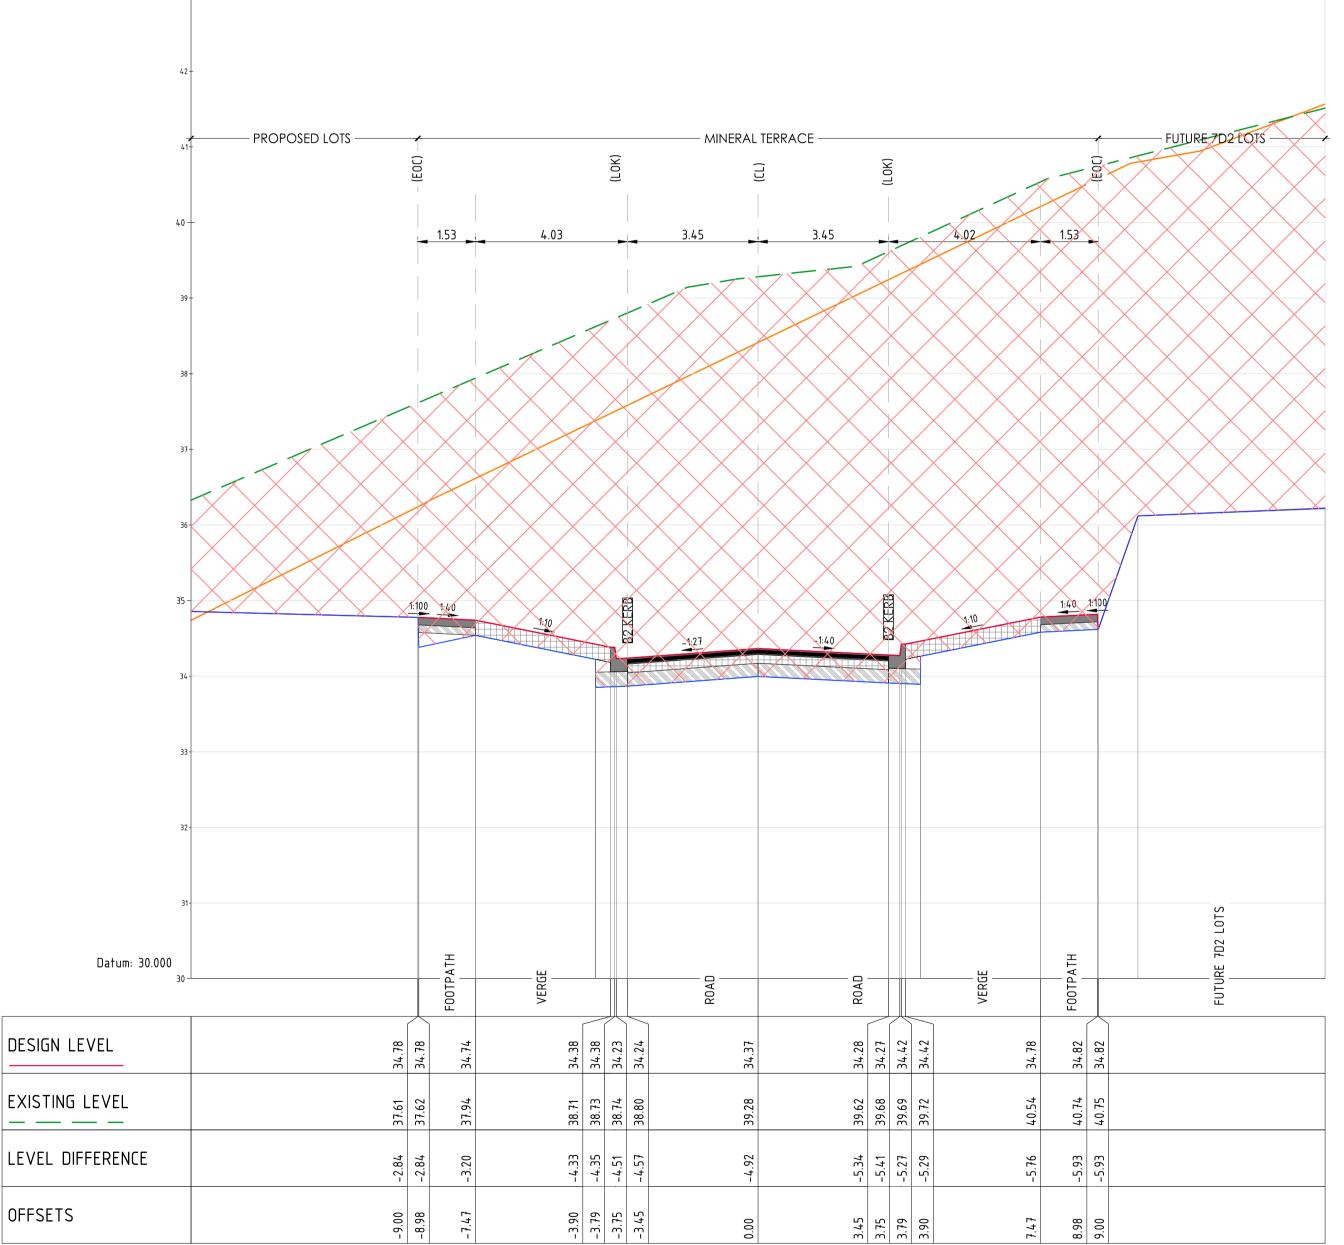
DENOTES EXTENT OF CUT (AS PART OF EARLY WORKS)

DENOTES ENGINEERED FILL TO T+T TYPE 2 SPECIFICATION (1000780.1000.S1.REV4) AND PREPARED UNDER LEVEL 1

FOR CONSTRUCTION

DENOTES ENGINEERED FILL TO T+T TYPE 2 SI SUPERVISION. (AS PART OF EARLY WORKS).





 PROPOSED LOTS -MINERAL TERRACE Datum: 30.000 34.97 34.57 34.57 34.42 34.43 34.47 34.46 34.61 34.61 35.01 EXISTING LEVEL 40.27 40.30 40.30 40.31 99 40. 39. 39. LEVEL DIFFERENCE -4.52 -4.54 -4.70 -4.75 -5.80 -5.83 -5.69 -5.70 -5.98 -9.00 -3.90 -3.79 -3.75 3.45 3.75 3.79 3.90 7.48 8.98 9.00

> AL - MINERAL TERRACE - CL - HA CHAINAGE 380.00 SCALE HORIZ. 1:100

SCALE VERT. 1:50 (X2)

DESIGN LEVEL

OFFSETS

AL - MINERAL TERRACE - CL - HA CHAINAGE 369.78

SCALE HORIZ. 1:100 SCALE VERT. 1:50 (X2)

DESIGN LEVEL

EXISTING LEVEL

OFFSETS

 0
 18.09.23
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 Date
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DENOTES EXTENT OF CUT (AS PART OF EARLY WORKS)

FOR CONSTRUCTION










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CROSS SECTIONS - MINERAL TERRACE (SHEET 14 OF 15) YOURLAND

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-3.90 -3.79 -3.75 -3.45 AL - MINERAL TERRACE - CL - HA CHAINAGE 418.00 SCALE HORIZ. 1:100 SCALE VERT. 1:50 (X2)

36.73

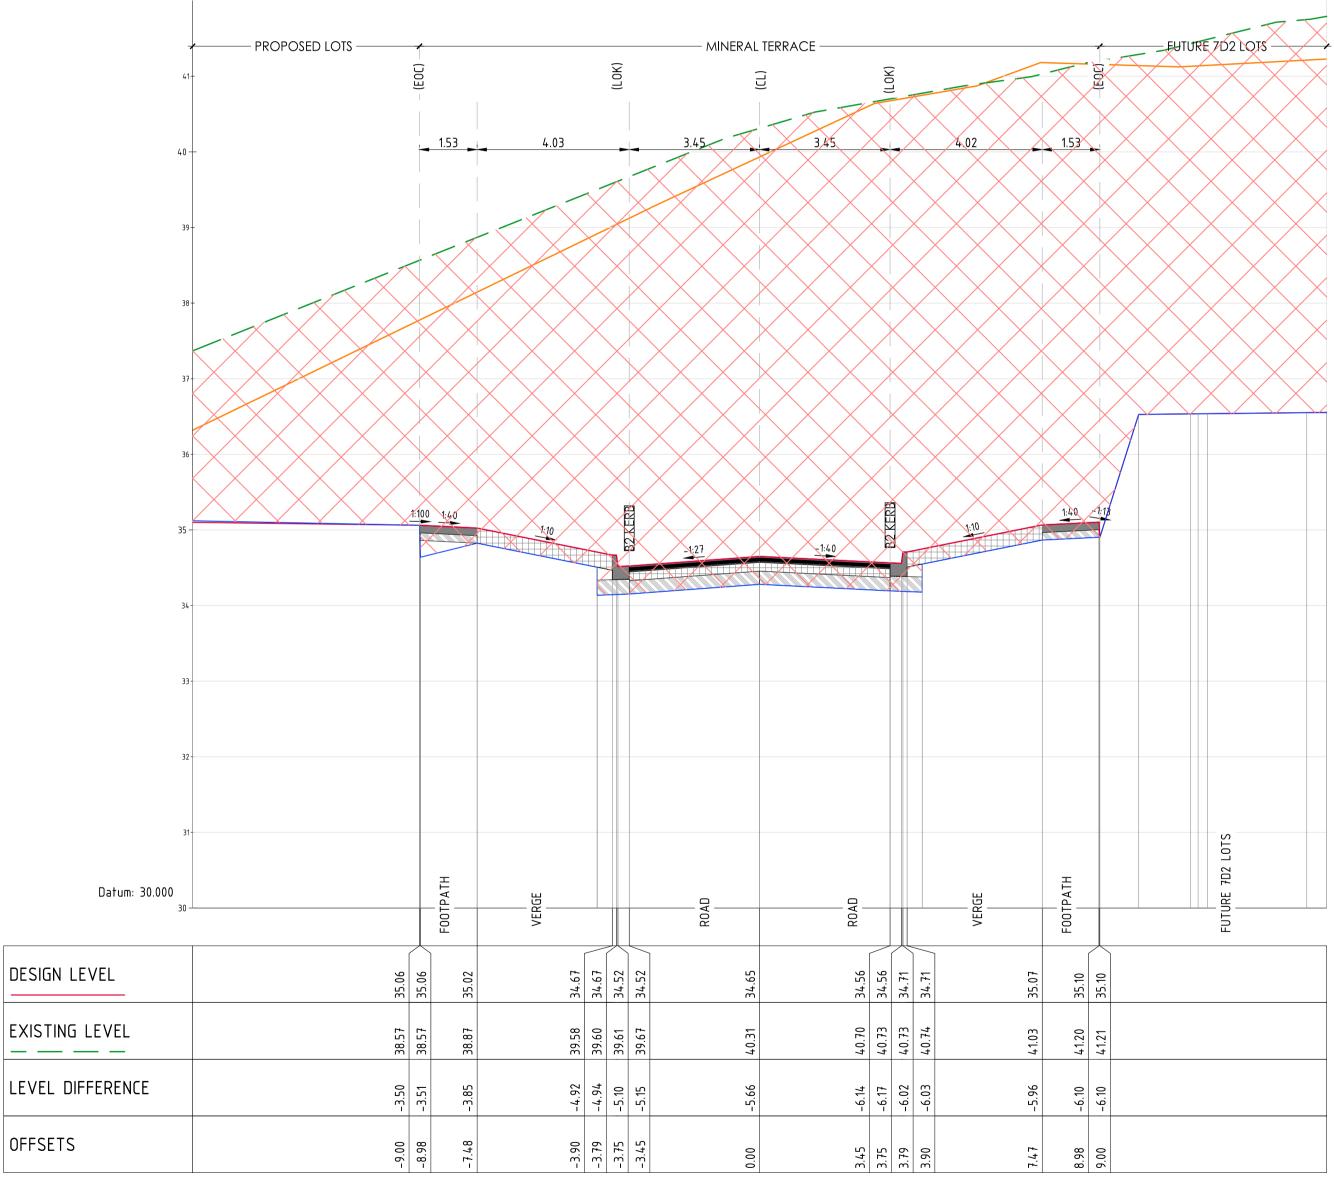Datum: 32.000

DESIGN LEVEL

EXISTING LEVEL

LEVEL DIFFERENCE

OFFSETS

AL - MINERAL TERRACE - CL - HA CHAINAGE 385.00 SCALE HORIZ. 1:100

SCALE VERT. 1:50 (X2)

 0
 18.09.23
 ISSUED FOR CONSTRUCTION

 Revision
 Date
 Reason

Note for Contractors

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DENOTES ENGINEERED FILL TO T+T TYPE 2 SI SUPERVISION. (AS PART OF EARLY WORKS). DENOTES ENGINEERED FILL TO T+T TYPE 2 SPECIFICATION (1000780.1000.S1.REV4) AND PREPARED UNDER LEVEL 1

DENOTES EXTENT OF CUT (AS PART OF EARLY WORKS)

FOR CONSTRUCTION





36.57 36.57 36.42 36.43

42.97 42.98 42.98 43.01

-6.40 -6.56 -6.58





3.45 3.75 3.79 3.90

FOR CONSTRUCTION

15006 CJA 7D4

MELBOURNE SYDNEY
T: +61 3 9285 2800 | T: +61 2 8036 8370 | E: info@cjarms.com | W: www.cjarms.com Project RIVER VALLEY - STAGE 7D4 Client YOURLAND (SHEET 15 OF 15)

XX


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1:100H, 1:50V @ A1 18.09.23
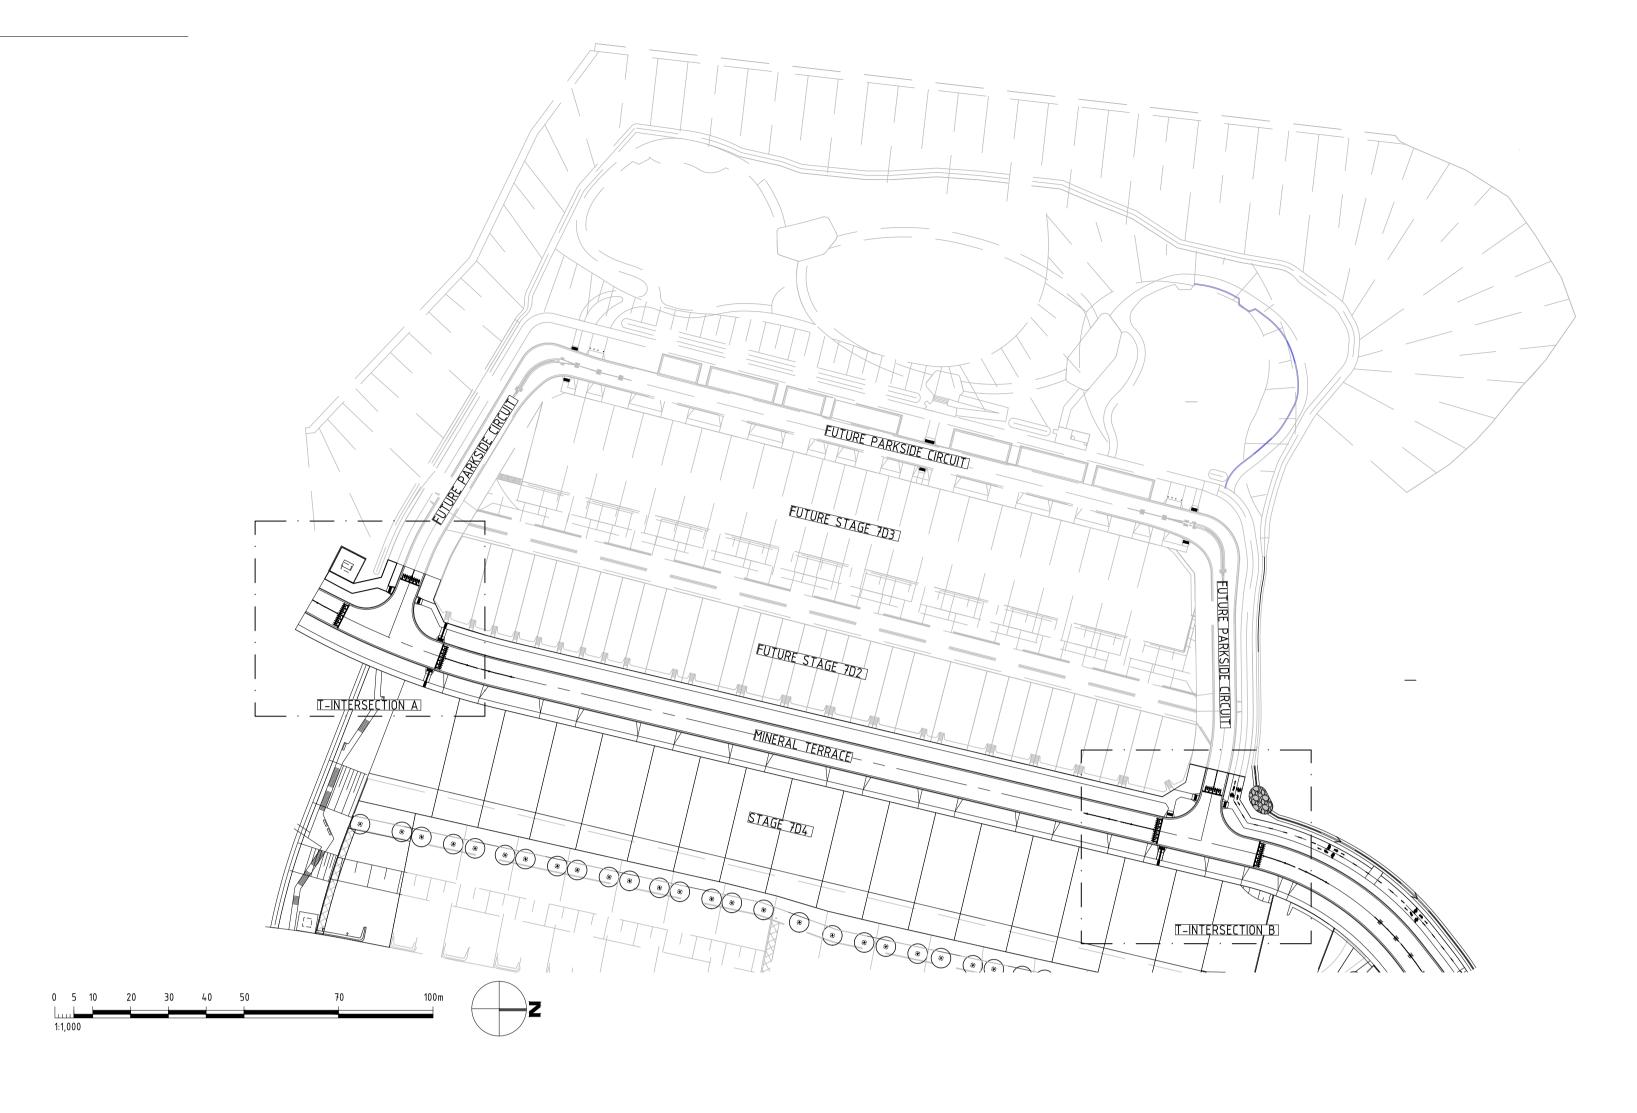
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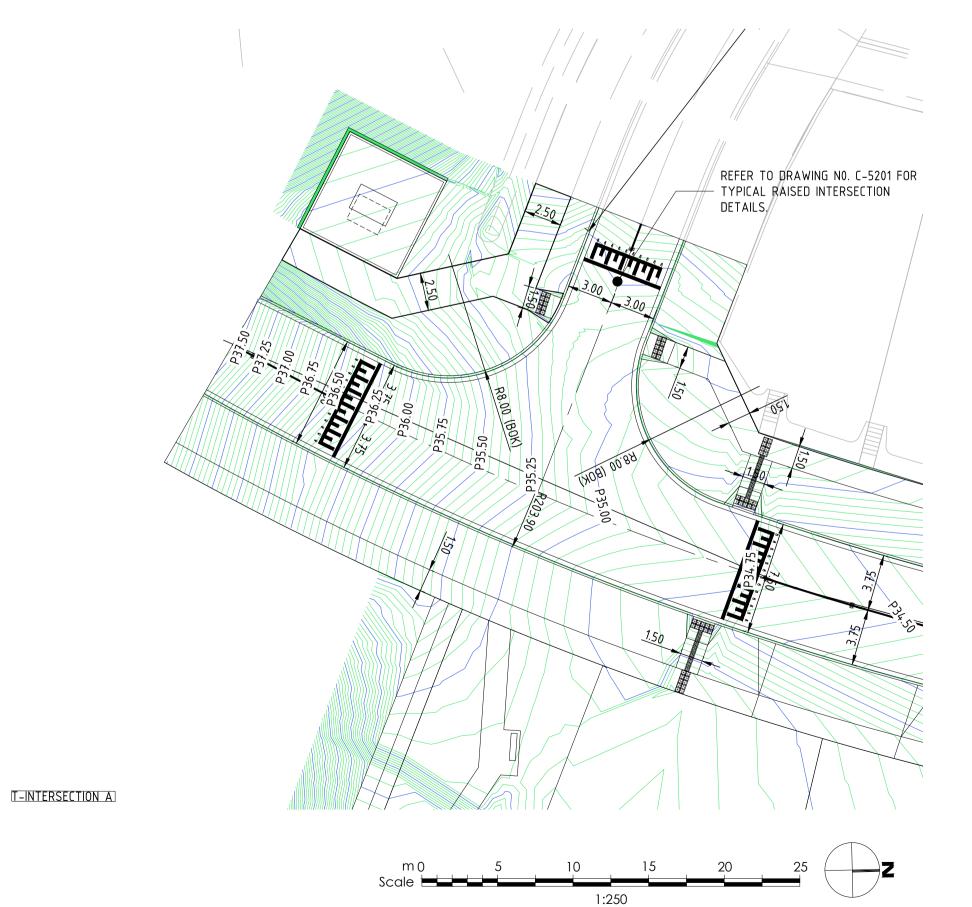
CIVIL SITEWORKS Drawing Title
CROSS SECTIONS - MINERAL TERRACE





0.05m CONTOUR INTERVALS ARE SHOWN FOR THE INTERSECTIONS

GIVEWAY LINE MARKING ARE REMOVED

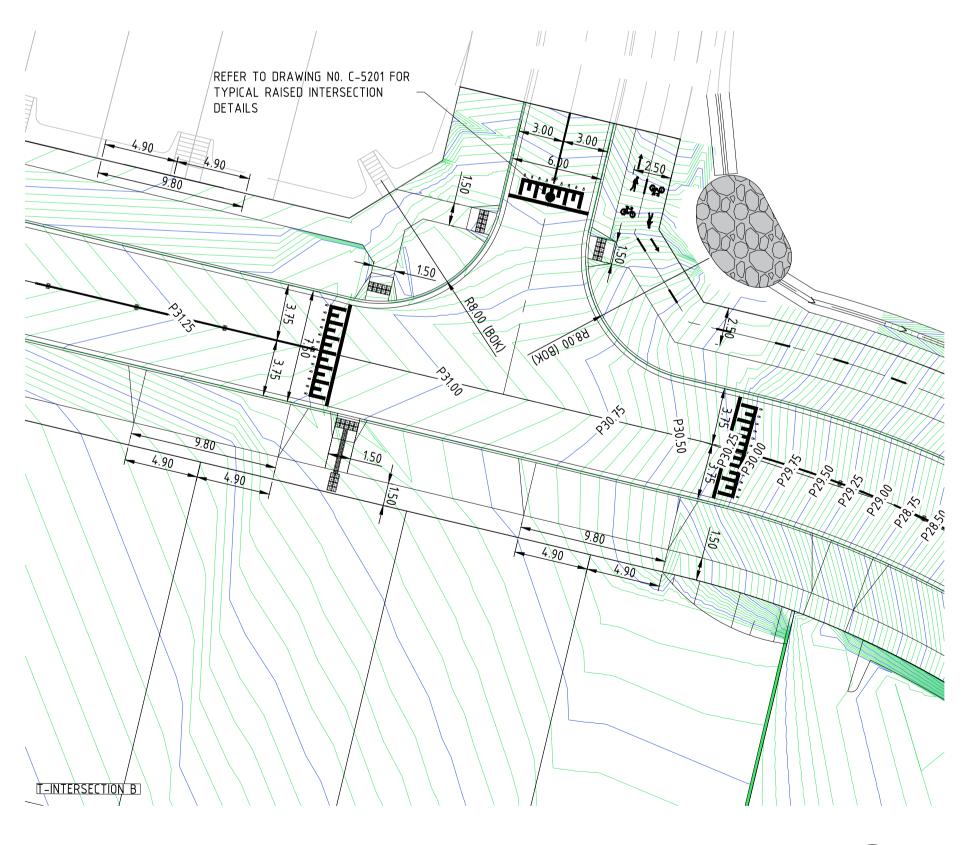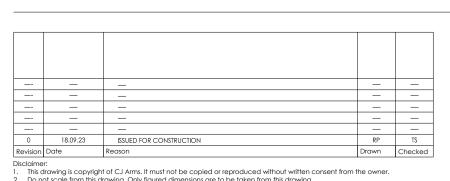CONTOUR INTERVALS ARE NOW REFLECTING THE RAISED INTERSECTIONS







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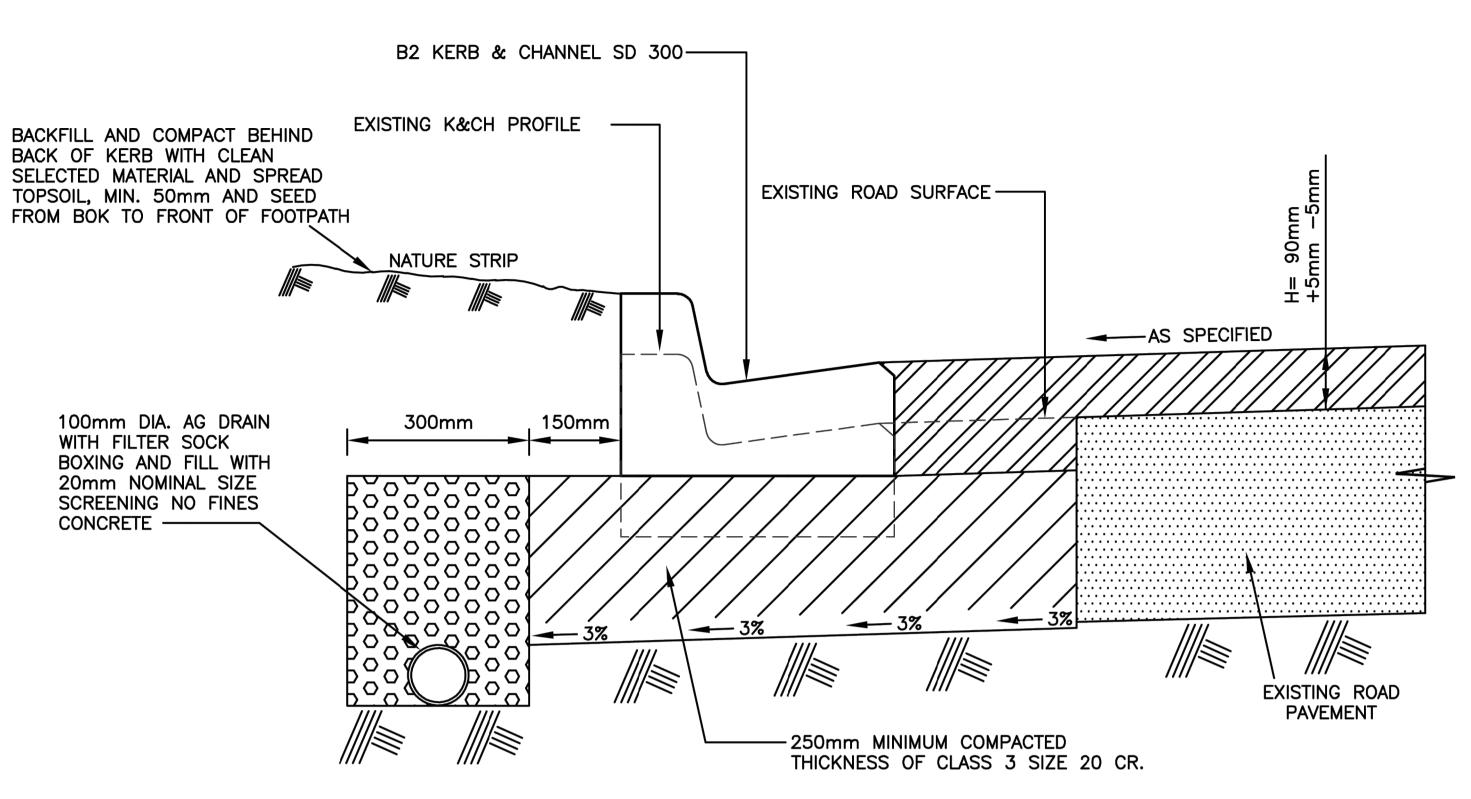
S		CIVIL SITEWORKS MELBOURNE T: (03) 9285 2800 E:info@cjarms.co			
	Project RIVER V. Client YOURLA	ALLEY - STAGE 7D4		Drawing Title INTERSECTIO	DN PLANS
	Purpose of Iss	· · -	Drawn By RP	Checked By	Drawn Scale AS SHOWN @ A

15006 CJA 7D4 XX

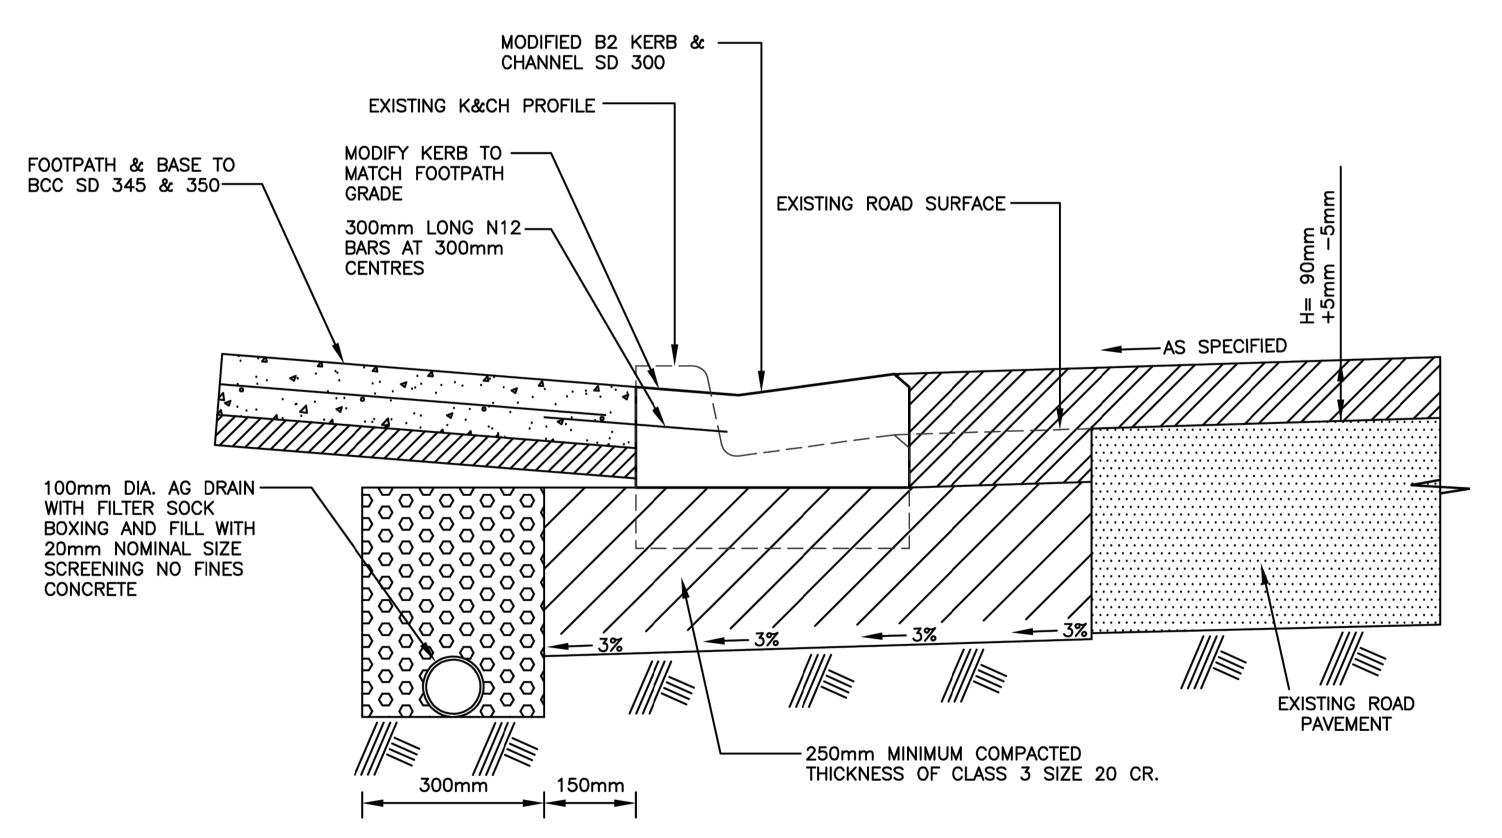
DR

Number **5200**


www.cjarms.com




TYPICAL ROAD HUMP DETAIL **SECTION A-A**




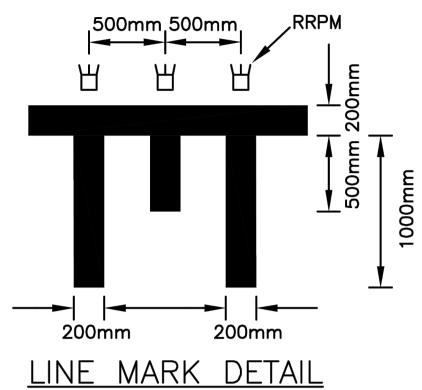TYPICAL ROAD HUMP DETAIL AT PRAM RAMP SECTION B-B




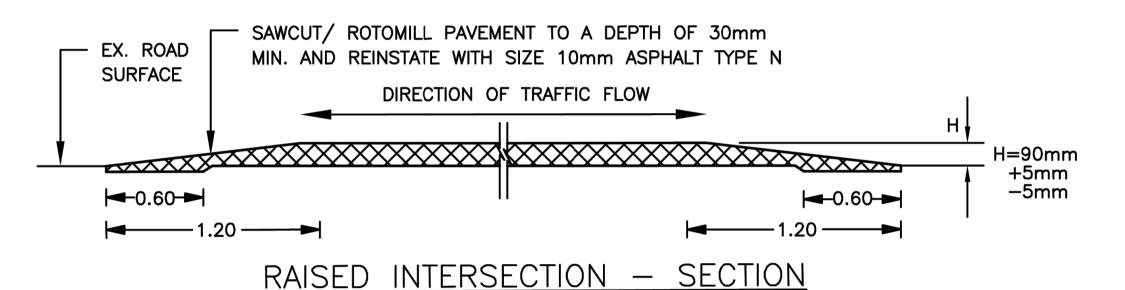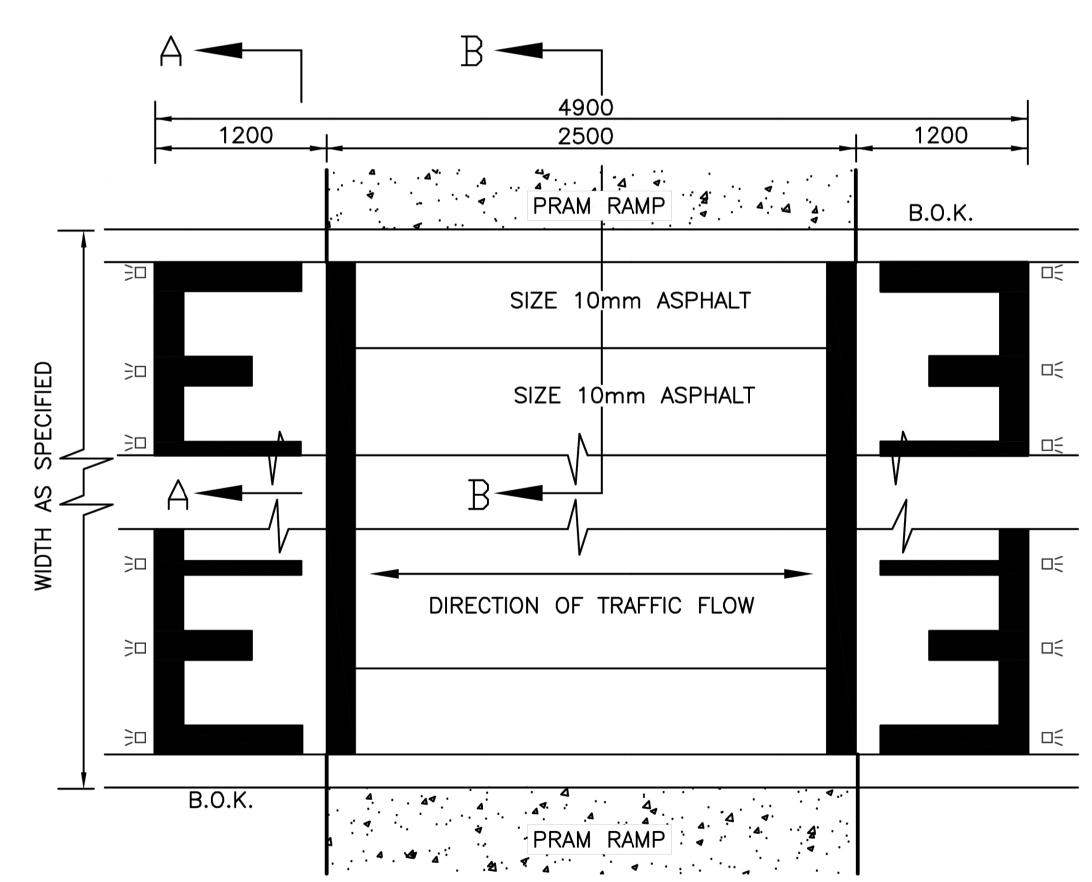- 1. STANDARD ROAD HUMP WARNING SIGNS, ROAD MARKERS AND RRPM's ARE REQUIRED TO SUPPLEMENT THE INSTALLATION OF ROAD HUMPS IN ACCORDANCE WITH THE CURRENT VICROADS TRAFFIC ENGINEERING MANUAL VOL - 1, CHAPTER 8
- 2. DIMENSIONS OTHER THAN SPECIFIED TO BE APPROVED BY COUNCIL'S TRAFFIC MANAGEMENT SECTION





RAISED PAVEMENT - PLAN

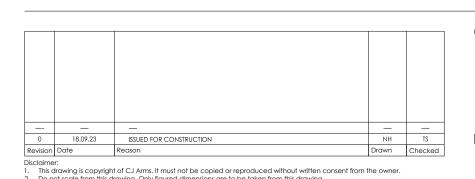

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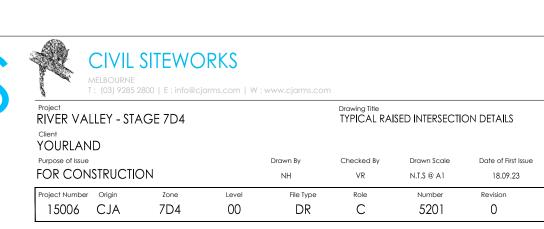
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FOR CONSTRUCTION








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competent Contractors with an appropriate level,
experience who have prepared appropriate Safe
Method Statements (SWMS) relating to these works
contractor is responsible for the management of al
associated with the construction activities stated o

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drawing.
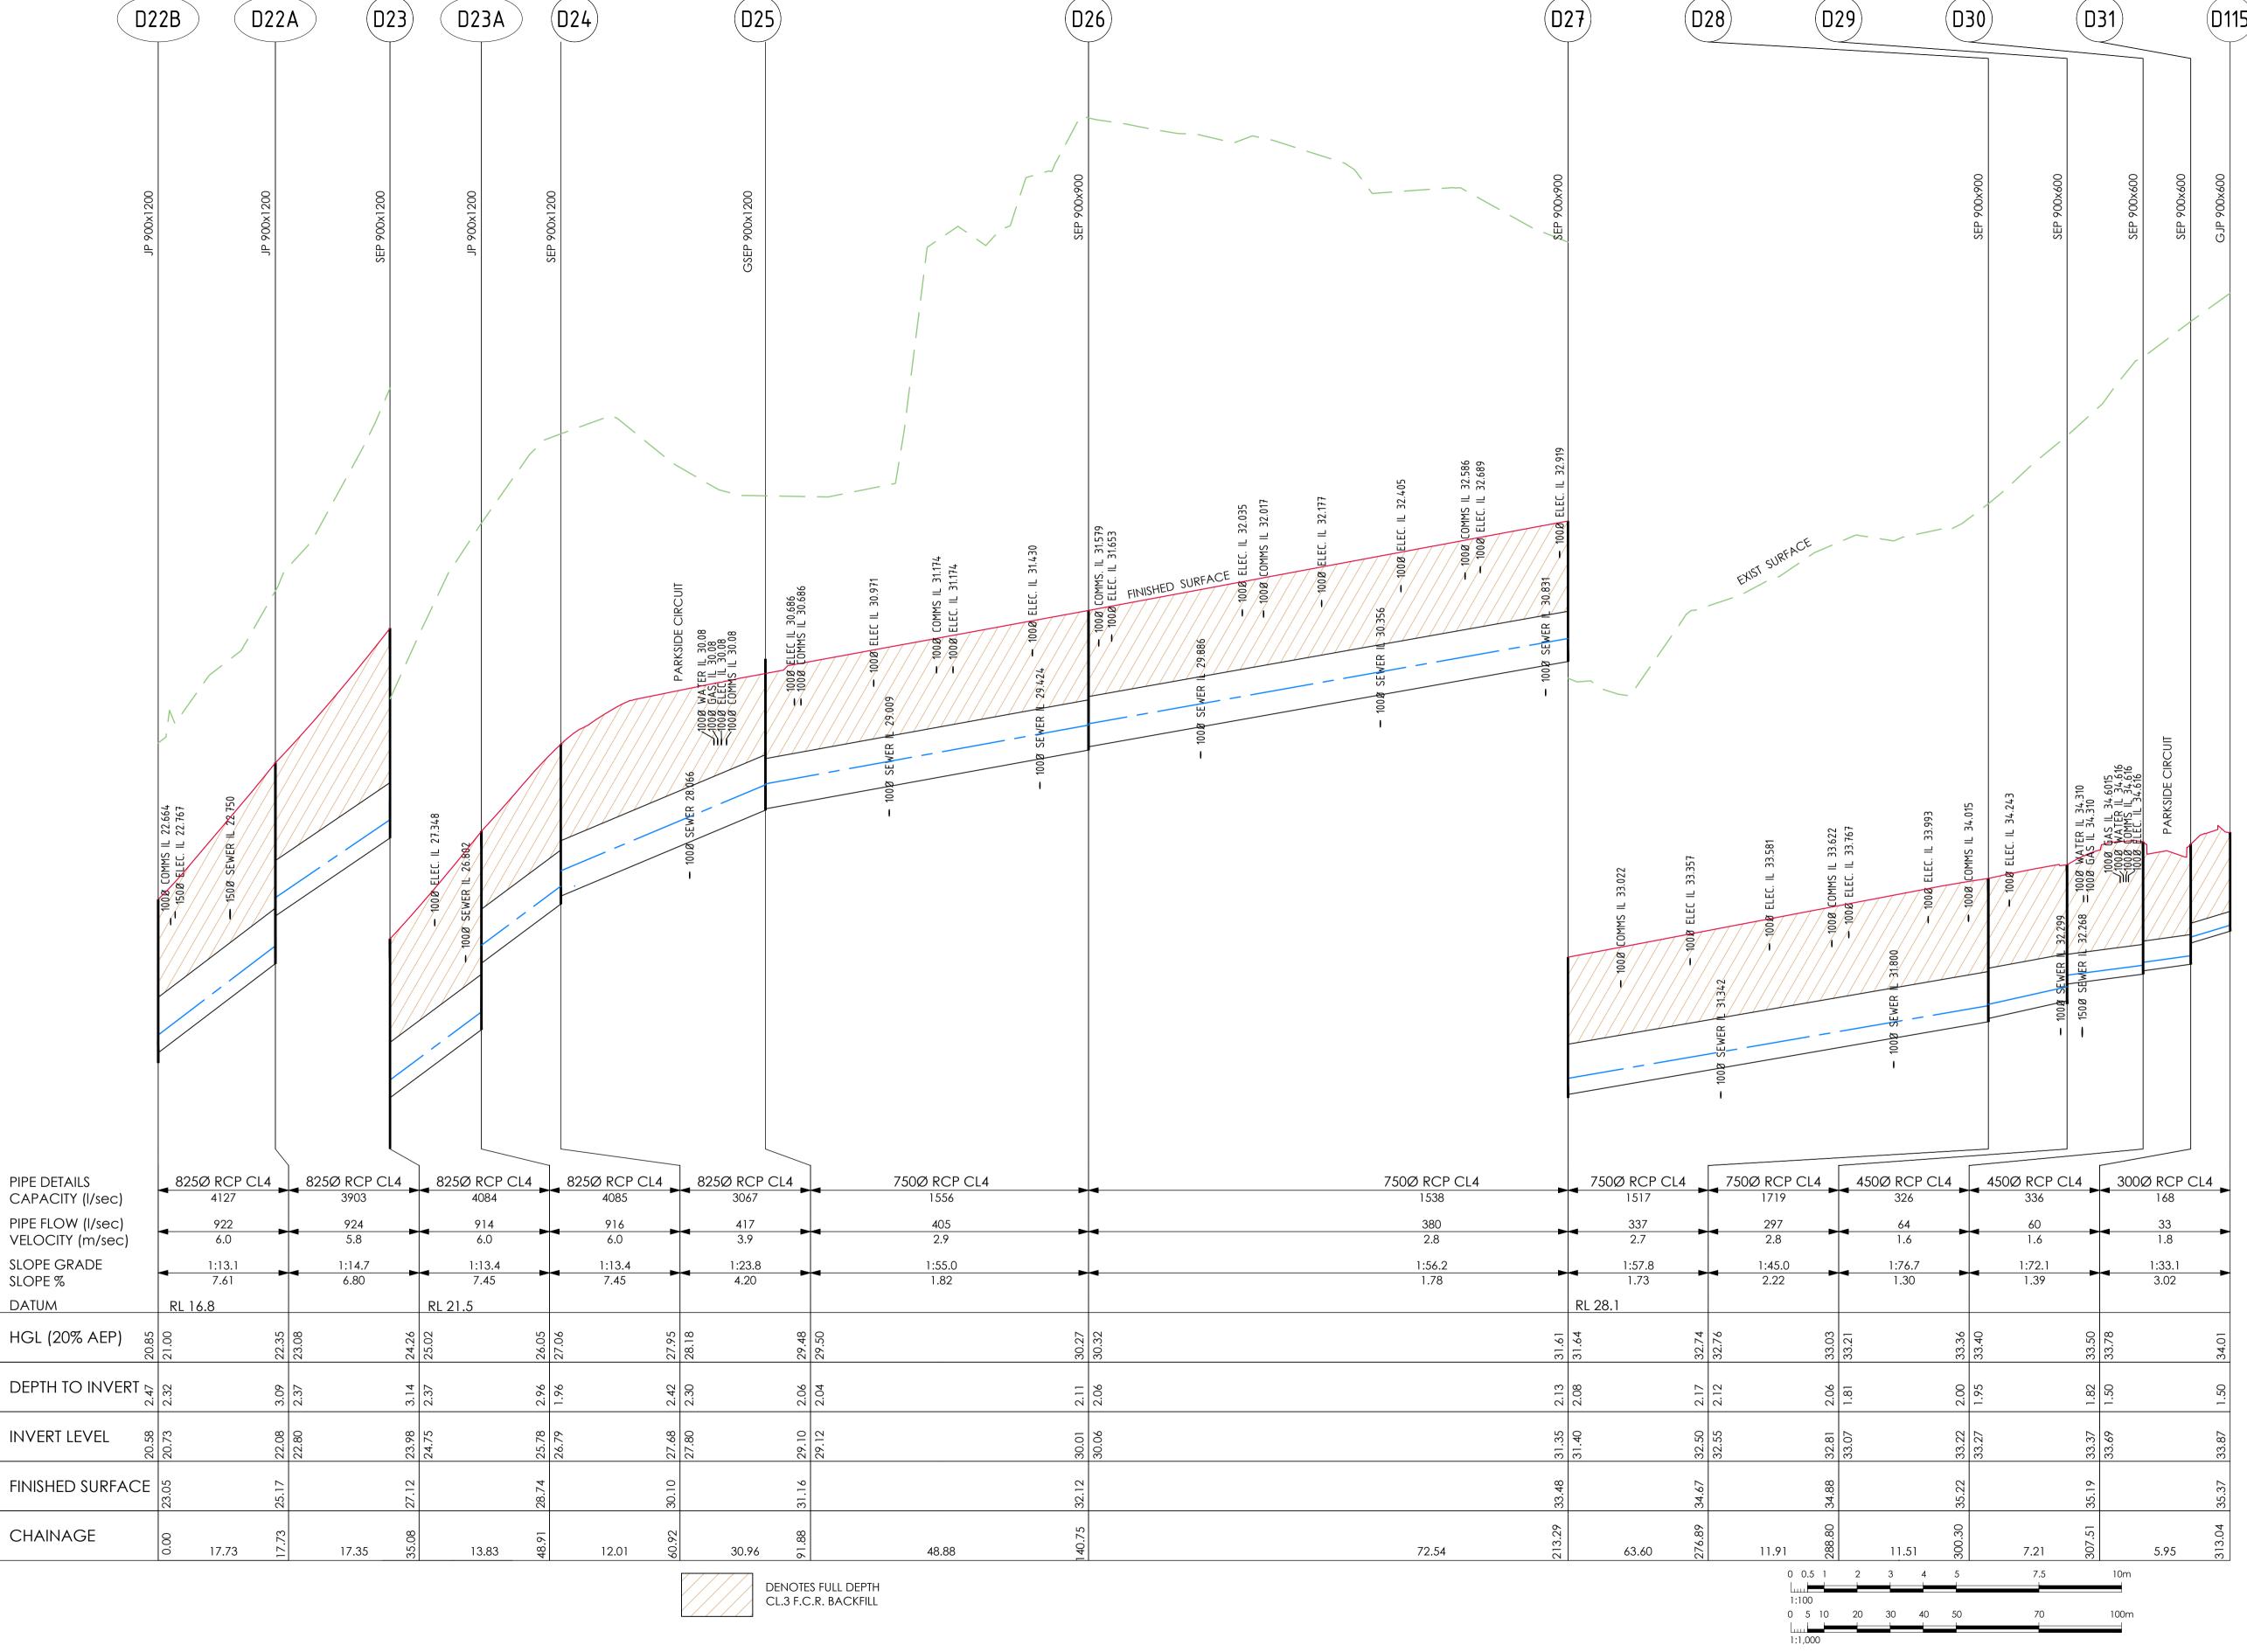
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FOR CONSTRUCTION



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		Project RIVER VA	۱LL


	CIVIL SITEWORKS MELBOURNE T: (03) 9285 2800 E:info@cjarms.com W:www.cjarms.com	
Project RIVER V	ALLEY - STAGE 7D4	Drawing Title PROPOSED STORMWATER LONG SECTIONS
Client YOURLA	ND	(SHEET 1 OF 3)

1:1000H, 1:100V @ A1 18.09.23

6100

Plot Date

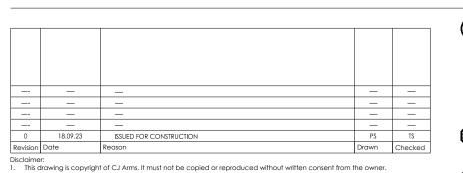(D23) 300Ø RCP CL4 525Ø RCP CL4 450Ø RCP CL4 375Ø RCP CL4 375Ø RCP CL4 375Ø RCP CL4 300Ø RCP CL4 300Ø RCP CL4 300Ø RCP CL4 735 233 1.0 2.6 2.2 1:56.6 1.77 1:53.7 1:56.6 1:49.3 1:63.4 2.67 1.77 1.86 2.66 2.03 1.58 9.93 6.42 RL 22.2 9.00 30.83 63.72 51.50 62.28 47.29 9.50 7.89 8.36 DENOTES FULL DEPTH CL.3 F.C.R. BACKFILL



PIPE DETAILS

SLOPE GRADE

DATUM RL 25

HGL (20% AEP)

INVERT LEVEL

CHAINAGE

DEPTH TO INVERT

FINISHED SURFACE

SLOPE %

CAPACITY (I/sec)

PIPE FLOW (I/sec) VELOCITY (m/sec)

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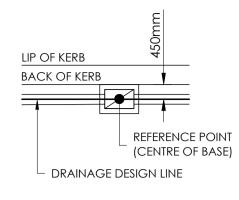
	CIVIL SITEWORKS MELBOURNE T: (03) 9285 2800 E: info@cjarms.com W: www.cjarms.com							
Project RIVER V	ALLEY - STAGE 7D4		Drawing Title PROPOSED STORMWATER LONG SECTIONS					
Client YOURLA	ND		(SHEET 2 OF	(SHEET 2 OF 3)				
Purpose of Issu	ie .	Drawn By	Checked By	Drawn Scale	Date of First Issue			

File Type DR


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FOR CONSTRUCTION

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DETAIL A PIT SET-OUT POINT SCALE 1:100



HAUNCHED PIT SET-OUT POINT PITS TO BE HAUNCHED BEHIND BACK OF KERB UNLESS NOTED OTHERWISE. SCALE 1:100

		D37) D30)	DJI) CAI	DITO CAI
SEP 900x600		SEP 900x1200 GJP 900x900 SEP 900x600 SEP 900x600	SEP 900x600	OOO SEP 900x600
	PROVIDE ANCHOR BLOCK REFER COUNCIL STANDARD DRG \$120	PARKSIDE CIRCUIT	PROVIDE ANCHOR BLOCK REFER COUNCIL STANDARD DRG \$120	TOOG GAS IL 34.506 TOOG GAS IL 34.506 BELEC. IL 34.506 ANCHOLE BROCKIT TOOG ELEC. IL 34.506 ANCHOLE BROCK S150 ANCHOLE BROCK ANCHOLE BROCK S150 ANCHOLE BROCK ANCHOLE BROCK S150 ANCHOLE BROCK ANCHOLE BRO
PIPE DETAILS CAPACITY (I/sec) PIPE FLOW (I/sec) VELOCITY (m/sec) SLOPE GRADE SLOPE % DATUM RL 26.4	375Ø RCP CL4 546 266 4.9 1:10.3 9.70	450Ø RCP CL4	300Ø RCP CL4 224 21 2.6 1:8.9 11.25 RL 30.2	750Ø RCP CL4 1634 217 203 2.5 4.5 1:49.8 2.01 RL 29.5
HGL (20% AEP)	30.38		33.57	33.02
DEPTH TO INVERT				
INVERT LEVEL	00 1.76	48 1.81 16 0.70 18 0.68 66 1.85 68 1.83		32 2.05 33 3.09 88 3.04 77 3.01
	30.20		33.52	33.38 33.38 33.17
FINISHED SURFACE	31.46	30.29	35.19	34.87
CHAINAGE	5.16	0	0.0 5.53 £3.5 §5.5 §5.5 §5.5 §5.5 §5.5 §5.5 §5.5 §	0 7.12 8 0 25.41 9 7.12 8
	35			

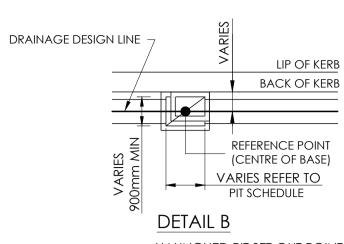FOR CONSTRUCTION

(D38)

(D31)

(D37)


	Pit Schedule													
Pit No.	Pił Type	Lid Width	Lid Length	Base Width	Base Length	Outlet Diameter	Outlet Invert RL	Inlet Diameter	Inlet Invert RL	Pit Depth	Pit Lid Level	Easting	Northing	Comment
		(mm)	(mm)	(mm)	(mm)	(mm)	(m)	(mm)	(m)	(m)	(m)	(m)	(m)	
D22B	JP	600	900	1200	900	825	20.58	825	20.73	2.47	23.05	310321.22	5819149.36	PIT DETAIL TO BCC \$205/\$255 (HAUNCHED)
D22A	JP	600	900	1200	900	825	22.08	825	22.80	3.04	25.12	310307.28	5819138.39	PIT DETAIL TO BCC \$205/\$255 (HAUNCHED)
D23	SEP	600	900	1200	900	825	23.98	825	24.75	3.17	27.15	310295.97	5819125.24	PIT DETAIL TO BCC \$200/\$255 (HAUNCHED)
								300	25.48					
D23A	JP	600	900	1200	900	825	25.78	825	26.79	2.96	28.78	310289.28	5819113.14	PIT DETAIL TO BCC \$205/\$255 (HAUNCHED)
D24	SEP	600	900	1200	900	825	27.68	825	27.80	2.42	30.12	310285.39	5819101.76	PIT DETAIL TO BCC \$200/\$255 (HAUNCHED)
								450	28.48					
								525	28.28					
D25	GSEP	600	900	1200	900	825	29.10	750	29.12	2.06	31.16	310278.30	5819071.64	PIT DETAIL TO BCC \$201/\$255 (HAUNCHED)
D26	SEP	600	900	900	900	750	30.01	750	30.06	2.11	32.12	310266.99	5819024.09	PIT DETAIL TO BCC \$200/\$255 (HAUNCHED)
D27	SEP	600	900	900	900	750	31.35	750	31.40	2.13	33.48	310250.22	5818953.52	PIT DETAIL TO BCC \$200/\$255 (HAUNCHED)
D28	SEP	600	900	900	900	750	32.50	750	32.55	2.17	34.67	310235.27	5818891.70	PIT DETAIL TO BCC \$200/\$255 (HAUNCHED)
D29	SEP			600	900	750	32.81	450	33.07	2.07	34.88	310231.56	5818880.38	PIT DETAIL TO BCC \$200
								750	32.87					
D30	SEP			600	900	450	33.22	450	33.27	2.00	35.22	310220.57	5818876.98	PIT DETAIL TO BCC \$200
D31	SEP			600	900	450	33.37	300	33.69	1.82	35.19	310217.98	5818870.25	PIT DETAIL TO BCC \$200
								300	33.52					
D37	GJP	600	900	900	900	450	29.16	450	29.18	0.70	29.86	310276.94	5819100.06	PIT DETAIL TO BCC \$205/\$255 (HAUNCHED) WITH BASKET GRATE COVER
D38	SEP			600	900	450	29.66	375	29.70	1.85	31.51	310271.93	5819090.63	PIT DETAIL TO BCC \$200
								450	29.68					
D70	SEP			600	900	450	29.84			1.68	31.51	310270.25	5819083.63	PIT DETAIL TO BCC \$200 WITH TEMPORARY LETTERBOX OPENING AT REAR FOR SWALE
D72	SEP			600	900	525	28.52	450	28.72	1.54	30.06	310294.12	5819099.57	PIT DETAIL TO BCC \$200
D74	SEP			600	900	300	25.63			1.50	27.13	310303.83	5819119.90	PIT DETAIL TO BCC \$200
D104	GJP			600	900	450	29.54	375	29.56	1.62	31.17	310286.91	5819069.59	PIT DETAIL TO BCC \$232
D105	SEP			600	900	375	30.69	375	30.74	1.65	32.34	310272.16	5819007.61	PIT DETAIL TO BCC \$200
D106	SEP			600	900	375	31.65	375	31.70	1.65	33.30	310260.26	5818957.50	PIT DETAIL TO BCC \$200
D107	SEP			600	900	375	32.86	300	32.94	1.61	34.47	310245.84	5818896.91	PIT DETAIL TO BCC \$200
D108	SEP			600	900	300	33.90			2.70	36.60	310229.25	5818852.73	PIT DETAIL TO BCC \$200
D110	SEP	600	900	900	900	750	33.33	750	33.38	3.09	36.42	310221.51	5818857.04	PIT DETAIL TO BCC \$200/\$255 (HAUNCHED)
D115	GJP	600	900	900	900	300	33.87			1.50	35.37	310214.08	5818865.76	PIT DETAIL TO BCC \$205/\$255 (HAUNCHED)
D119	JP	600	900	900	900	600	16.30	600	16.31	2.25	18.55	310313.03	5818841.19	PIT DETAIL TO BCC \$205/\$255 (HAUNCHED)
								300	16.75					
D120	GJP	600	900	600	900	300	17.53	300	17.58	1.20	18.73	310305.15	5818841.59	PIT DETAIL TO BCC \$205/\$255 WITH BASKET GRATE COVER
D121	GJP	600	900	600	900	300	18.12			1.66	19.78	310299.76	5818847.98	PIT DETAIL TO BCC S205/S255 WITH BASKET GRATE COVER

PIT TYPE KEY

JP = JUNCTION PIT GJP = GRATED JUNCTION PIT SEP = SIDE ENTRY PIT GSEP = GRATED SIDE ENTRY PIT NOTES:

- 1. ALL SETOUT POINTS (COORDINATES) ARE TO CENTRE OF PIT BASE OR AS SHOWN 2. PIPES ARE ALIGNED TO CENTER OF ALL PIT BASES EXCEPT PITS 01,02, 03 & 05
- 3. STEP IRONS REQUIRED FOR ALL PITS GREATER THAN 900mm DEEP. PROVIDE IN
- ACCORDANCE WITH BCC STANDARD DETAIL \$275 4. ALL DRAINAGE WORKS TO BE TO BRIMBANK CITY COUNCIL SPECIFICATIONS
- 5. ALL PIT COVERS IN ROAD RESERVE TO BE HEAVY DUTY GATIC (CLASS 'D')

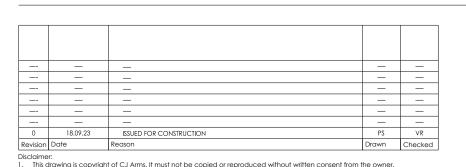DENOTES FULL DEPTH CL.3 F.C.R. BACKFILL



drawing.

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0 0.5 1		3	4	5	7.5	TUM
1:100	20	30	40	50	70	100m
1:1,000 CIVIL S	SITEV	/ORK	(S			

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Project
RIVER VALLEY - STAGE 7D4

Client
YOURLAND

Purpose of Issue

Drawr Drawing Title
PROPOSED STORMWATER LONG SECTIONS (SHEET 3 OF 3) Checked By Drawn Scale Date of First Issue FOR CONSTRUCTION 1:1000H, 1:100V @ A1 18.09.23 File Type

DR


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STOP	This drawing should not be issued in part and must be read in conjunction with all appropriate specifications, notes pages, details and authority drawings as appropriate.

_								
	PIPE BEDDING SPECIFICATION							
	LAYER	MATERIAL SPECIFICATION	COMPACTION SPECIFICATION					
	BACKFILL (TYPE 1)	SITE WON FILL MATERIAL.	COMPACTED TO ACHIEVE A MINIMUM DENSITY OF ADJACENT MATERIAL. TO BE COMPACTED IN MAX 150mm LAYERS.					
	BACKFILL (TYPE 2)	SIZE 20mm CLASS 3 CRUSHED ROCK COMPLYING WITH VICROADS SPECIFICATION SECTION 812.	COMPACTED TO ACHIEVE A MINIMUM 98% (MODIFIED) IN ACCORDANCE WITH AS1289.5.2.1. TO BE COMPACTED IN MAX 150mm LAYERS.					
	BASE LAYER	SIZE 20mm CLASS 2 CRUSHED ROCK COMPLYING WITH VICROADS	COMPACTED TO ACHIEVE A MINIMUM 98% (MODIFIED) IN ACCORDANCE WITH AS 1289.5.2.1. TO BE COMPACTED IN MAX					


150mm LAYERS.

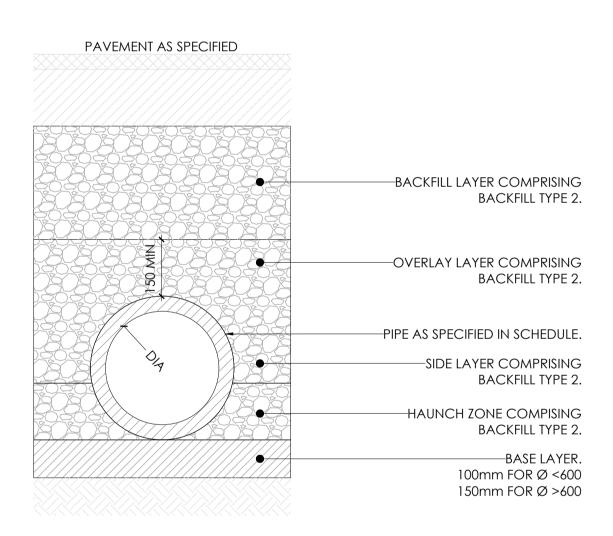SPECIFICATION SECTION 812.






FOR CONSTRUCTION

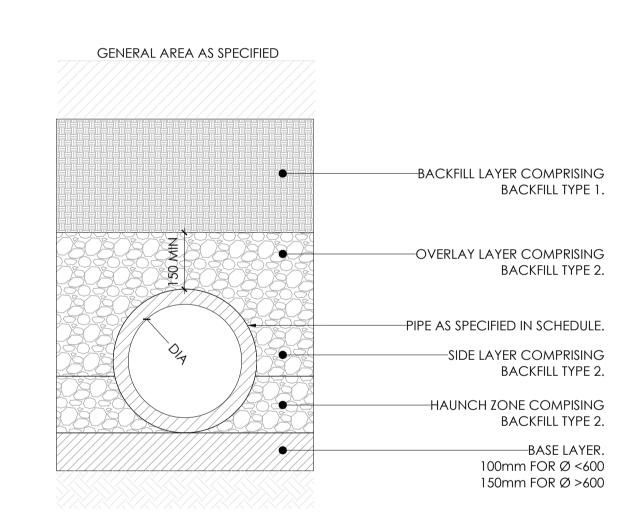

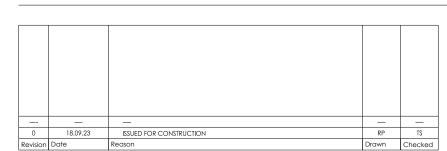PT.02 TYPICAL PIPE TRENCH (GENERAL AREAS) SCALE 1:10



drawing.

Note for Contractors

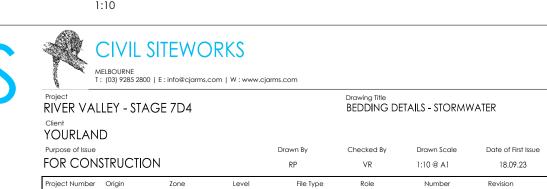
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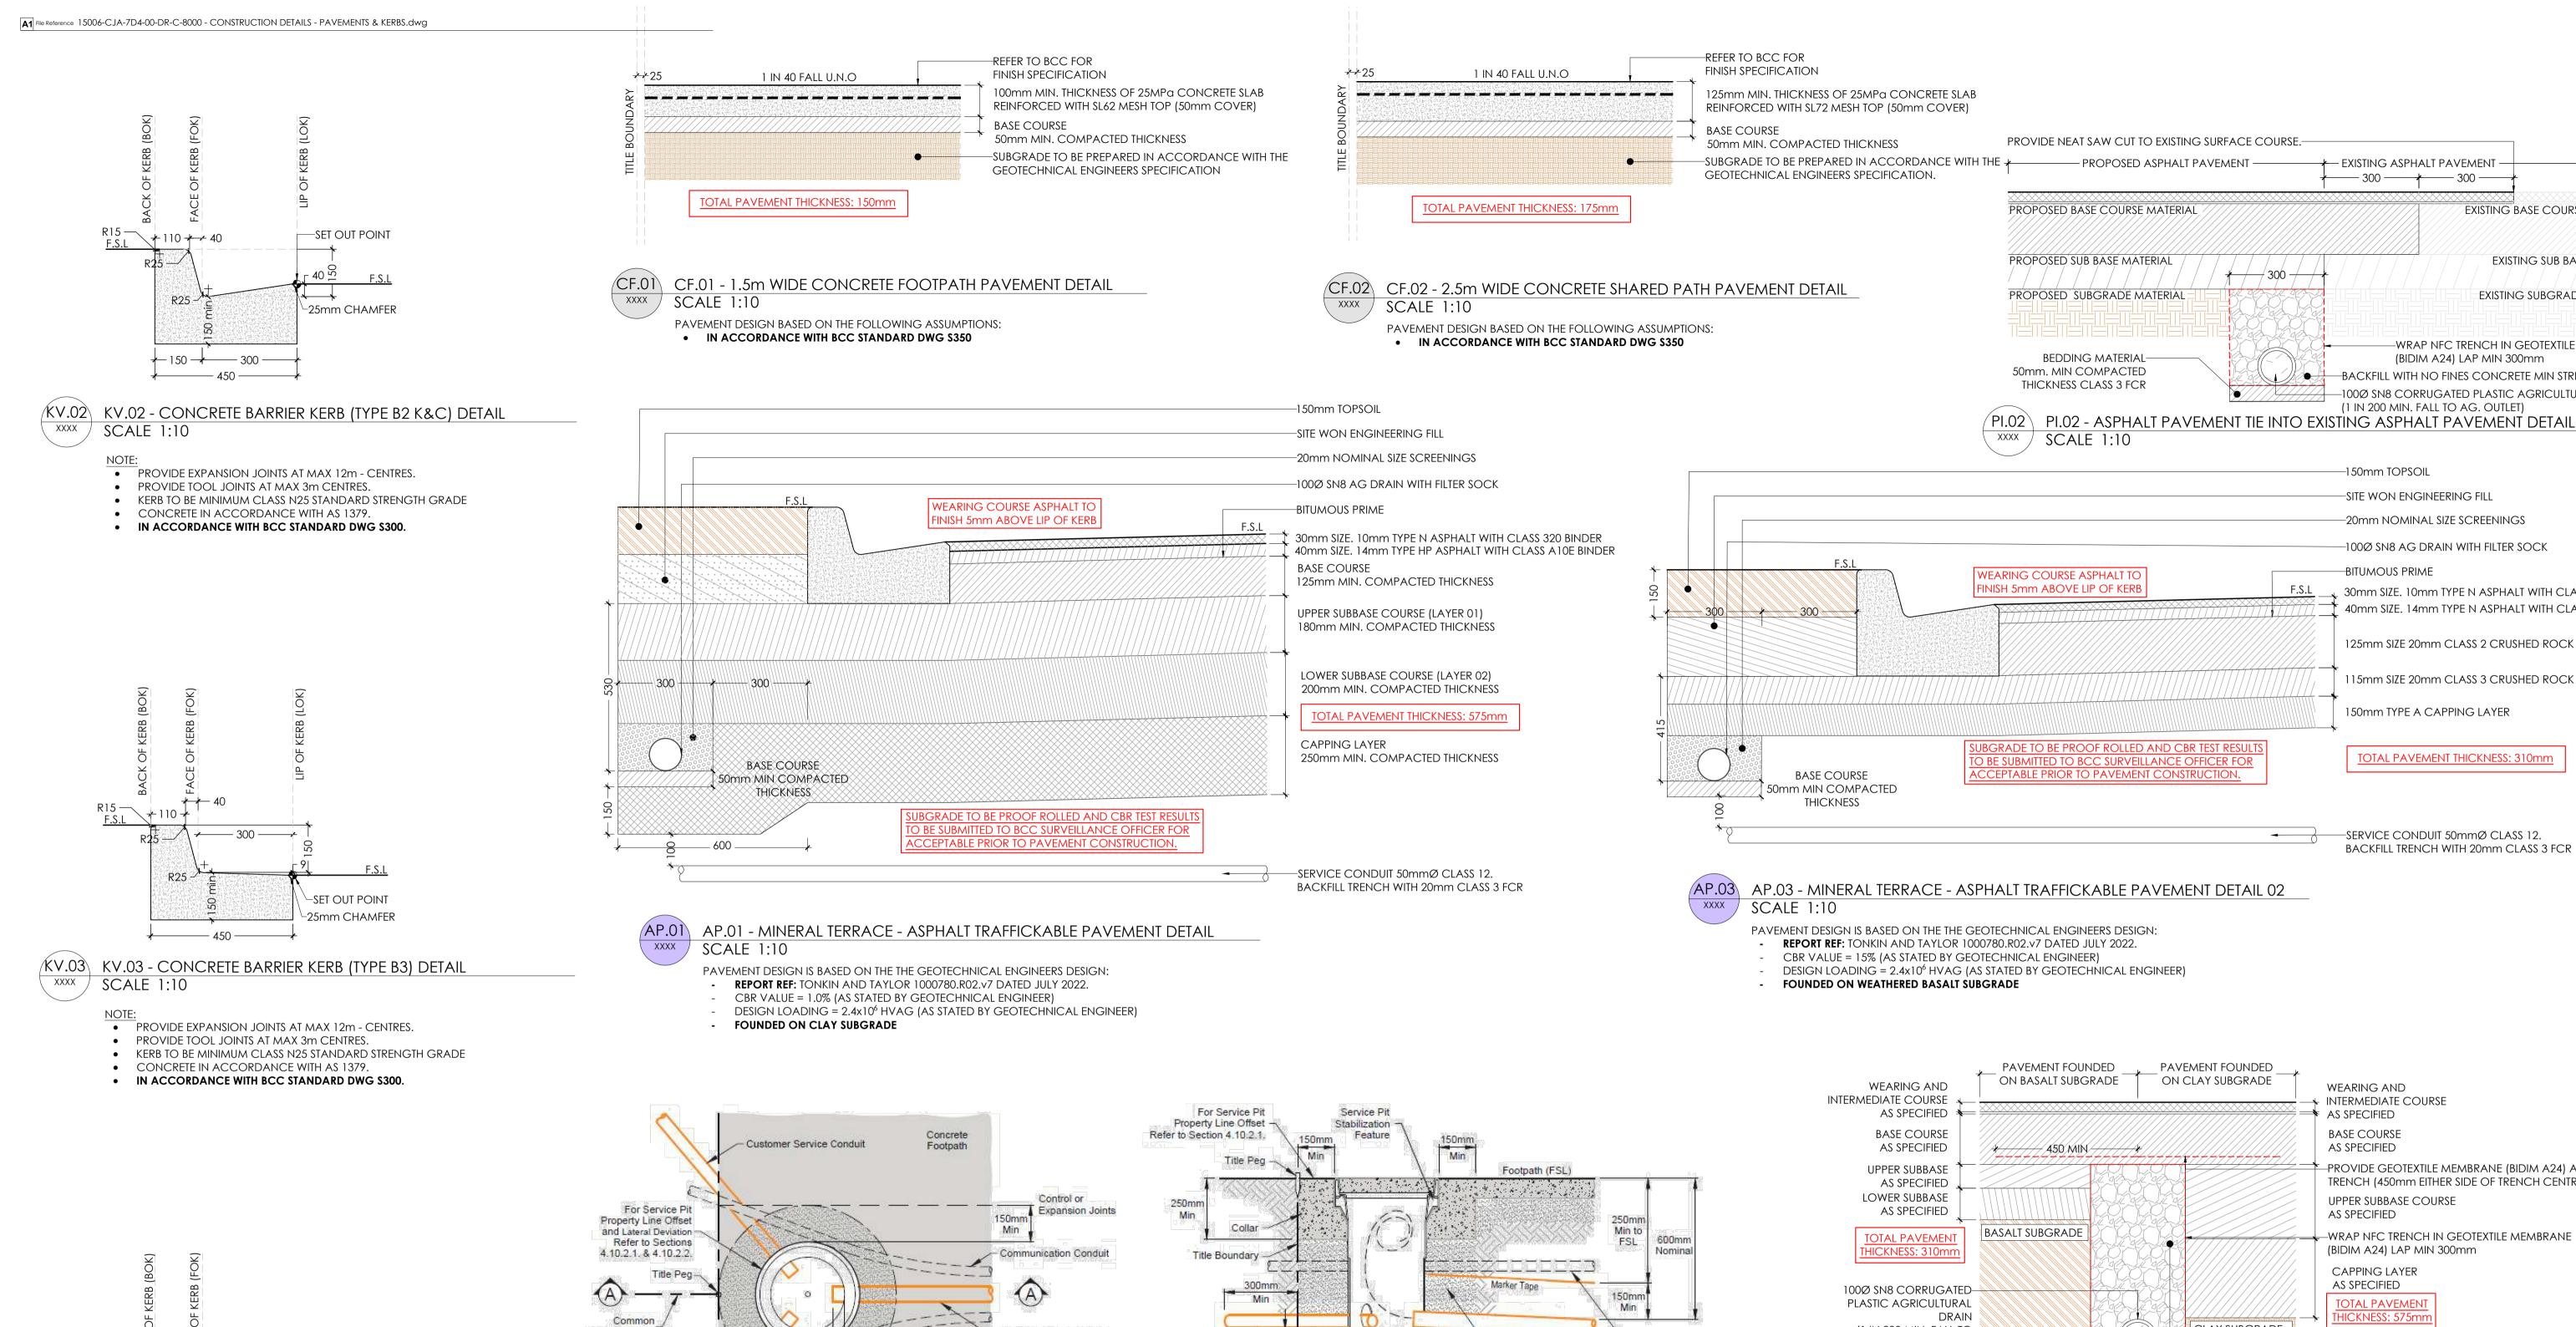
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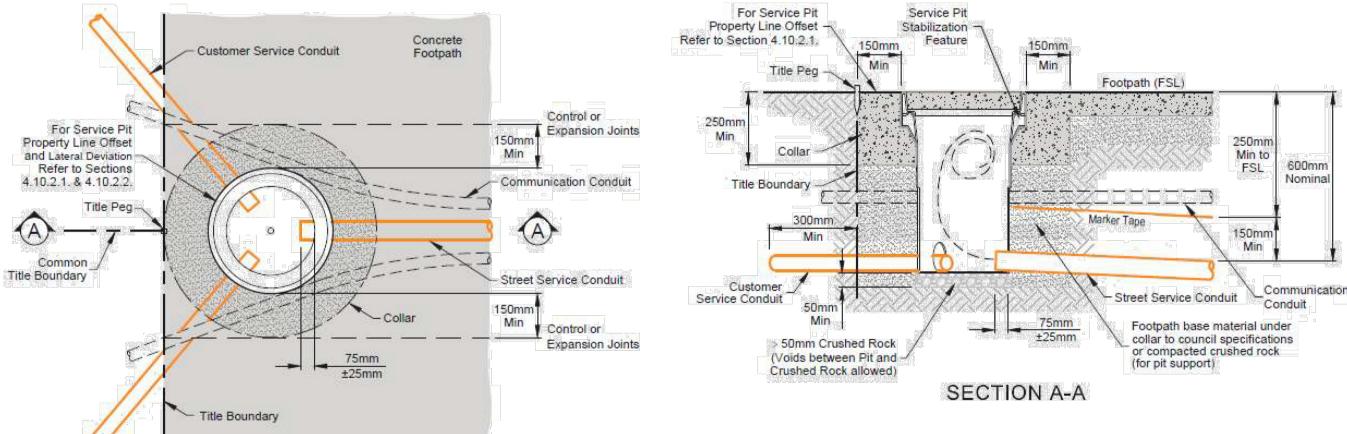
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SCALE N.T.S.

PLAN VIEW (Service Pit Lid and Marker Tape Removed for Clarity) (EP.01) VESI ELECTRICAL PIT ON FOOTPATH DETAIL


Figure 48 - Footpath or Driveway Installation

PAVEMENT FOUNDED ON CLAY SUBGRADE WEARING AND INTERMEDIATE COURSE * AS SPECIFIED **BASE COURSE** AS SPECIFIED -PROVIDE GEOTEXTILE MEMBRANE (BIDIM A24) AT TOP OF TRENCH (450mm EITHER SIDE OF TRENCH CENTRELINE) **UPPER SUBBASE COURSE** AS SPECIFIED -WRAP NFC TRENCH IN GEOTEXTILE MEMBRANE (BIDIM A24) LAP MIN 300mm CAPPING LAYER AS SPECIFIED **TOTAL PAVEMENT** THICKNESS: 575mr CLAY SUBGRADE (1 IN 200 MIN. FALL TO AG. OUTLET) -SUBGRADE TO BE PREPARED IN ACCORDANCE WITH THE GEOTECHNICAL BEDDING MATERIAL **ENGINEERS SPECIFICATION** 50mm. MIN COMPACTED

TABLE.01 - VICTORIA ASPHALT PAVEMENT SPECIFICATION LAYER MATERIAL SPECIFICATION COMPACTION SPECIFICATION SIZE 20mm CLASS 2 CRUSHED ROCK COMPLYING WITH VICROADS COMPACTED TO ACHIEVE A MINIMUM 98% (MODIFIED) IN **BASE COURSE** SPECIFICATION SECTION 812. ACCORDANCE WITH AS1289.5.2.1. SIZE 20mm CLASS 3 CRUSHED ROCK COMPLYING WITH VICROADS COMPACTED TO ACHIEVE A MINIMUM 98% (MODIFIED) IN UPPER & LOWER SUBBASE COURSE SPECIFICATION SECTION 812. ACCORDANCE WITH AS1289.5.2.1. SIZE 40mm CLASS 4 CRUSHED ROCK COMPLYING WITH VICROADS COMPACTED TO ACHIEVE A MINIMUM 98% (STANDARD) IN SELECT FILL SPECIFICATION SECTION 812. ACCORDANCE WITH AS1289.5.1.1. 250mm IMPORTED CAPPING LAYER MATERIAL MEETING THE FOLLOWING COMPACTED TO ACHIEVE A MINIMUM 98% (STANDARD) IN PROPERTIES: CBR >7%, SWELL <1.5%, PERMEABILITY K < $5x10^{-9}$ m/s ($5x10^{-7}$ CAPPING LAYER ACCORDANCE WITH AS1289.5.1.1.

*--- 300 MIN

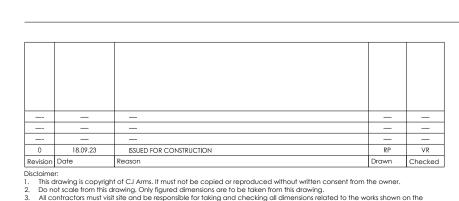PI.01 - BASALT TO CLAY SUBGRADE TRANSITION DETAIL



SCALE 1:10

SET OUT POINT

PROVIDE EXPANSION JOINTS AT MAX 12m - CENTRES.

IN ACCORDANCE WITH BCC STANDARD DWG \$300.

PROVIDE TOOL JOINTS AT MAX 3m CENTRES.

CONCRETE IN ACCORDANCE WITH AS 1379.

KV.04 - CONCRETE EDGING KERB (TYPE ES) DETAIL

KERB TO BE MINIMUM CLASS N25 STANDARD STRENGTH GRADE

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T&T GEOTECHNICAL ENGINEER TO BE NOTIFIED FOR INSPECTION AND ADVICE ON PAVEMENT WHEN BASALT ROCK LAYER OR BOULDER IS ENCOUNTERED AT THE SUBGRADE

NOTE: PAVEMENT DESIGN IN ACCORDANCE WITH TONKIN & TAYLOR GEOTECHNICAL REPORT #1000780.R02.v7 (JULY 2022)







T : (03) 9285 2800 | F : info@ciarms.com | W : www.ciarms.com CONSTRUCTION DETAILS - PAVEMENTS & KERBS FOR CONSTRUCTION AS SHOWN @ A1 DR 8000 15006 CJA 7D4 XX

BACKFILL WITH NO FINES CONCRETE

MIN STRENGTH 15MPa

★ EXISTING ASPHALT PAVEMENT

* / / 300 / /

—— 300 ——*—— 300 —

EXISTING BASE COURSE MATERIAL

EXISTING SUB BASE MATERIAL

EXISTING SUBGRADE MATERIAL

-WRAP NFC TRENCH IN GEOTEXTILE MEMBRANE

(BIDIM A24) LAP MIN 300mm

BACKFILL WITH NO FINES CONCRETE MIN STRENGTH 15MPa

(1 IN 200 MIN. FALL TO AG. OUTLET)

-SITE WON ENGINEERING FILL

-20mm NOMINAL SIZE SCREENINGS

-100Ø SN8 AG DRAIN WITH FILTER SOCK

125mm SIZE 20mm CLASS 2 CRUSHED ROCK

115mm SIZE 20mm CLASS 3 CRUSHED ROCK

TOTAL PAVEMENT THICKNESS: 310mm

BACKFILL TRENCH WITH 20mm CLASS 3 FCR

150mm TYPE A CAPPING LAYER

SERVICE CONDUIT 50mm@ CLASS 12.

–1*5*0mm TOPSOIL

-BITUMOUS PRIME

-100Ø SN8 CORRUGATED PLASTIC AGRICULTURAL DRAIN


30mm SIZE. 10mm TYPE N ASPHALT WITH CLASS 320 BINDER 40mm SIZE. 14mm TYPE N ASPHALT WITH CLASS 320 BINDER

FOR CONSTRUCTION

www.cjarms.com

THICKNESS CLASS 3 FCR

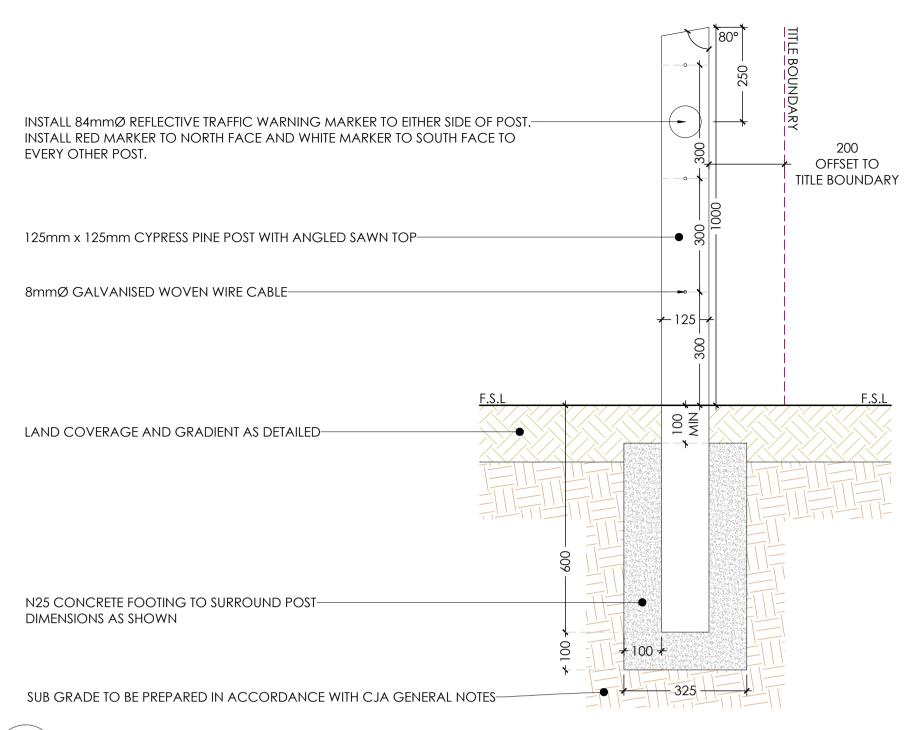SCALE 1:10




FE.01a FE.01a - VEHICLE EXCLUSION (POST & WIRE) FENCE POST DETAIL SCALE 1:10

FINISHED SPECIFICATION:

TIBER STAIN FINISH TO BE CABOT'S 'TIMBER SHADES' EBONY N.

CONTRACTOR NOTES:

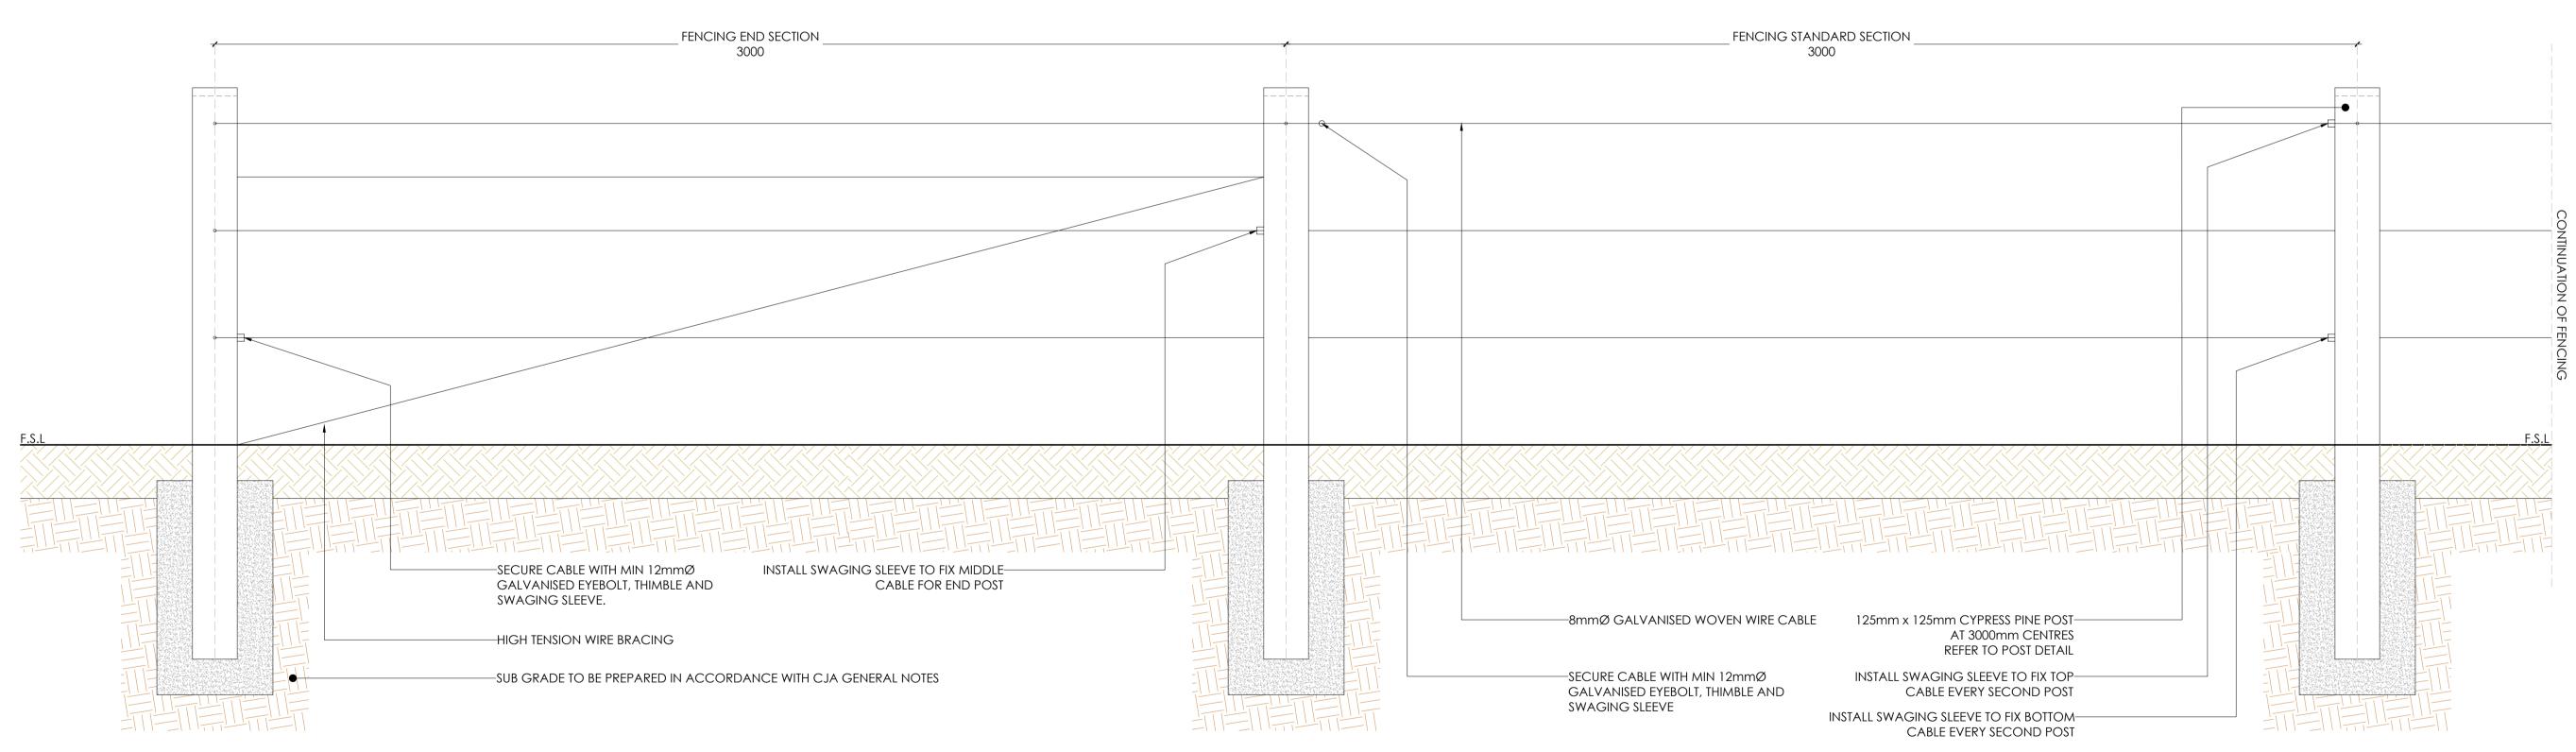PRIOR TO STAINING, CONTRACTOR TO PROVIDE 3mm CHAMFER TO ALL POSTS.




FOR CONSTRUCTION

FE.01b - VEHICLE EXCLUSION (POST & WIRE) FENCE POST DETAIL SCALE 1:10

FINISHED SPECIFICATION:

TIBER STAIN FINISH TO BE CABOT'S 'TIMBER SHADES' EBONY N.

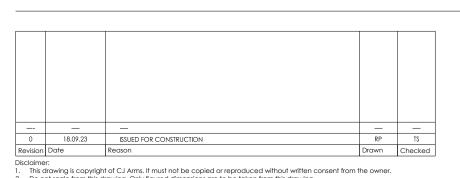CONTRACTOR NOTES: PRIOR TO STAINING, CONTRACTOR TO PROVIDE 3mm CHAMFER TO ALL POSTS.



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DR

AS SHOWN @ A1 18.09.23

8005

FOR CONSTRUCTION

15006 CJA 7D4 XX

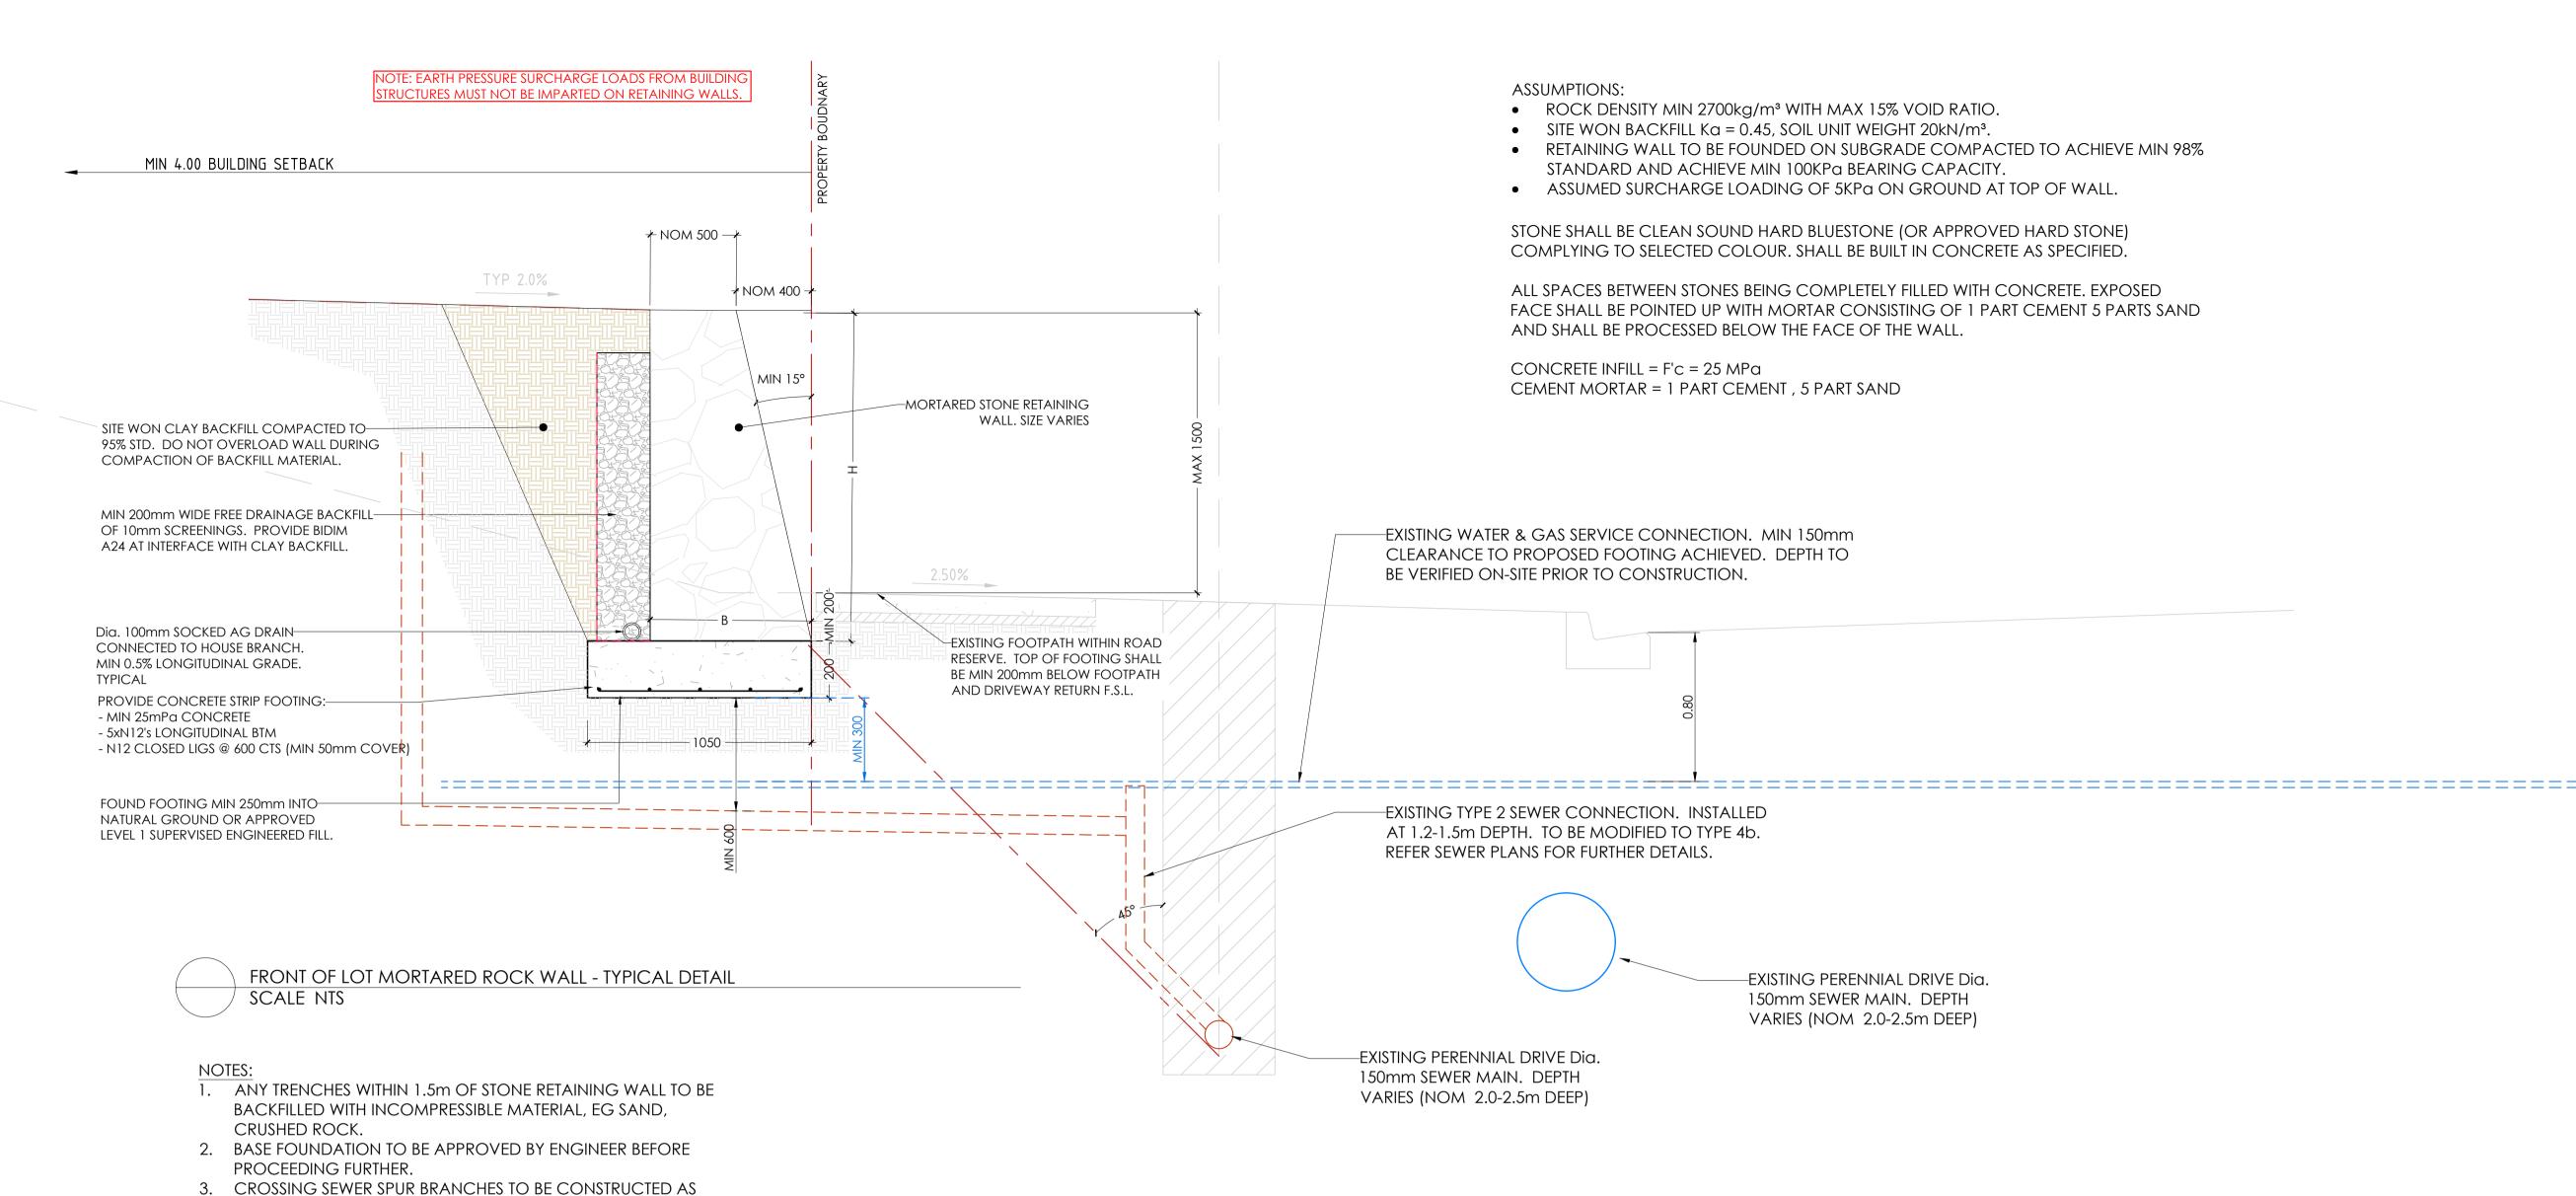


TABLE.01 - ROCKWORK - RETAINING WALL SCHEDULE - 5kPa SURCHARGE							
RETAINED HEIGHT (H)	SLANT OF FACE	TOP ROCK WIDTH	BASE ROCK WIDTH (B)				
0mm - 1700mm	15 DEGREES	500mm (MIN)	0.6 x WALL HEIGHT (H)				

ASSUMPTIONS:

ROCK DENSITY MIN 2700kg/m³ WITH MAX 15% VOID RATIO.

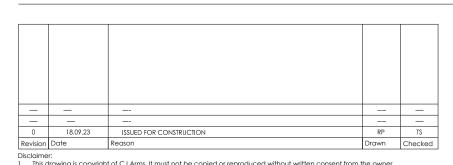
PER MRWA-S-209. 0.6m MINIMUM VERTICAL AND HORIZONTAL

CLEARANCE REQUIRED TO RETAINING WALL FOOTINGS,

- SITE WON BACKFILL Ka = 0.45, SOIL UNIT WEIGHT 20kN/m³.
- RETAINING WALL TO BE FOUNDED ON SUBGRADE COMPACTED TO ACHIEVE MIN 98%

 STANDARD AND ACHIEVE MIN 100KPg BEARING CAPACITY

STANDARD AND ACHIEVE MIN 100KPa BEARING CAPACITY. ASSUMED SURCHARGE LOADING OF 5KPa ON WALL.



Note for Contractors

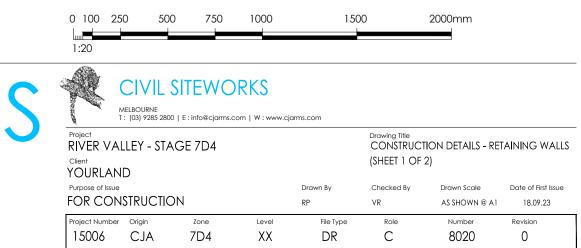
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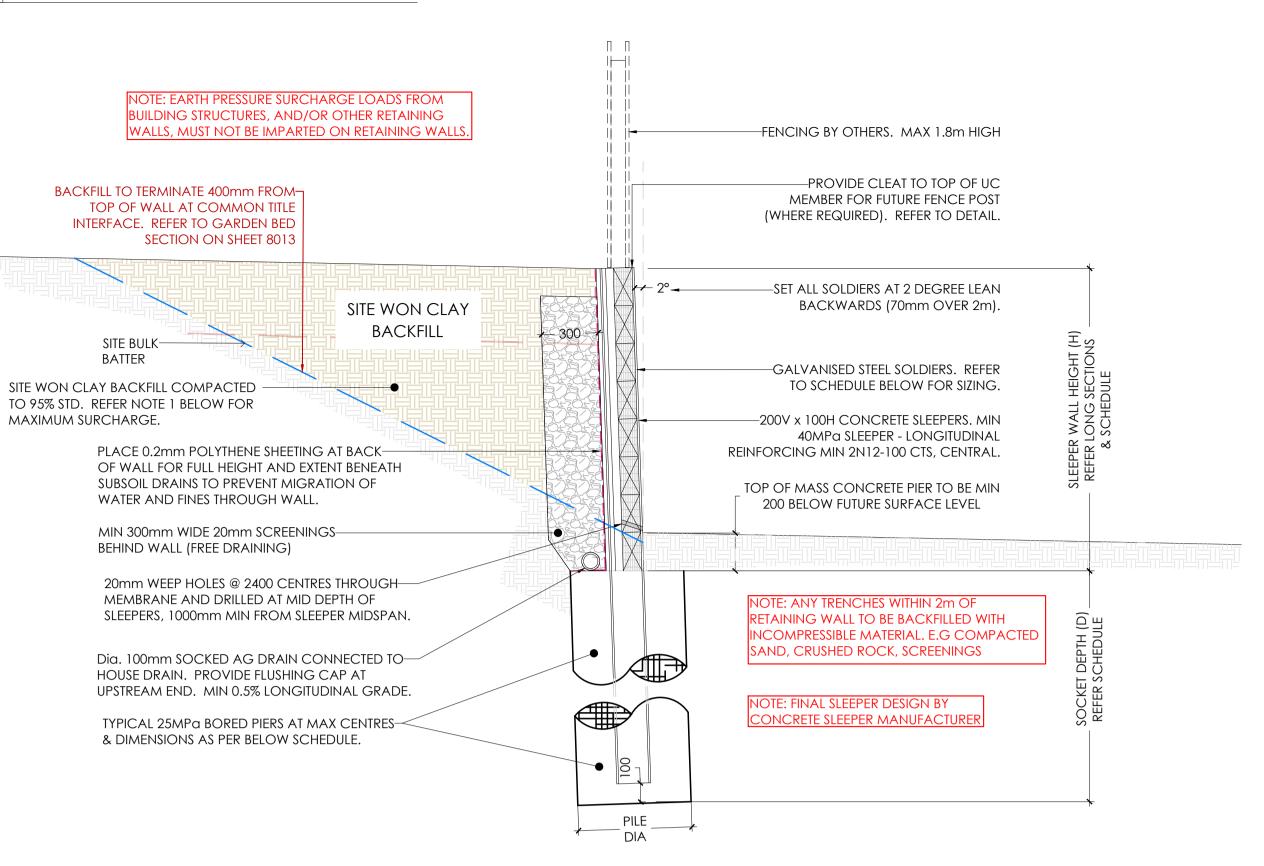
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FOR CONSTRUCTION








RW.03 RW.03a - PRE-CAST SLEEPER RETAINING WALL - FOOTING TYPE 1 SCALE NTS


- DESIGN LOADS ARE:
- 5KPa WHERE RETAINING LOTS/LANDSCAPING RESERVES
- WHERE COMPACTION EQUIPMENT LOADS EXCEEDS THE ABOVE DESIGN LOAD, ALLOW TO TEMPORARILY PROP THE FACE OF THE WALL.
- 2. SOCKET DEPTH IS DEPTH INTO APPROVED NATURAL GROUND OR APPROVED SUPERVISED ENGINEERED FILL. TABULATED SOCKET DEPTHS ARE BASED ON THE GROUND ON THE HIGH SIDE OF THE WALL BEING HORIZONTAL. SHOULD THERE BE AN INCLINE BEHIND THE TOP OF WALL OF UP TO 1V:4H MAX: ADOPT THE DESIGN FOR HEIGHT (H) = $1.2 \times ACTUAL WALL HEIGHT$.
- 3. WHERE THE LONGITUDINAL SLOPE ALONG AND PARALLEL TO THE BASE OF THE WALL IS STEEPER THAN 1V:3H, ADOPT THE DESIGN FOR HEIGHT (H) = $1.2 \times ACTUAL WALL HEIGHT$.
- 4. WHERE THE SOCKET DEPTH EXTENDS INTO APPROVED BASALT ROCK, SOCKET DEPTH SHALL BE THE LESSER OF THE DEPTH NOTED IN THE BELOW SCHEDULE AND MIN 1.2m INTO THE APPROVED HIGH STRENGTH BASALT PROFILE.
- 5. BORE HOLES FOR PIERS SHALL BE CLEAN OF LOOSE SOIL AND DEBRIS. DO NOT BORE HOLES WHEN RAIN IS EXPECTED.
- 6. ALL SLEEPERS ARE TO BE SLEEPER DIRECT RUSTIC WOODGRAIN SLEEPER CHARCOAL.

TABLE.01 - PRE CAST SLEEPER WALL SCHEDULE - 5kPa SURCHARGE									
RETAINED HEIGHT	H.D GALV. SOLDERS	max. solder spacing	PIER DIAMETER (PØ)	SOCKET DEPTH (D)					
0mm - 600mm	150 UC 23	2400mm	600mm	1500mm					
601mm - 900mm	150 UC 23	2400mm	600mm	1800mm					
901mm - 1200mm	150 UC 23	2400mm	600mm	2100mm					
1201mm - 1500mm	150 UC 23	2400mm	600mm	2400mm					
1501mm - 1800mm	150 UC 23	2400mm	600mm	2800mm					
1801mm - 2100mm	150 UC 23	1800mm	600mm	2800mm					
2101mm - 2400mm	150 UC 30	1800mm	600mm	3100mm					
2401mm - 2700mm	150 UC 37	1800mm	600mm	3500mm					
2701mm - 3000mm	200 UC 46	1800mm	600mm	3800mm					
3001mm - 3300mm	200 UC 52	1800mm	600mm	4100mm					

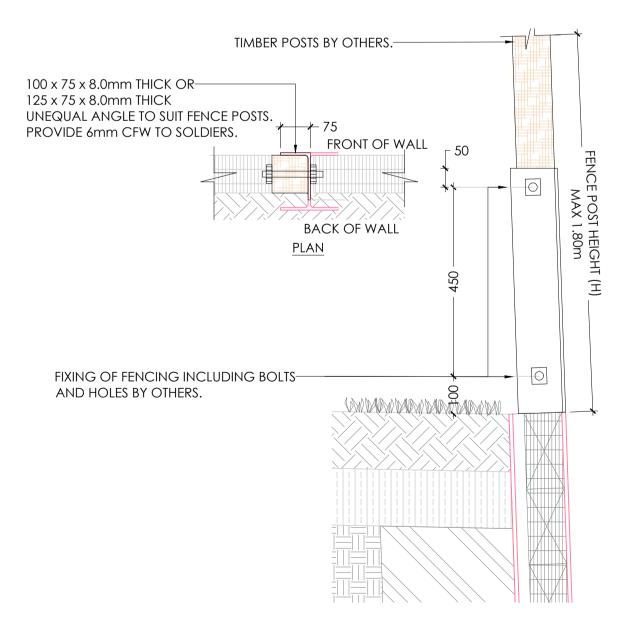* SOCKET DEPTH (D) DENOTES DEPTH INTO NATURAL GROUND (U.N.O)



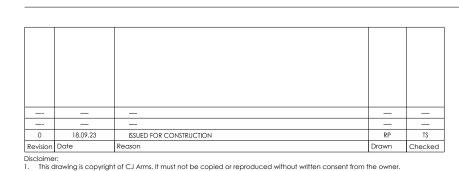RW.04 RW.04 - PRE-CAST SLEEPER - FENCE CONNECTION DETAIL SCALE 1:10



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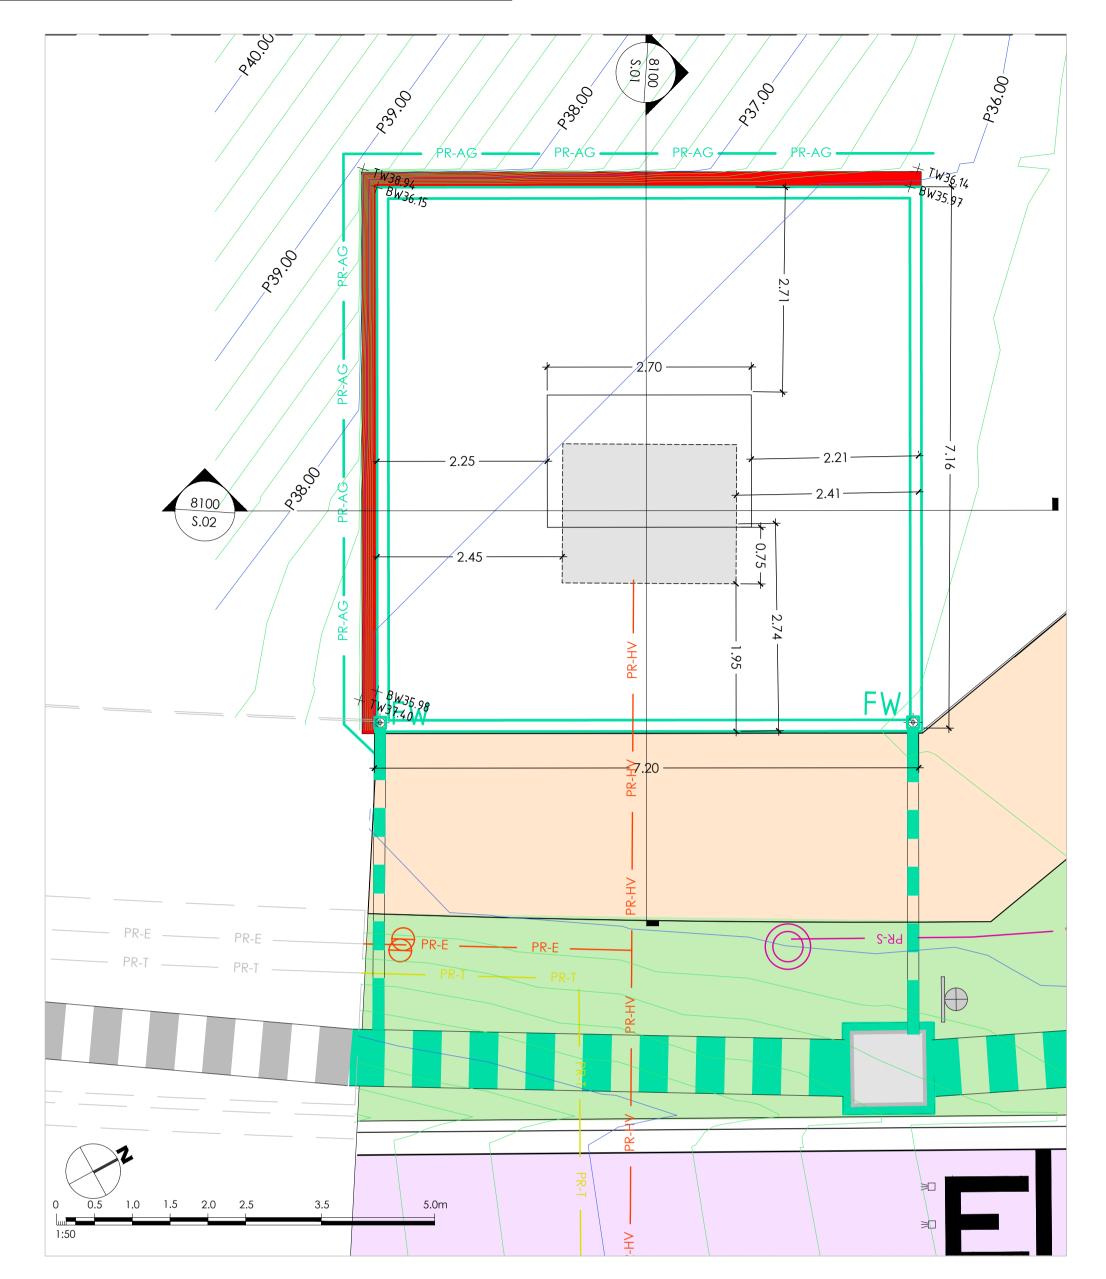
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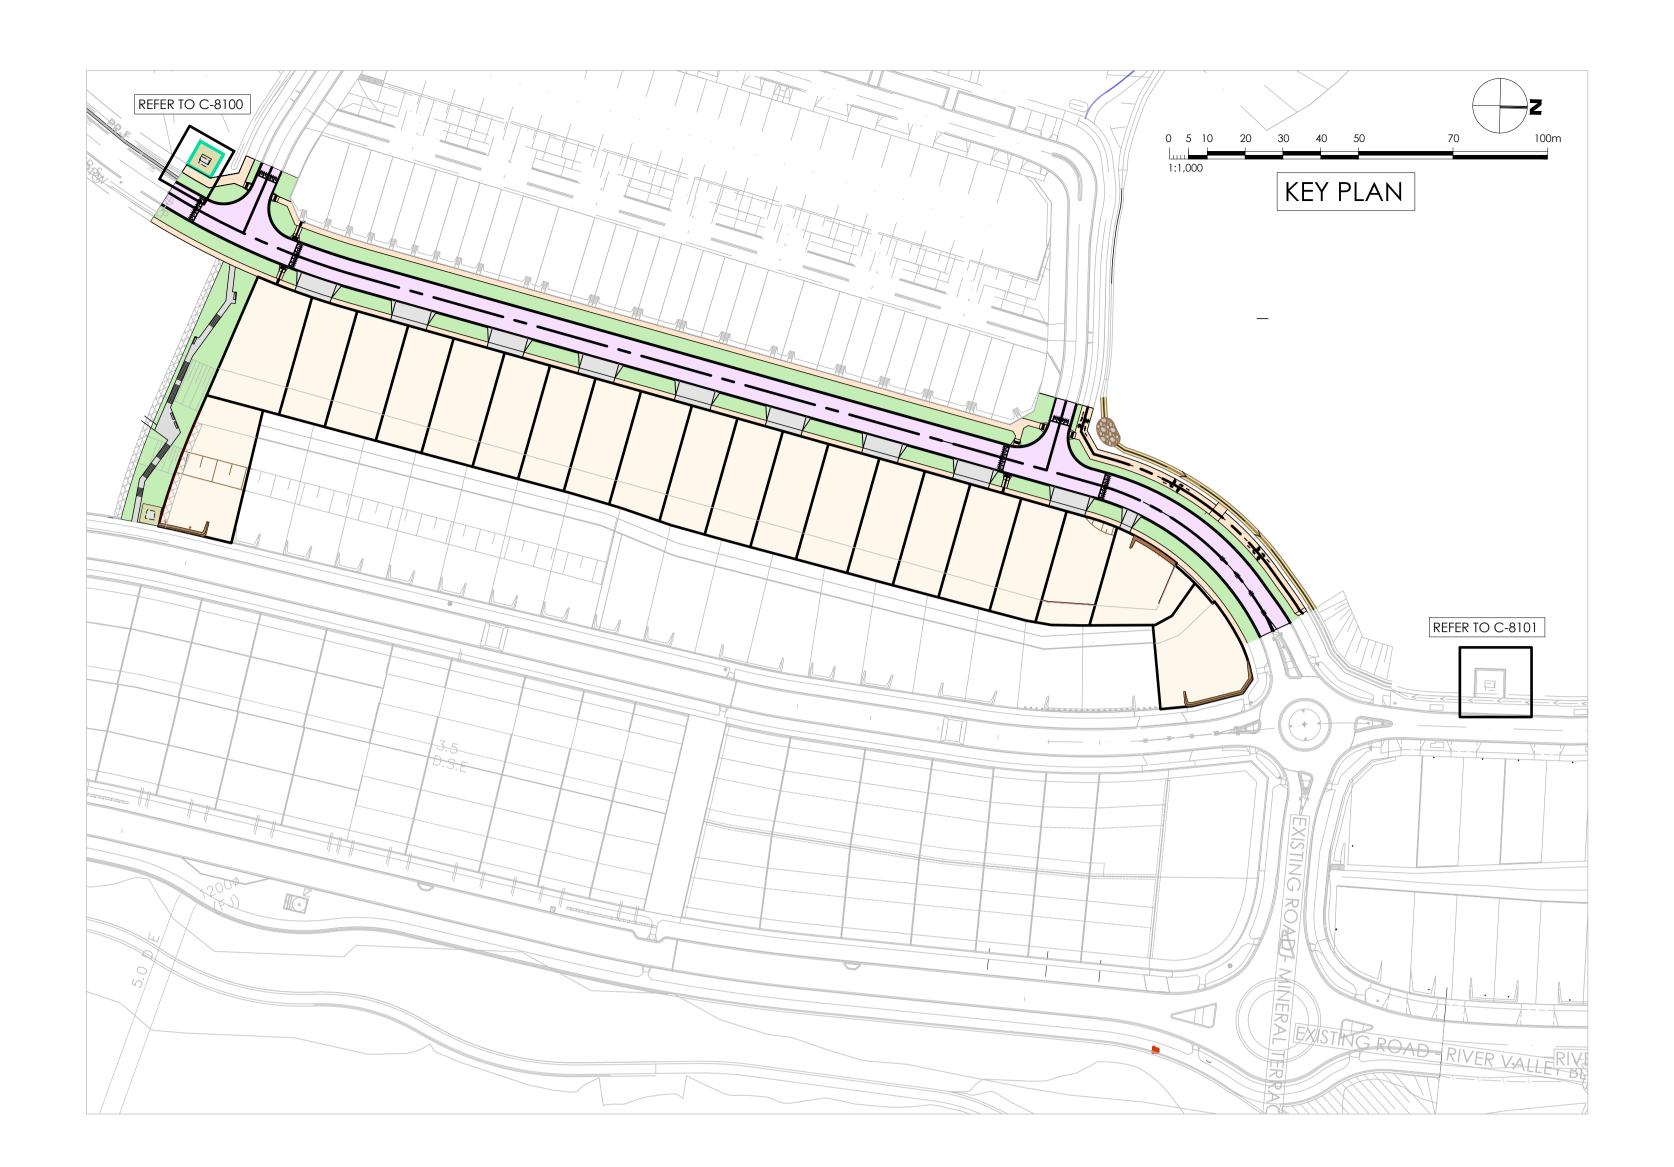
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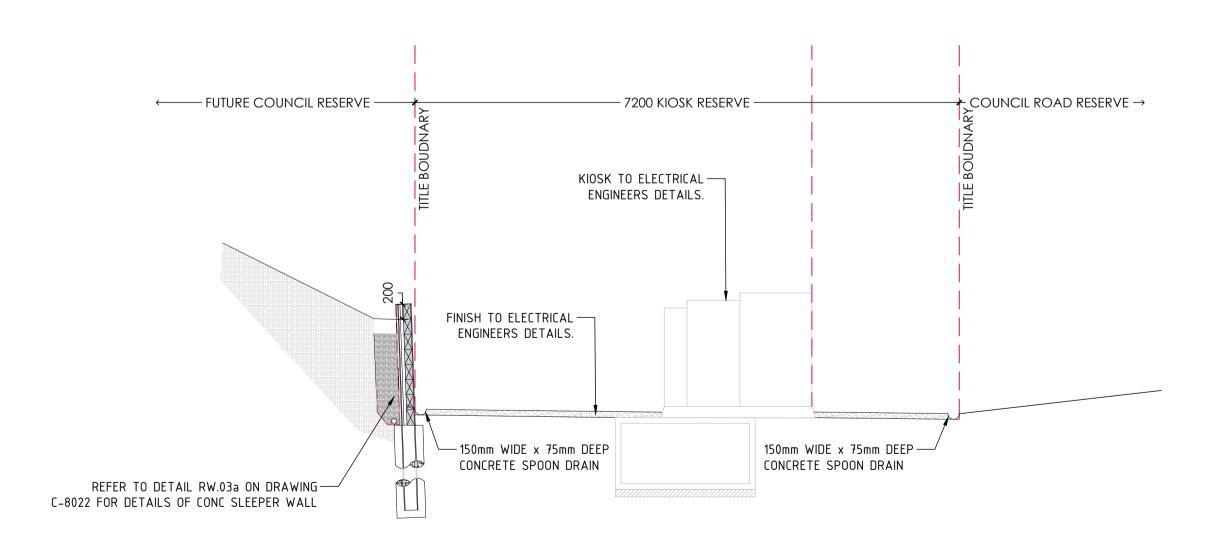





8021








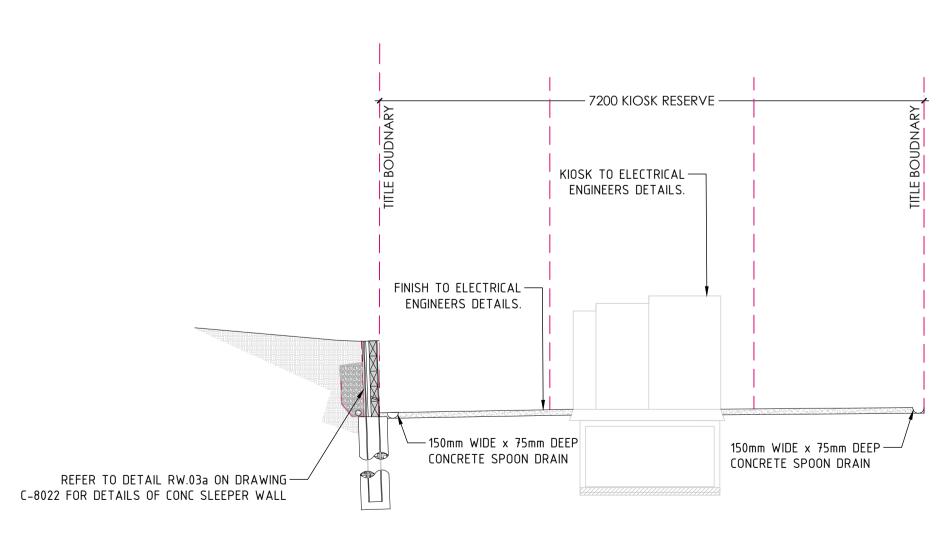FOR CONSTRUCTION



S.02 HV KIOSK - SECTION VIEW
SCALE 1:50

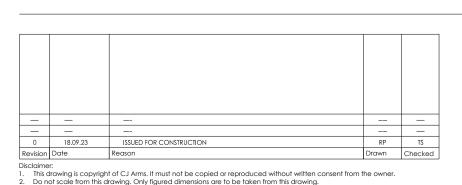

Note for Contractors

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S.01 HV KIOSK - SECTION VIEW
SCALE 1:50

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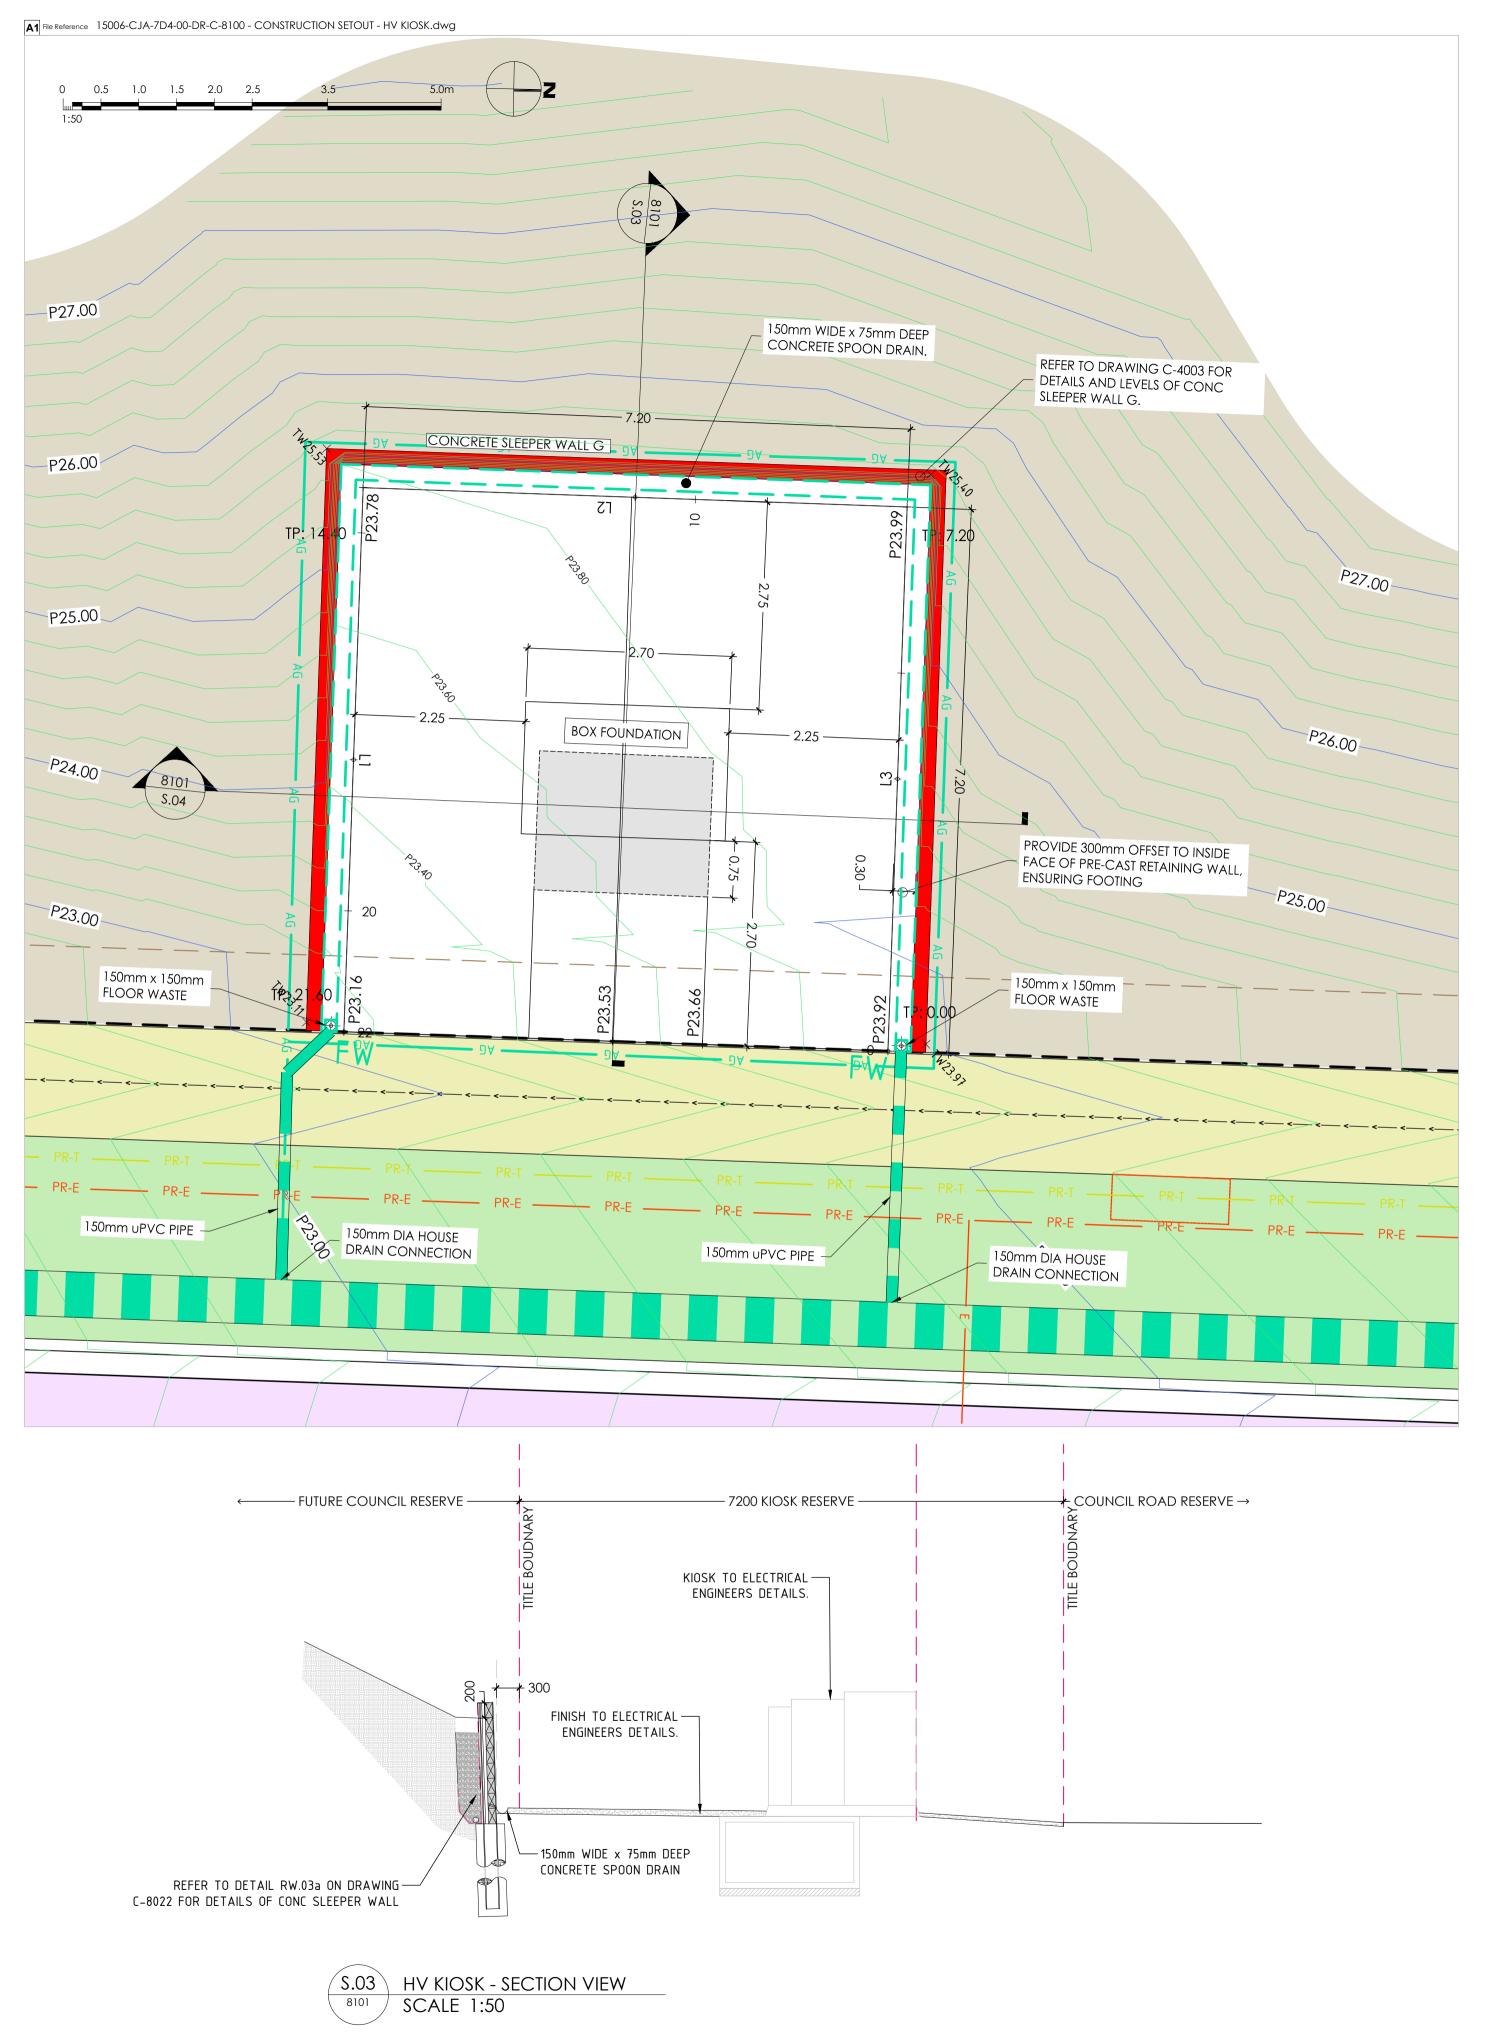
S	CIVIL SITEWORK MELBOURNE 1: (03) 9285 2800 E: info@cjarms.com W				
	Project RIVER VALLEY - STAGE 7D4 Client YOURLAND		Drawing Title CONSTRUC	fion setout - hv	KIOSK
	Purpose of Issue FOR CONSTRUCTION	Drawn By RP	Checked By VR	Drawn Scale AS NOTED @ A1	Date of F

File Type Role

DR C


Number 8100

Project Number Origin Zone Level 15006 CJA 7D4 XX



REFER TO C-8100 REFER TO C-8101

Set Out Table for E					
TAG		CHAINAGE	EASTING	NC	
L3	START END	0.00 7.20	310341.089 310333.889	581 581	

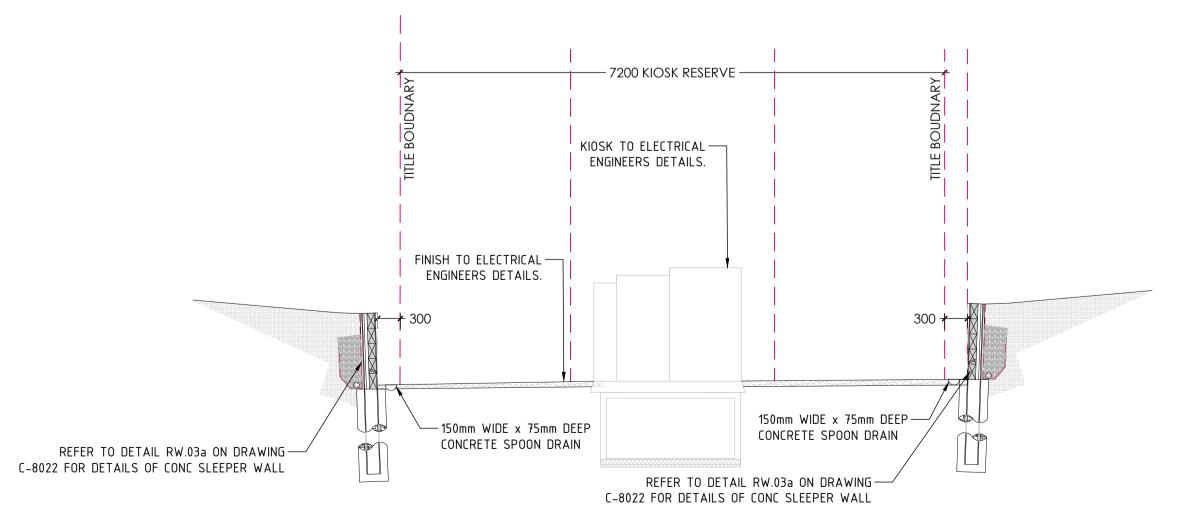

(\$.04) HV KIOSK - SECTION VIEW SCALE 1:50

	_			
0	18.09.23	ISSUED FOR CONSTRUCTION	RP	TS
	Date	Reason	Drawn	Checked

drawing.

Note for Contractors

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15		CIVIL SITEWO MELBOURNE T: (03) 9285 2800 E: info@cjarms.cr				
	Project RIVER VALLEY - STAGE 7D4 Client YOURLAND			Drawing Title CONSTRUCTION SETOUT - HV KIOSK		
	Purpose of Is	sue	Drawn By	Checked By	Drawn Scale	Date of First Issue
	FOR CO	ONSTRUCTION	RP	VR	AS NOTED @ A1	18.09.23

15006 CJA 7D4 XX

Number

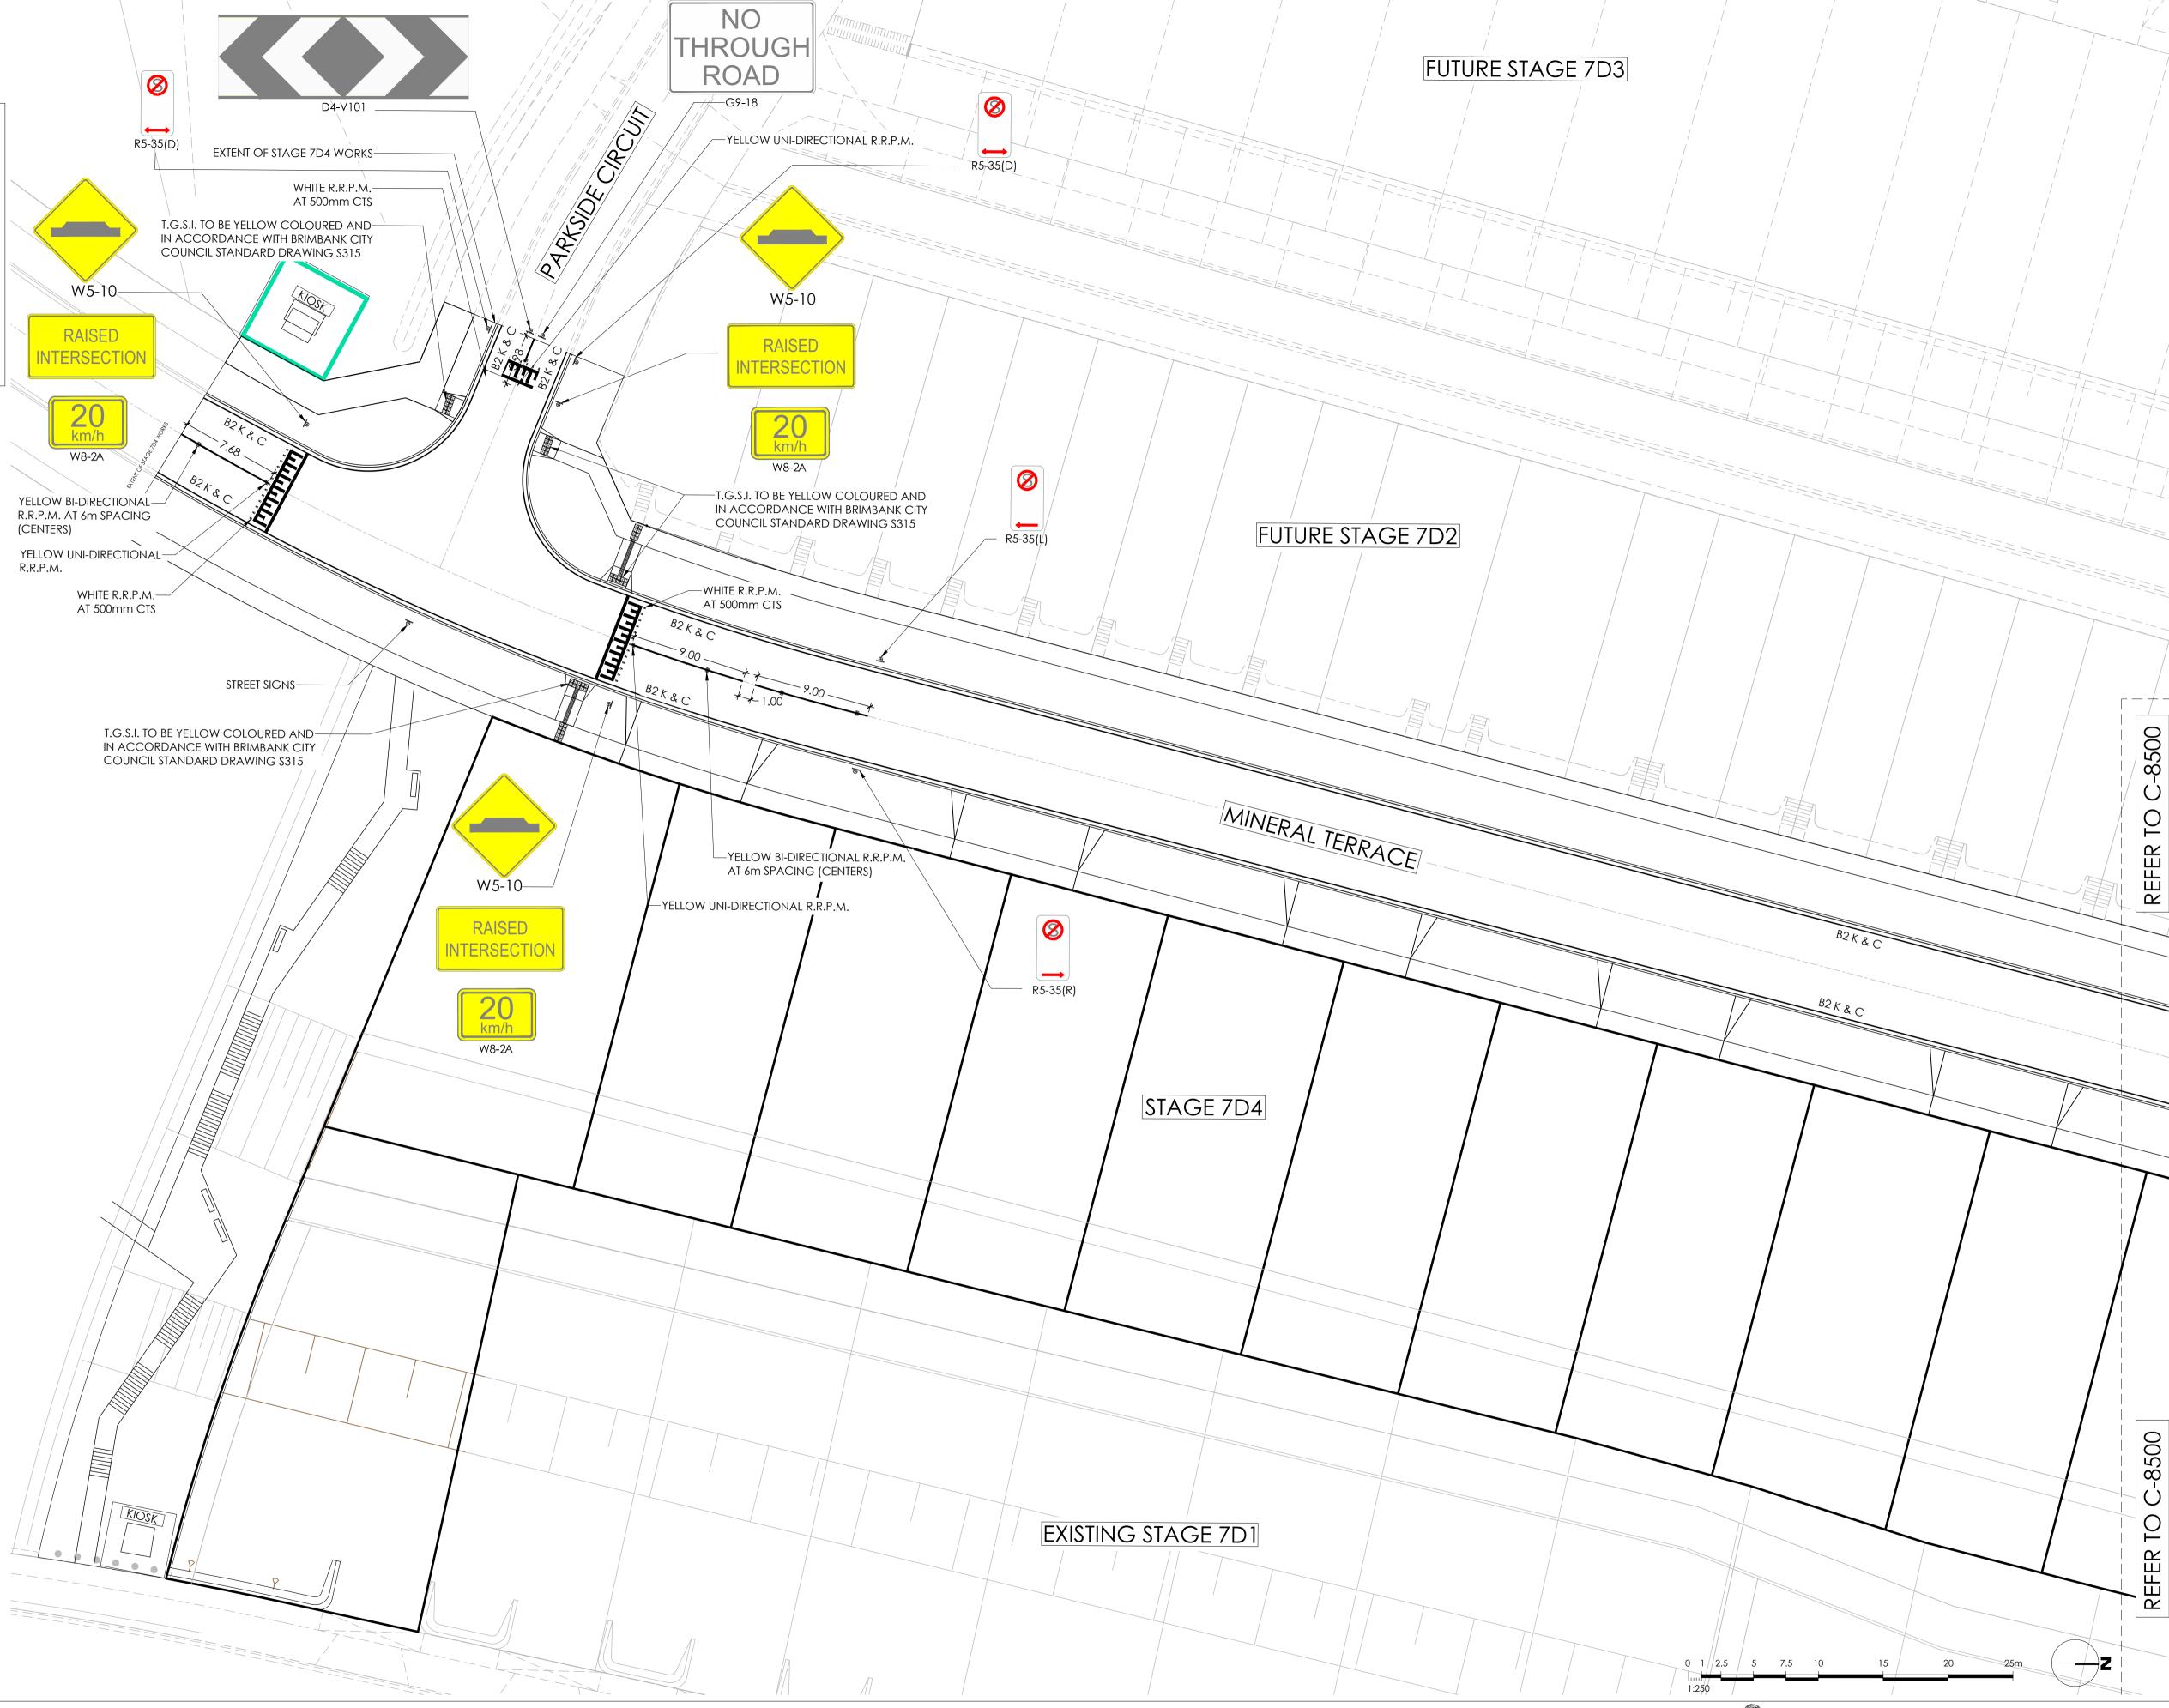
8101

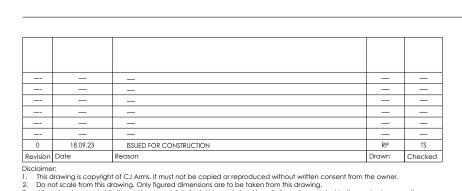
DR

С

guarantee is given that existing services are shown.

A1 File Reference 15006-CJA-7D4-00-DR-C-8500 - SIGNAGE AND LINEMARKING PLAN.dwg DRAWING NOTES: ALL WORKS TO BE IN ACCORDANCE WITH AS 1742. ALL LINEMARKING AND SIGNAGE TO BE IN ACCORDANCE WITH VICROADS AND TRAFFIC MANUALS. LINEMARKING SET-OUT SHALL BE INSPECTED AND APPROVED PRIOR TO FINAL LINEMARKING IS UNDERTAKEN. . ALL LINEMARKING TO LONG LIFE MATERIAL (DEGADUE). ANY OBSOLETE LINEMARKING IS TO BE REMOVED BY GRINDING STRIPPING OR THE APPLICATION OF BITUMEN BINDER AND GRIT PRIOR TO 'NEW' LINEMARKING BEING RAISED PAVEMENT MARKERS ARE TO BE PROVIDED IN ACCORDANCE WITH AS 1742. ALL SIGNAGE TO BE INSTALLED AS PER BRIMBANK CITY COUNCIL DETAIL \$520. ALL T.G.S.I. TO BE YELLOW COLOURED AND IN ACCORDANCE WITH BRIMBANK CITY COUNCIL STANDARD DRAWING \$315.





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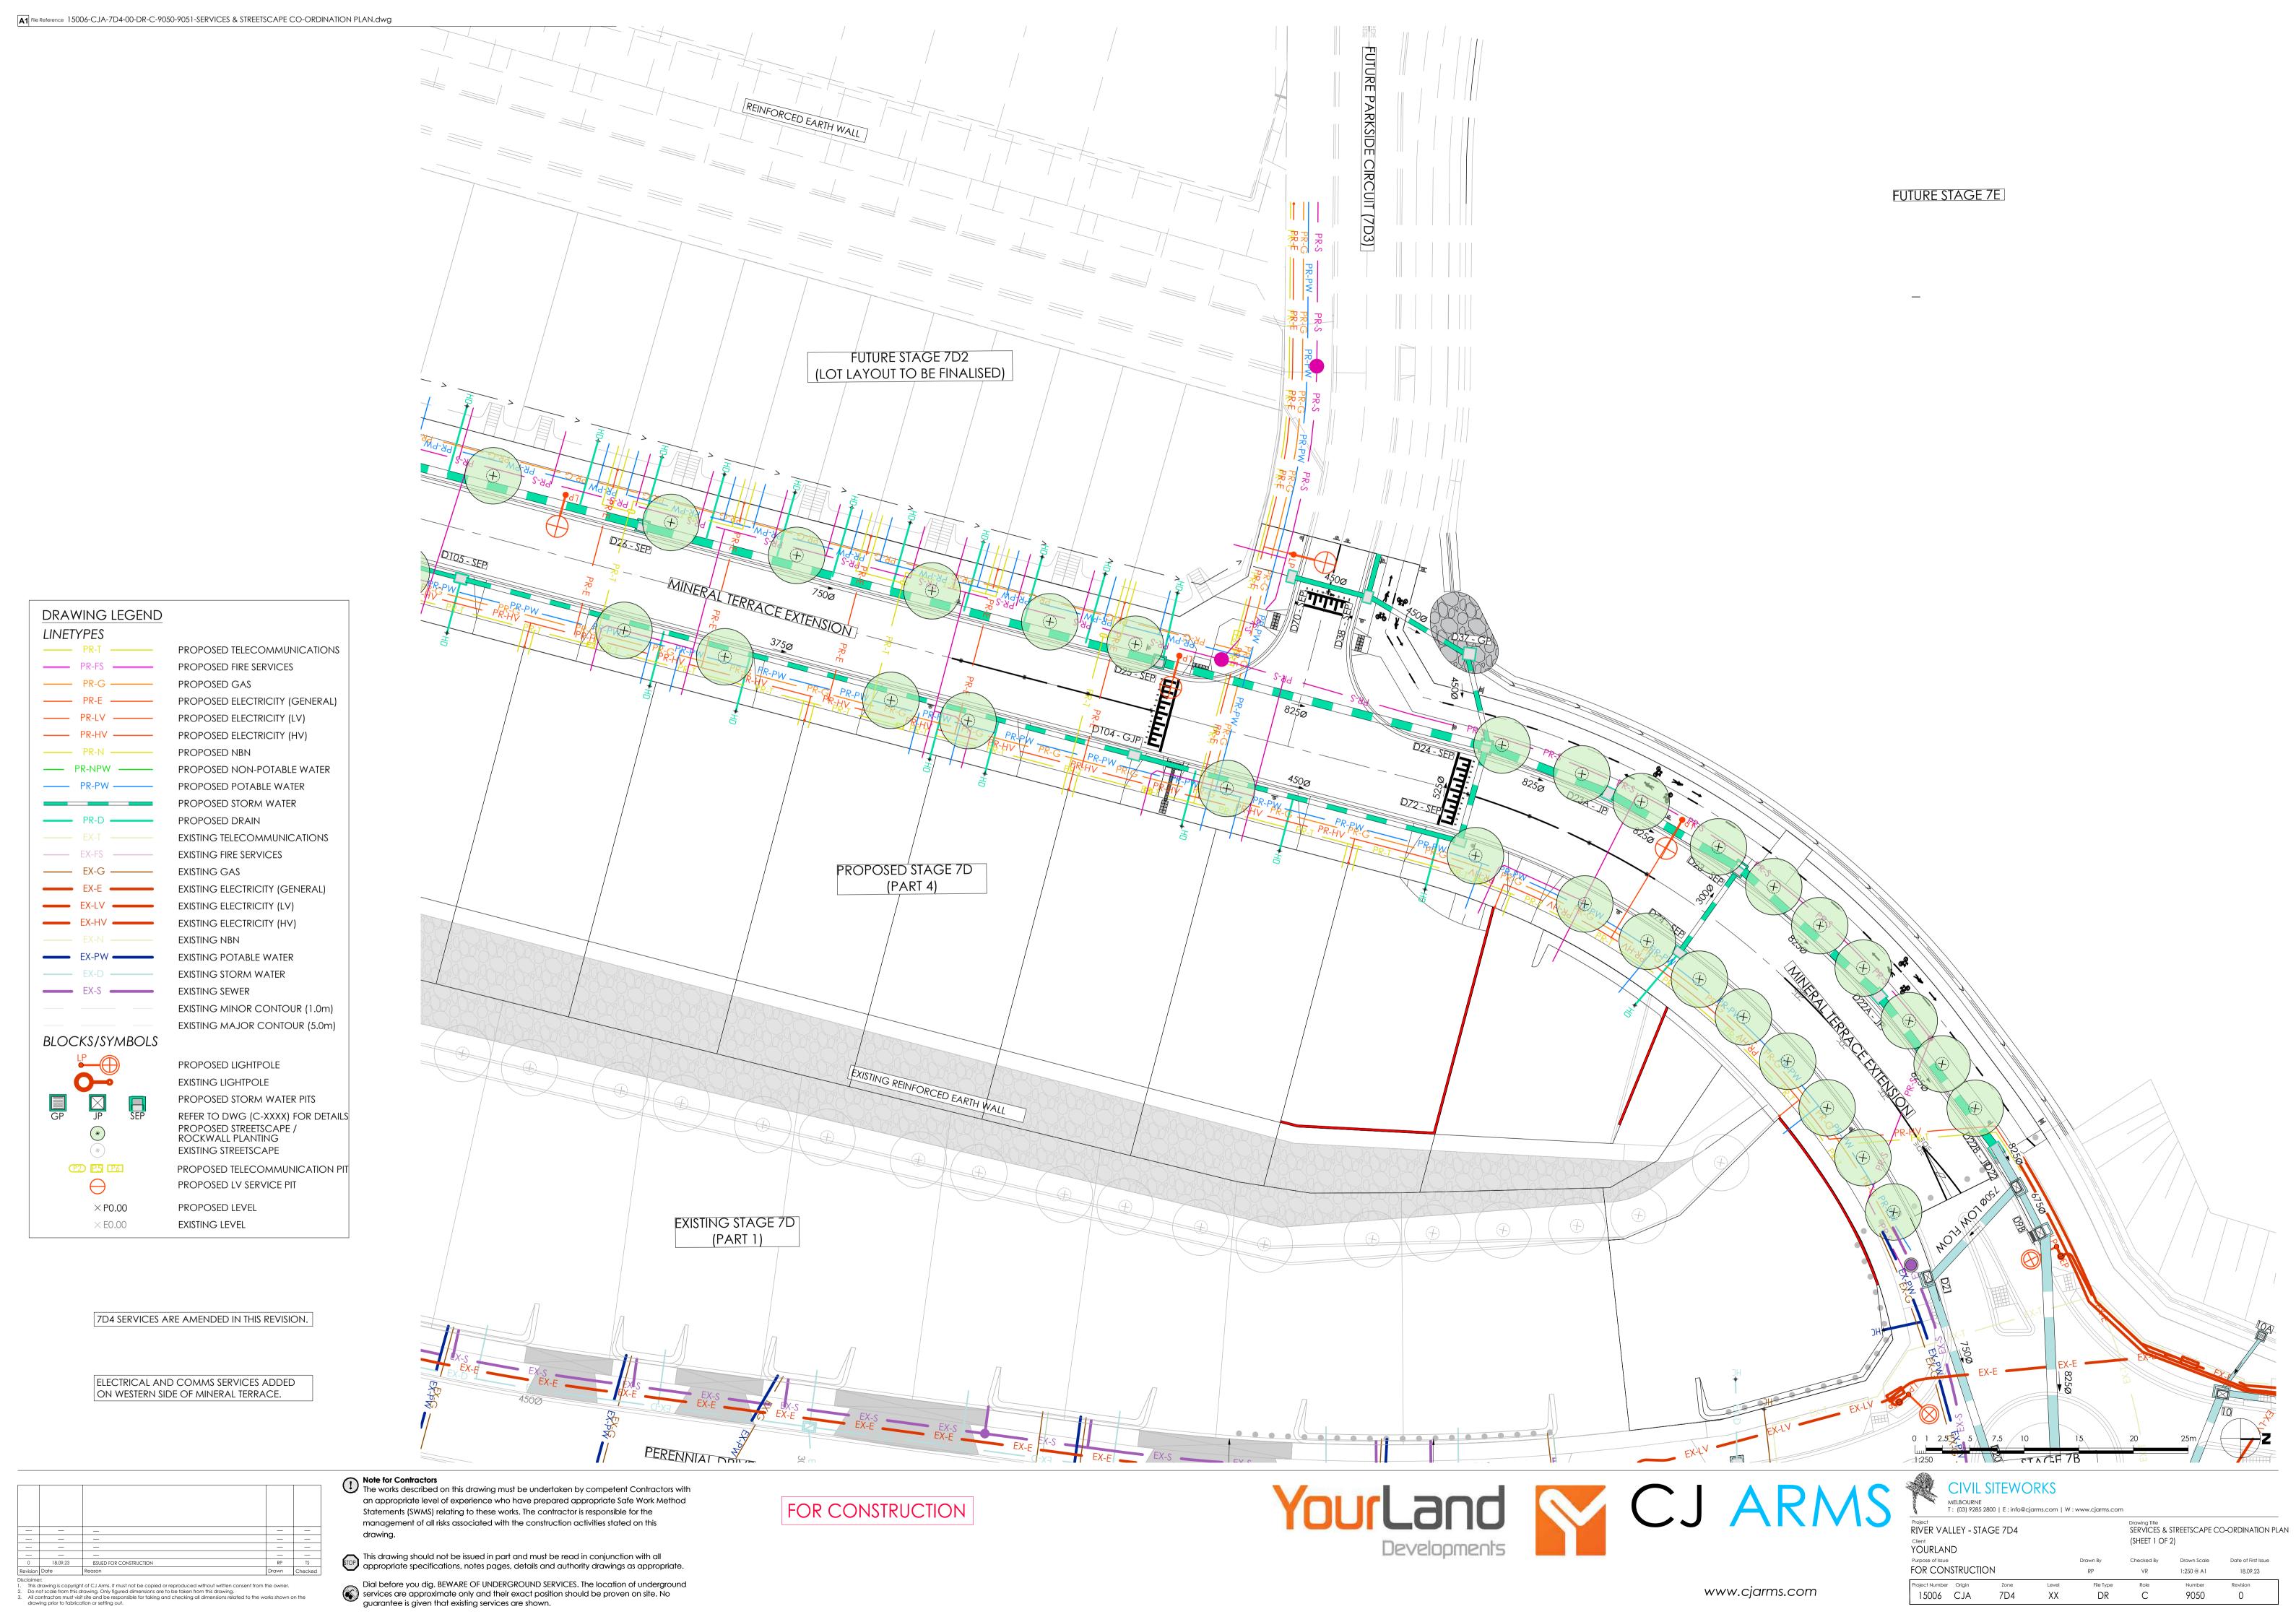
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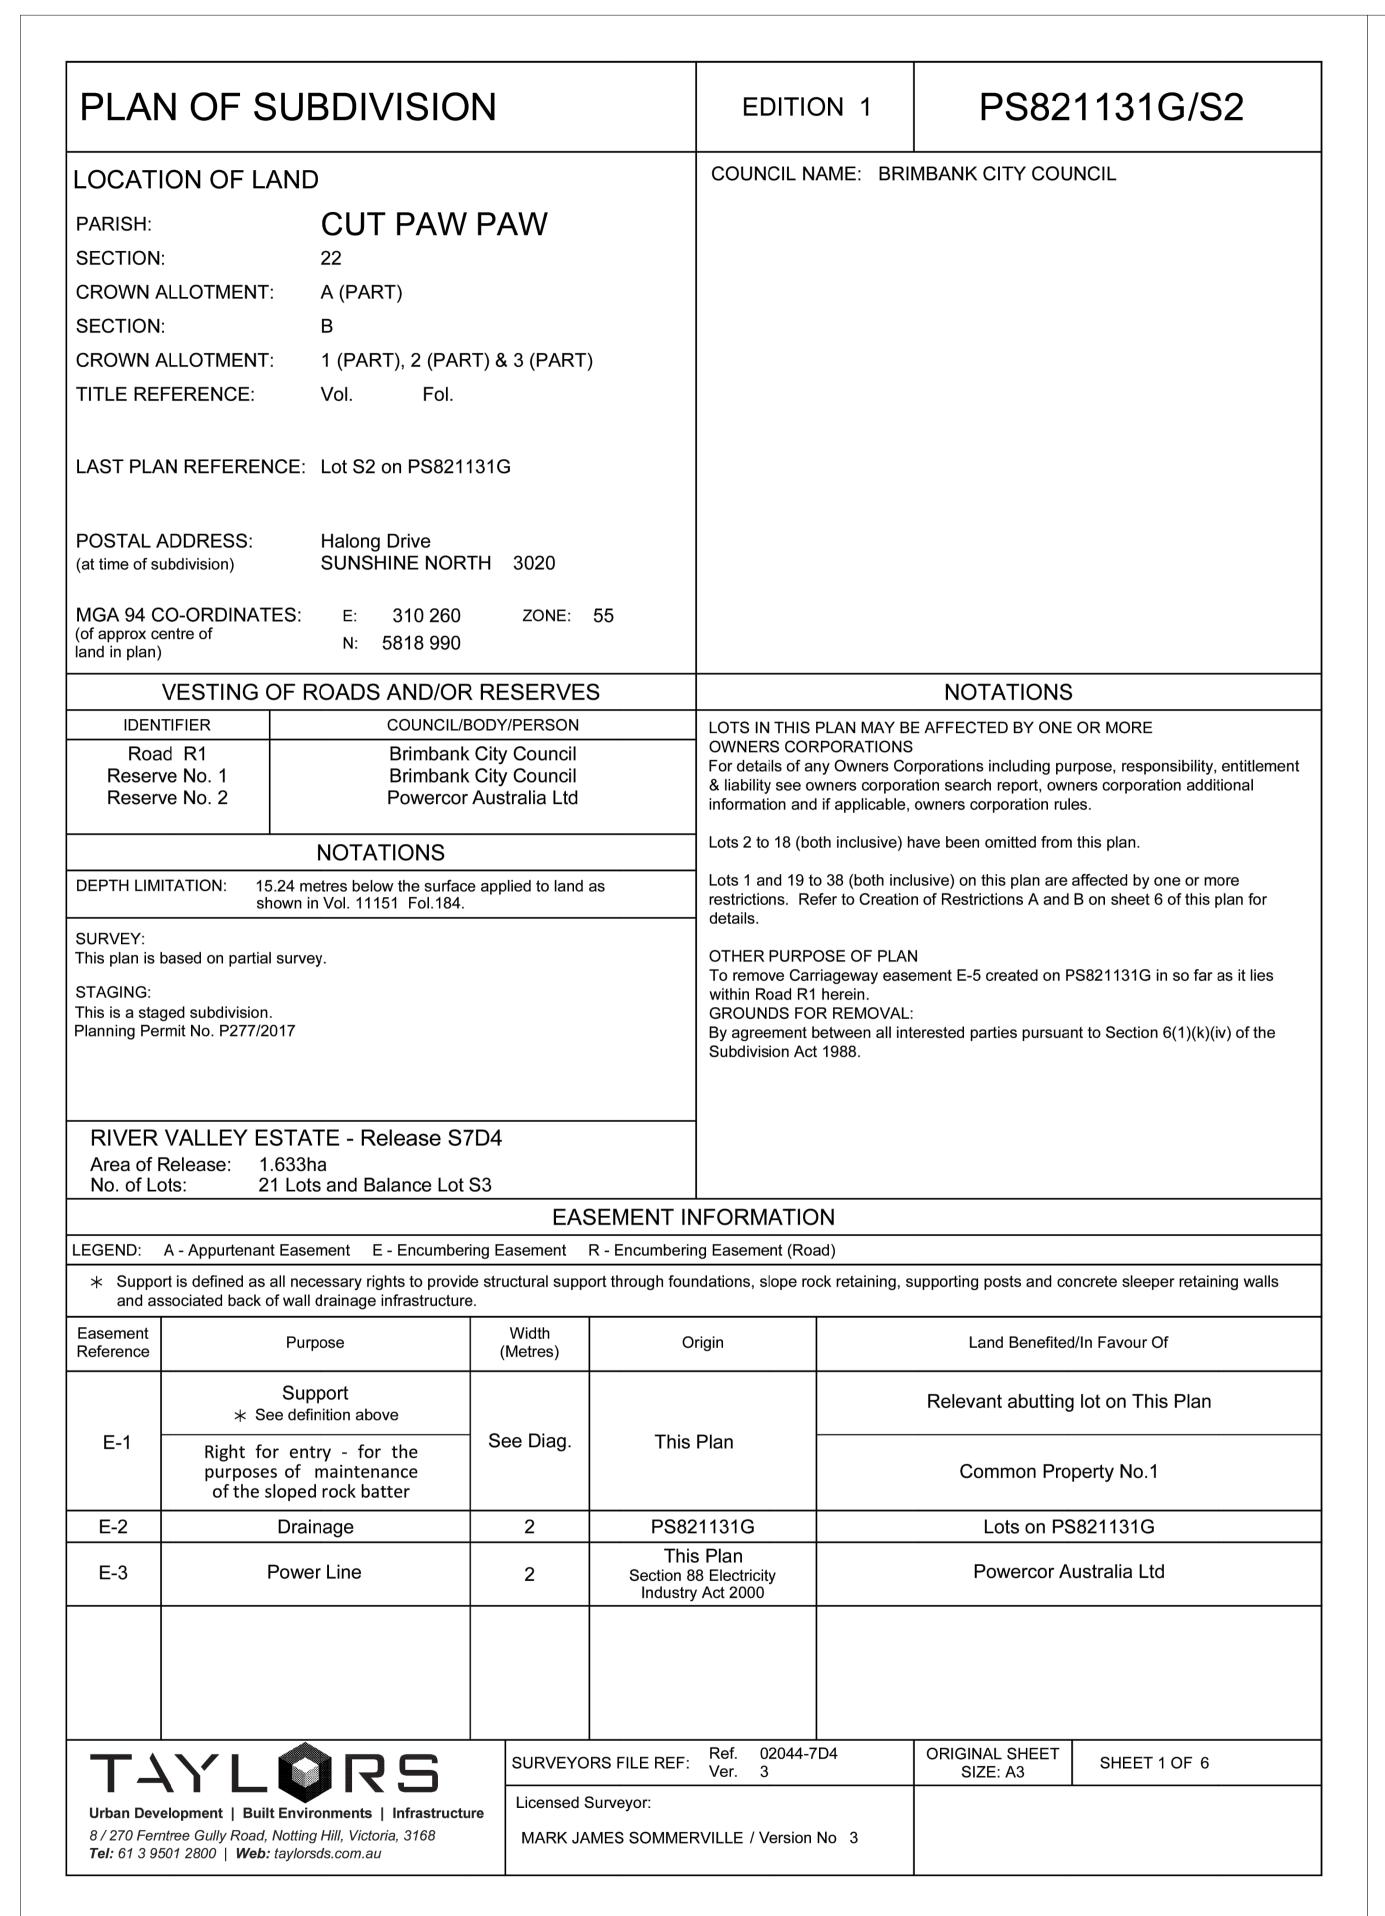






Drawing Title SIGNAGE AND LINEMARKING PLAN (SHEET 2 OF 2) YOURLAND FOR CONSTRUCTION 15006 CJA 7D4 XX DR







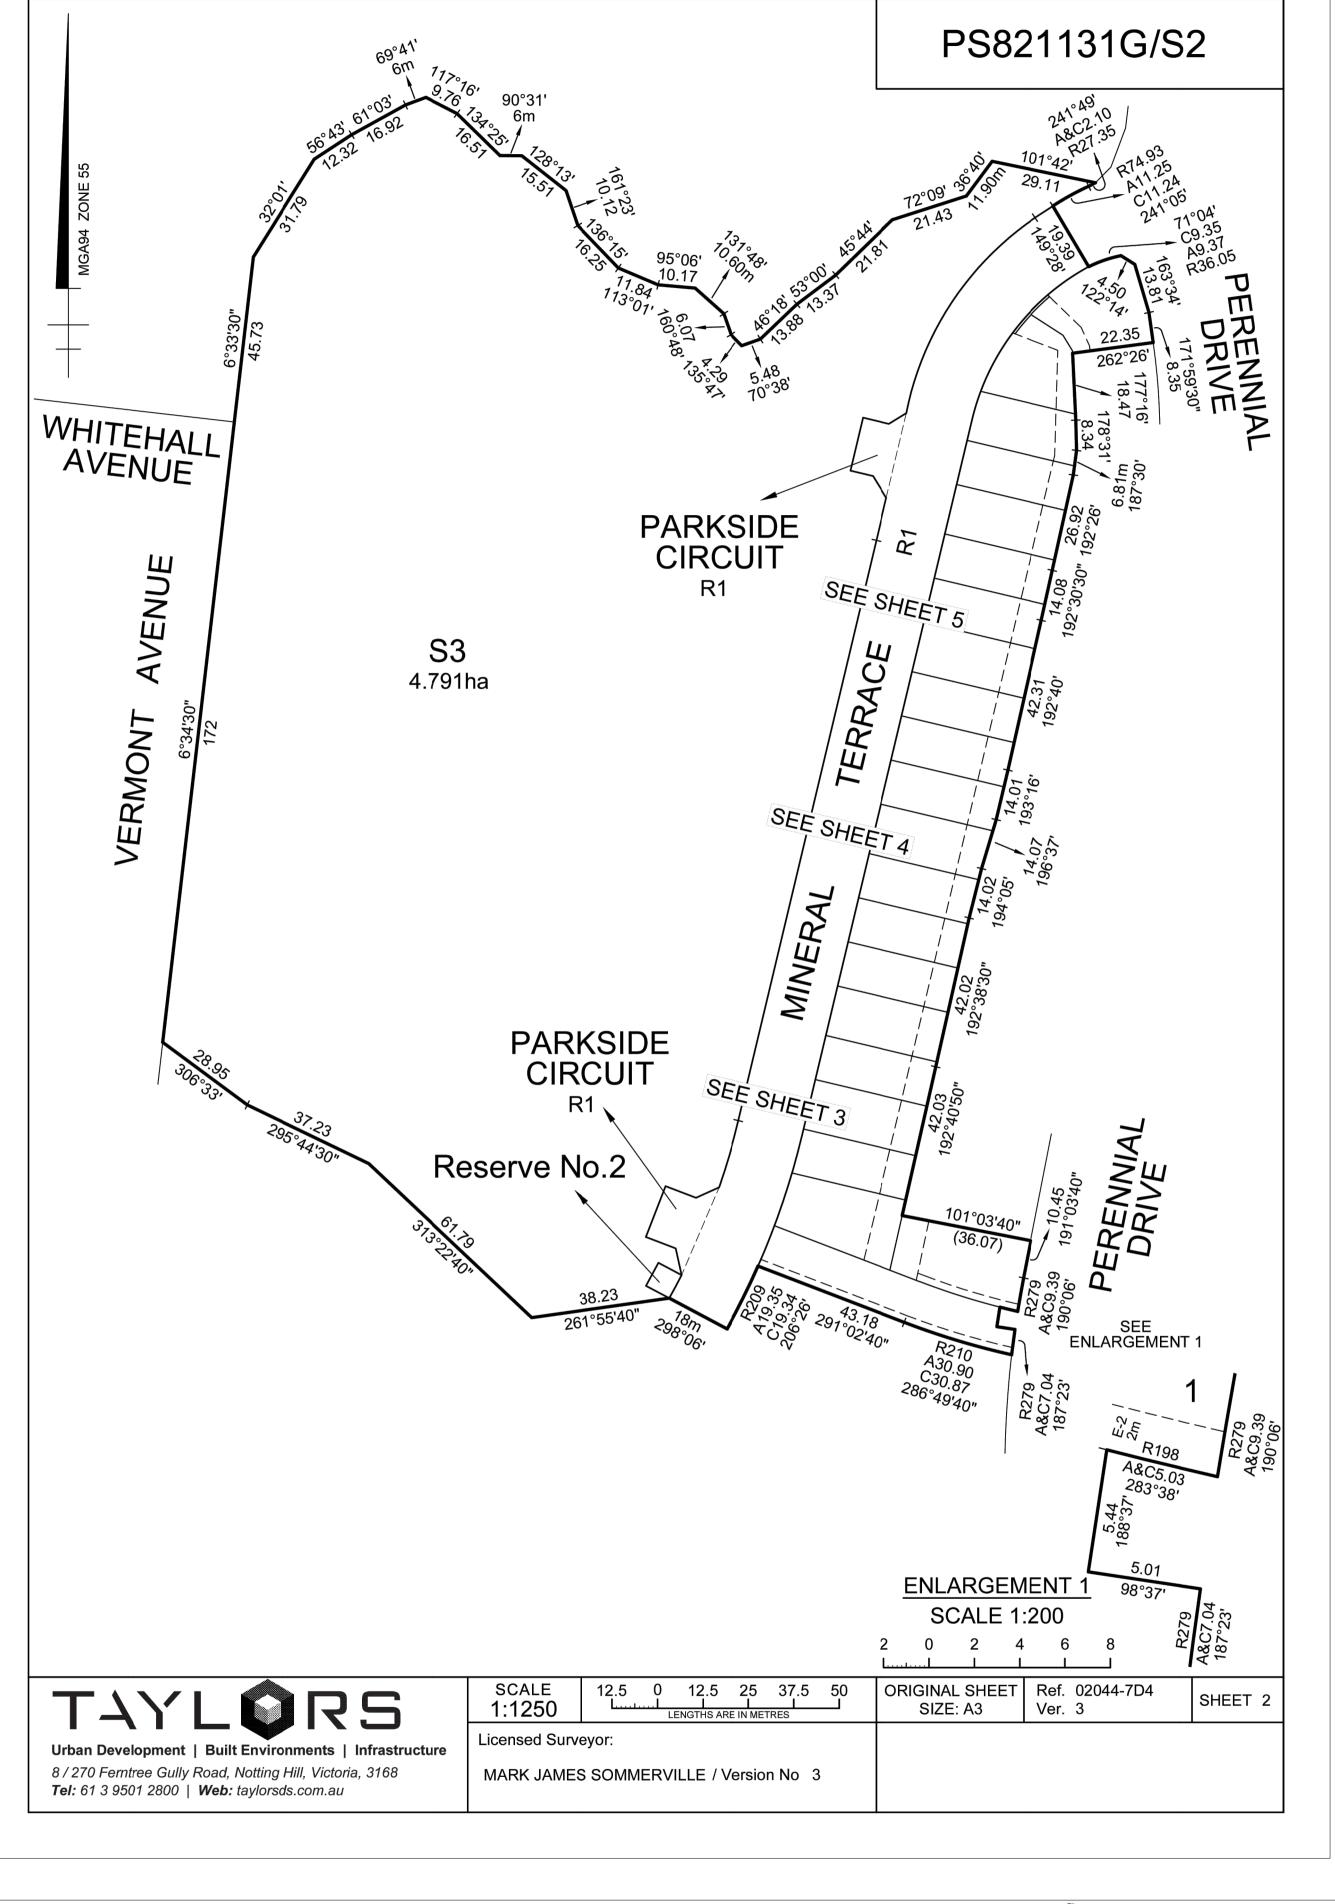

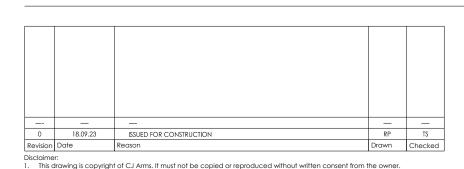

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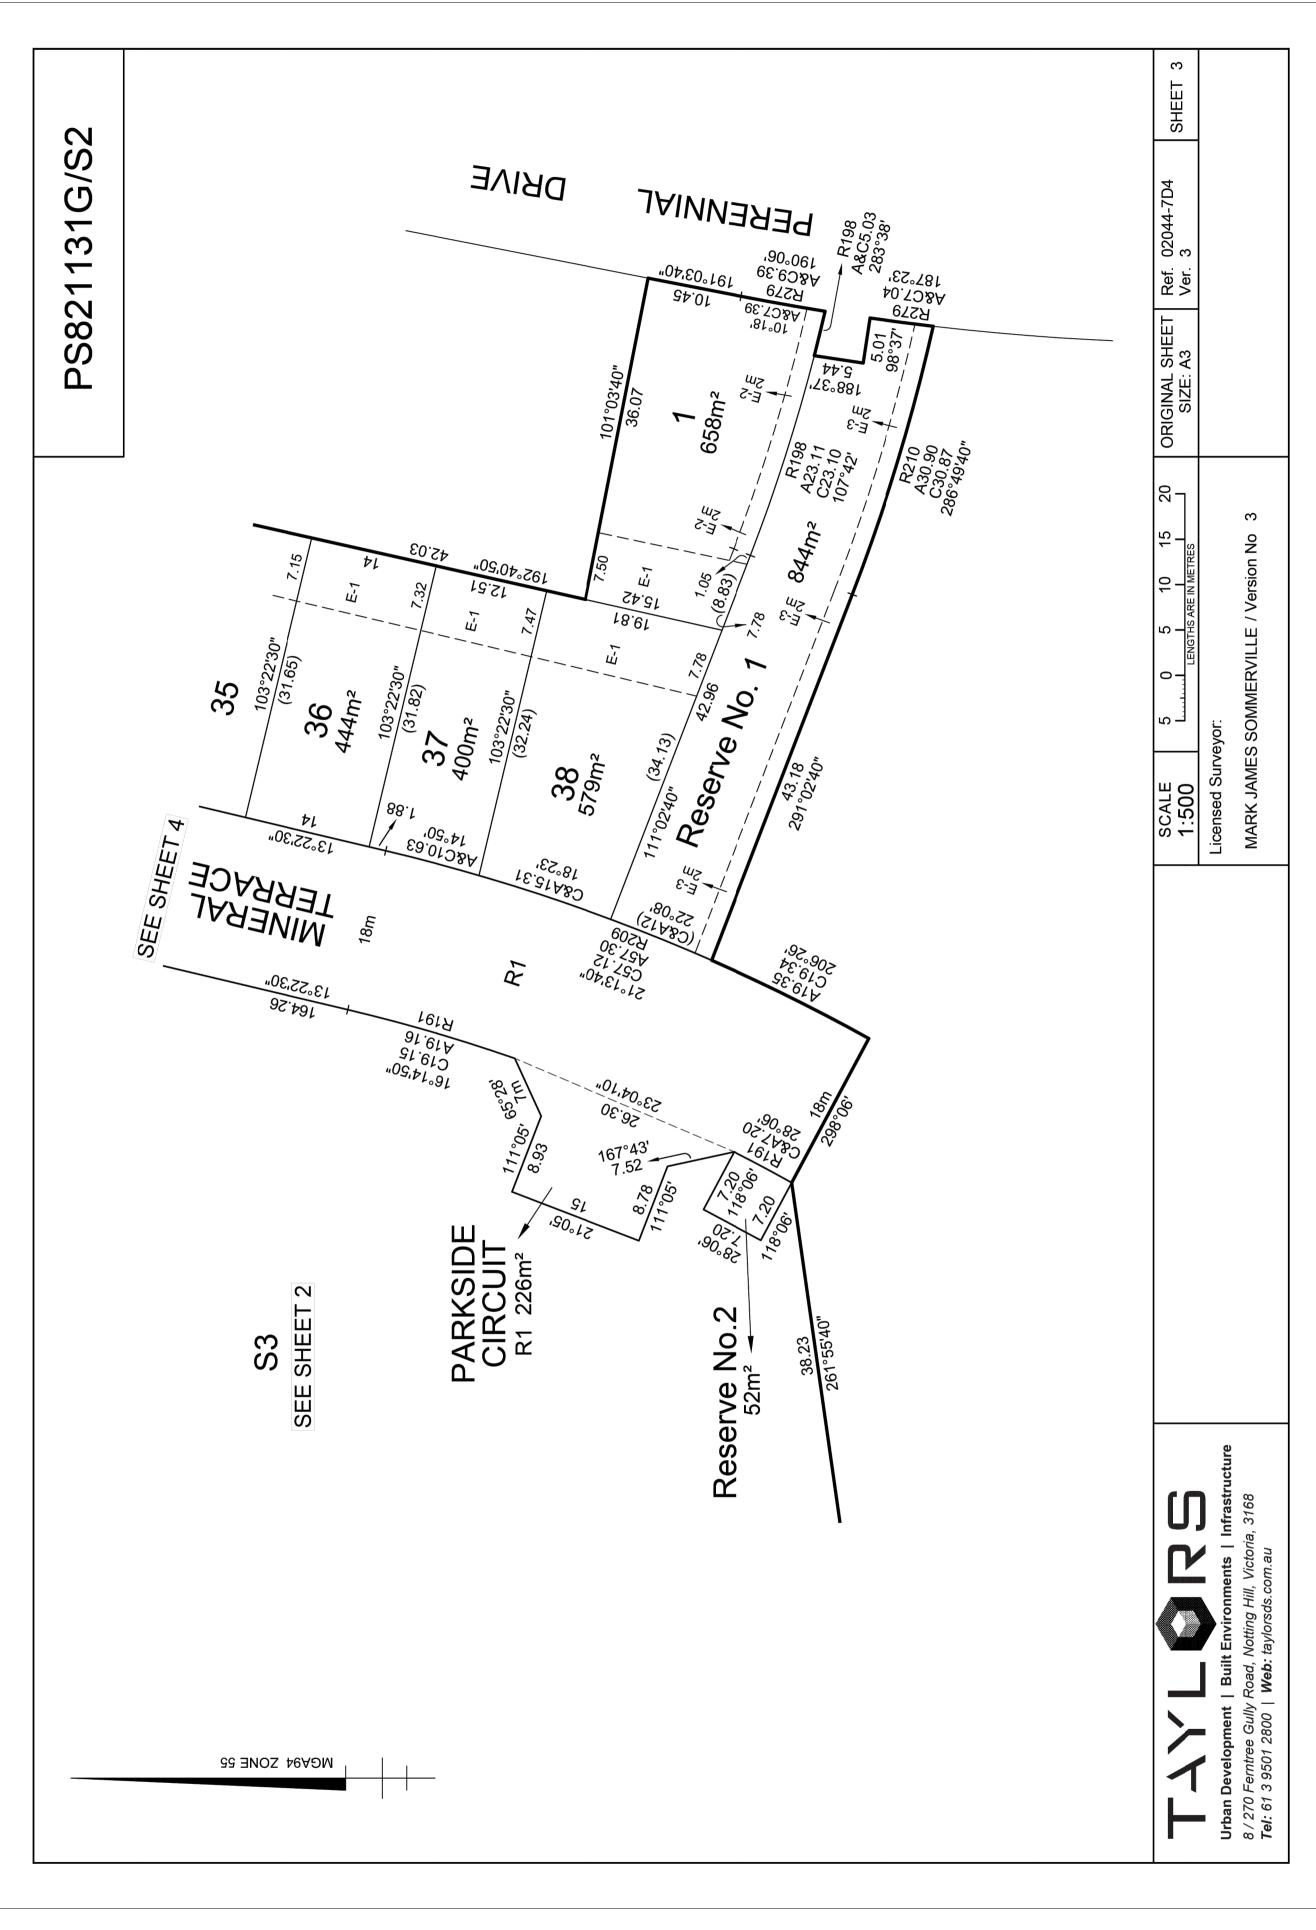
TAYLORS PLAN OF SUB-DIVISION # PS821131G/S2 REF: 02044-7D4 VER: 3


ANY DISCREPANCIES BETWEEN THE DESIGN DRAWINGS AND THE TAYLORS PLAN OF SUB-DIVISION SHALL BE REFERRED










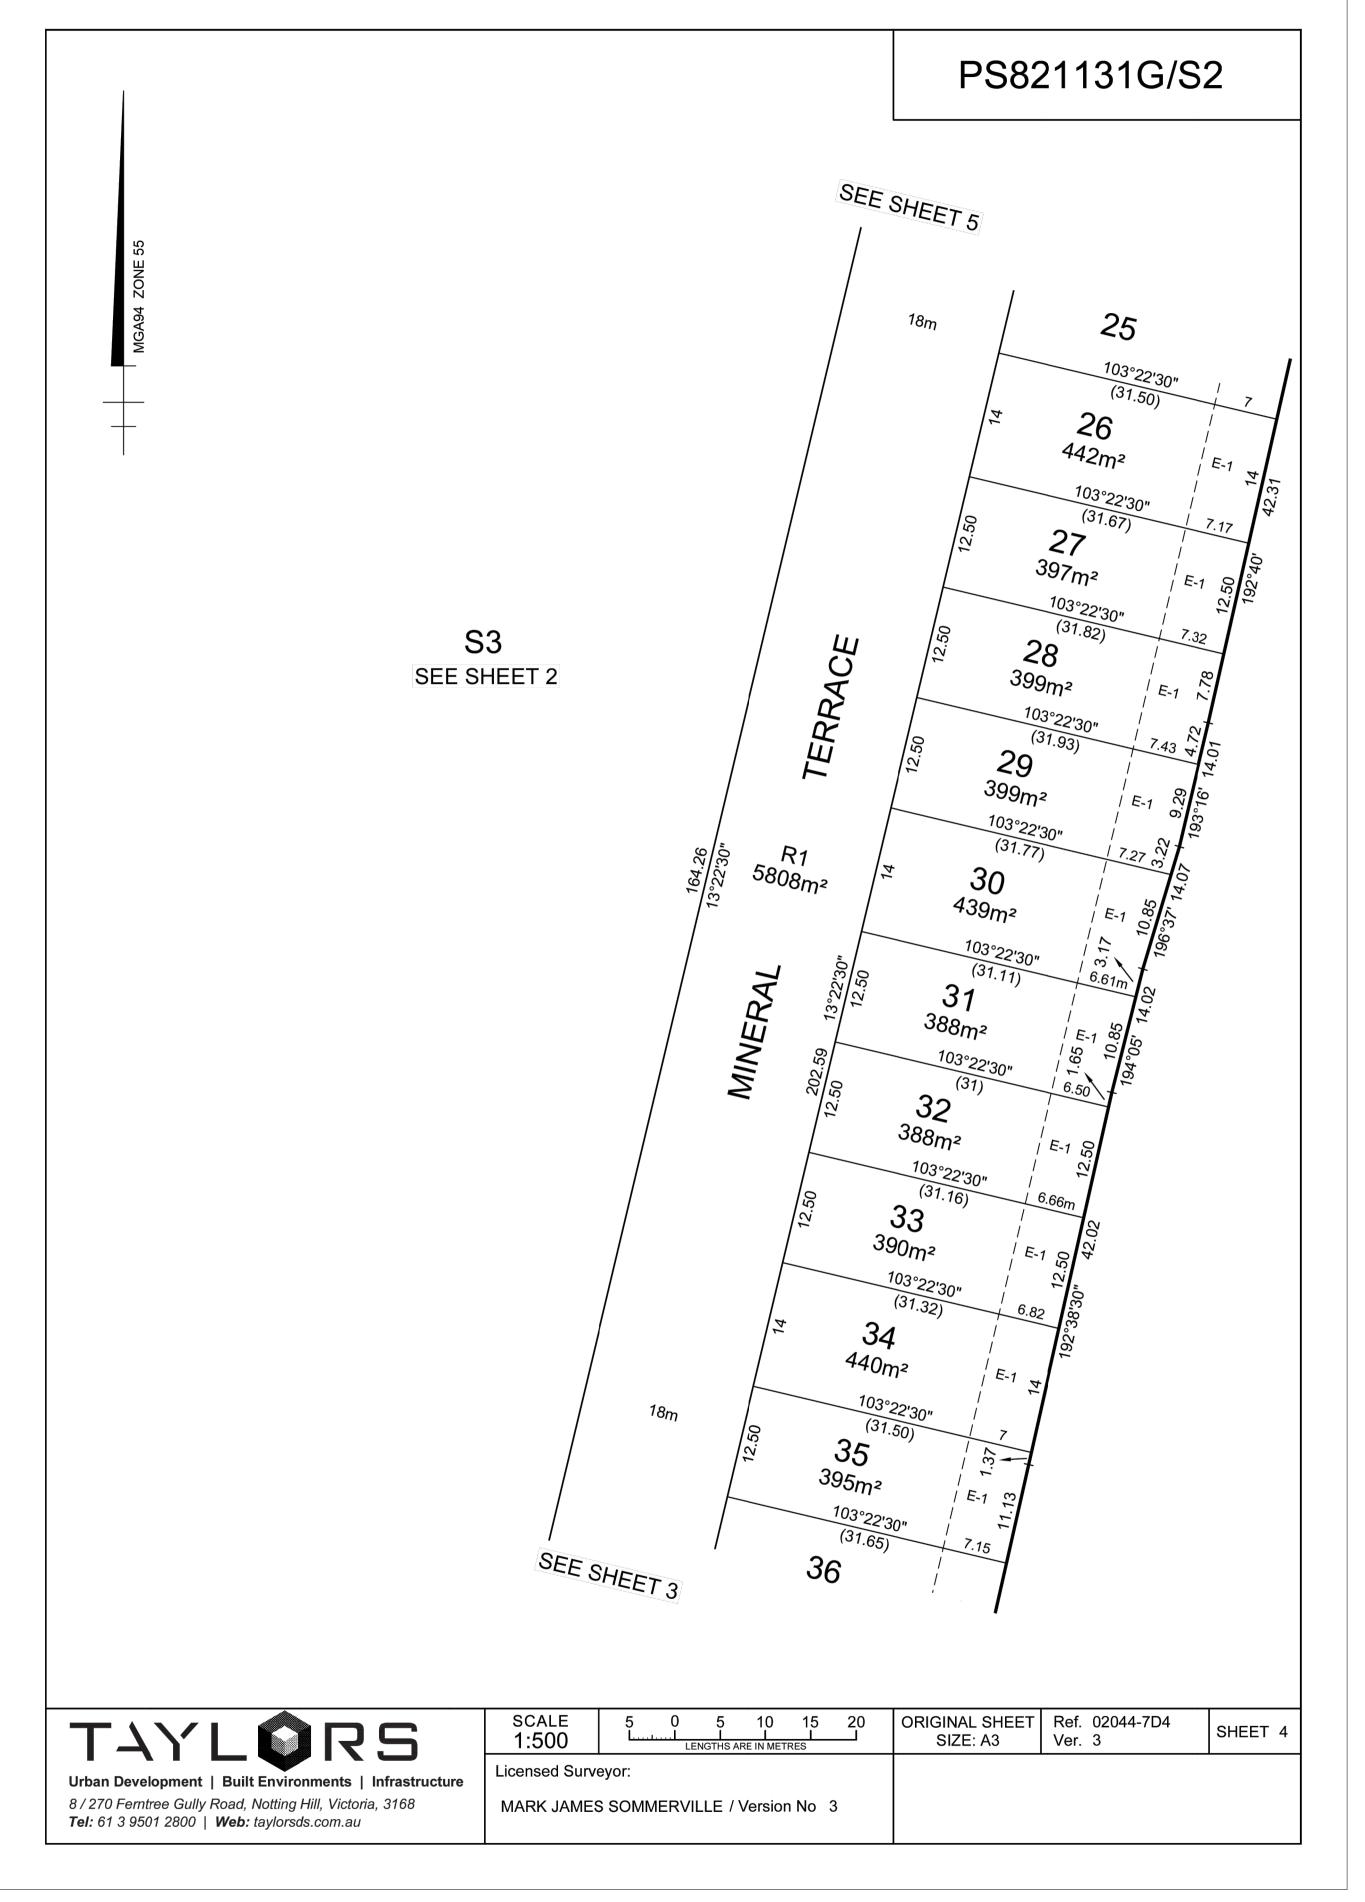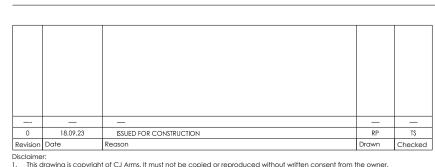



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CIVIL SITEWORKS MELBOURNE SYDNEY T: +61 3 9285 2800 | T: +61 2 8036 8370 | E: info@cjarms.com | W: www.cjarms.com Project RIVER VALLEY - STAGE 7D4 Drawing Title
SUBDIVISION PLAN

(SHEET 2 OF 4) YOURLAND Checked By FOR CONSTRUCTION N/A @ A1 18.09.23 15006 CJA 7D4 XX DR 9201

MARK JAMES SOMMERVILLE / Version No 3

PS821131G/S2

CREATION OF RESTRICTION A

The registered proprietors of the burdened land covenant with the registered proprietors of the benefited land as set out in the restriction with the intent that the burden of the restriction runs with and binds the burdened land and the benefit of the restriction is annexed to and runs with the benefited land.

BURDENED LAND: See Table 1 See Table 1 BENEFITED LAND:

RESTRICTION:

The registered proprietor or proprietors for the time being of any burdened lot on this plan must not construct or allow to be constructed or remain on the lot any building or garage outside the building envelope shown hatched in the diagrams shown on MCP (excluding allowable projecting building elements that project outside the building envelope as contained in Part 5 Regulation 74(3), 79(3) & 79(4) of the Building Regulations 2018).

TABLE 1

IADLLI	
BURDENED LOT No.	BENEFITING LOTS ON THIS PLAN
1	38
19	20
20	19, 21
21	20, 22
22	21, 23
23	22, 24
24	23, 25
25	24, 26
26	25, 27
27	26, 28
28	27, 29

TABLE 1 continued

BURDENED LOT No.	BENEFITING LOTS ON THIS PLAN
29	28, 30
30	29, 31
31	30, 32
32	31, 33
33	32, 34
34	33, 35
35	34, 36
36	35, 37
37	36, 38
38	1, 37

CREATION OF RESTRICTION B

The registered proprietors of the burdened land covenant with the registered proprietors of the benefited land as set out in the restriction with the intent that the burden of the restriction runs with and binds the burdened land and the benefit of the restriction is annexed to and runs with the benefited land.


BURDENED LAND: Lots 1 and 19 to 38 (both inclusive) BENEFITED LAND: Lots 1 and 19 to 38 (both inclusive)

RESTRICTION:

- The registered proprietor or proprietors for the time being of any burdened lot on this plan ("Owner") must not:
 - 1.1.1 undertake or permit to undertake, any site-works, excavation, filling, construction of buildings or works, tree planting, landscaping or any other physical alterations to the structure of the rock down slope and any sub-surface improvements within that part of the burdened lot marked E-1 ("Retaining Wall");
 - 1.1.2 occupy or allow the occupation of the burdened land unless, the Owner maintains on foot an agreement with Owners Corporation No 1 on PS821131G ("Owners Corporation") under which the Owners Corporation:
 - 1.1.2.1 is required to maintain the Retaining Wall in good condition and repair any damage to the Retaining Wall;
 - 1.1.2.2 is required to maintain insurance for the full replacement value of the Retaining Wall; and
 - 1.1.2.3 is granted access to the burdened land to allow for the repair and maintenance of the Retaining Wall;
 - 1.1.3 carry out or allow to be carried out any site-works, excavation, filling or construction or to remove, interfere with or compromise or do anything that may tend to interfere with or compromise the Retaining Wall in any way;

without the prior written consent of Maribyrnong Riverside Development Pty Ltd ACN 629 127 028 or Owners Corporation No 1 on PS821131G.

TAYLORS			ORIGINAL SHEET SIZE: A3	Ref. 02044-7D4 Ver. 3	SHEET 6
Urban Development Built Environments Infrastructure	Licensed Surv	eyor:			
8 / 270 Ferntree Gully Road, Notting Hill, Victoria, 3168 Tel: 61 3 9501 2800 Web: taylorsds.com.au	MARK JAME	S SOMMERVILLE / Version No 3			

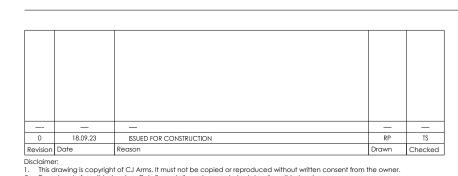

Note for Contractors
The works described on this drawing must be undertaken by competent Contractors with

8 / 270 Ferntree Gully Road, Notting Hill, Victoria, 3168

Tel: 61 3 9501 2800 | Web: taylorsds.com.au

an appropriate level of experience who have prepared appropriate Safe Work Method Statements (SWMS) relating to these works. The contractor is responsible for the management of all risks associated with the construction activities stated on this drawing.

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TAYLORS PLAN OF SUB-DIVISION # PS821131G/S2 REF: 02044-7D4 VER: 3

ANY DISCREPANCIES BETWEEN THE DESIGN DRAWINGS AND THE TAYLORS PLAN OF SUB-DIVISION SHALL BE REFERRED TO THE SUPERINTENDENT.








(SHEET 3 OF 4) FOR CONSTRUCTION N/A @ A1 18.09.23 15006 CJA 7D4 XX DR 9202 С

Drawing Title
SUBDIVISION PLAN

PS821131G/S2 OWNERS CORPORATION SCHEDULE Owners Corporation No. PS821131G/S2 Plan No. ALL LAND AFFECTED BY OWNERS CORPORATION 1 ON PREVIOUS STAGES OF THIS PLAN AND ALL OF Land affected by Owners Corporation Lots: THE LOTS IN THE TABLE BELOW Common Property No.: 1 Limitations of Owners Corporation: UNLIMITED Notations Entitlement Liability This schedule Overall Total Lot Entitlement and Lot Liability Liability Entitlement Entitlement Liability Entitlement Liability Entitlement Lot SURVEYORS FILE REFERENCE: 02044-7D4 SHEET TAYLORS ORIGINAL SHEET SIZE: A3 Urban Development | Built Environments Infrastructure | Engineering and Project Management

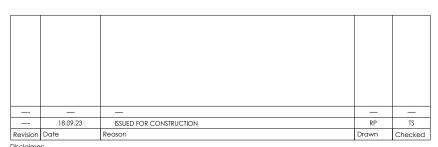MARK JAMES SOMMERVILLE / VERSION No.2-



Note for Contractors

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TAYLORS PLAN OF SUB-DIVISION # PS821131G/S2 REF: 02044-7D4 VER: 3 ANY DISCREPANCIES BETWEEN THE DESIGN DRAWINGS AND THE TAYLORS PLAN OF SUB-DIVISION SHALL BE REFERRED

8/270 Ferntree Gully Road, Notting Hill VIC 3168 Phone: (03) 9501 2800 www.taylorsds.com.au

FOR CONSTRUCTION





15006 CJA 7D4 XX

MELBOURNE SYDNE
T: +61 3 9285 2800 | T: +61 :

Project
RIVER VALLEY - STAGE 7D4
Client
YOURLAND (SHEET 4 OF 4) FOR CONSTRUCTION

DR C





ENGINEER

WITHIN THE SUBDIVISION PRIOR TO THE CIVIL WORKS BEING UNDERTAKEN.

0 18.09.23 ISSUED FOR CONSTRUCTION
Revision Date Reason

drawing.

Statements (SWMS) relating to these works. The contractor is responsible for the management of all risks associated with the construction activities stated on this

Note for Contractors

The works described on this drawing must be undertaken by competent Contractors with

an appropriate level of experience who have prepared appropriate Safe Work Method

This drawing should not be issued in part and must be read in conjunction with all appropriate specifications, notes pages, details and authority drawings as appropriate.


Dial before you dig. BEWARE OF UNDERGROUND SERVICES. The location of underground services are approximate only and their exact position should be proven on site. No guarantee is given that existing services are shown.



CIVIL SITEWORKS


T: (03) 9285 2800 | E:info@cjarms.com | W:www.cjarms.com Project RIVER VALLEY - STAGE 7D4 Drawing Title
FILL LAYOUT PLAN (SHEET 1 OF 2) YOURLAND FOR CONSTRUCTION 1:250 @ A1 18.09.23 15006 CJA 7D4 XX DR 9900



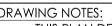

- THIS PLAN DETAILS AREAS IN WHICH 300mm OR GREATER OF FILL WILL BE PLACED ON TOP OF THE NATURAL SURFACE OF THE LAND WITHIN THE SUBDIVISION AS A RESULT OF THE
- THIS PLAN DOES NOT DETAIL ANY OTHER FILL MATERIAL THAT MAY HAVE BEEN PLACED WITHIN THE SUBDIVISION PRIOR TO THE CIVIL WORKS BEING UNDERTAKEN.
- IRRESPECTIVE OF THE DEPTH OF FILL DETAILED ON THIS PLAN, FOUNDATIONS MUST BE DESIGNED AND CONSTRUCTED IN ACCORDANCE WITH BUILDING REGULATIONS AND WILL TAKE INTO ACCOUNT THE SOIL CLASSIFICATION AND SOIL REPORT PREPARED FOR
- THE EXTENT AND DEPTH OF FILL SHOWN ON THIS PLAN WILL BE CONFIRMED ON-SITE BY A GEOTECHNICAL INVESTIGATION BY A REGISTERED AND EXPERIENCED GEOTECHNCIAL ENGINEER



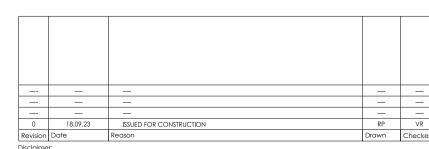

Note for Contractors

The works described on this drawing must be undertaken by competent Contractors with an appropriate level of experience who have prepared appropriate Safe Work Method Statements (SWMS) relating to these works. The contractor is responsible for the management of all risks associated with the construction activities stated on this drawing.

This drawing should not be issued in part and must be read in conjunction with all appropriate specifications, notes pages, details and authority drawings as appropriate.

Dial before you dig. BEWARE OF UNDERGROUND SERVICES. The location of underground services are approximate only and their exact position should be proven on site. No guarantee is given that existing services are shown.





Project RIVER VALLEY - STAGE 7D4 Drawing Title
FILL LAYOUT PLAN (SHEET 2 OF 2) Client YOURLAND FOR CONSTRUCTION 1:250 @ A1 DR 15006 CJA 7D4 XX

18.09.23