# RIVER VALLEY - STAGE 7D1


PERENNIAL DRIVE, SUNSHINE NORTH, VIC

CIVIL SITEWORKS



LOCATION PLAN (N.T.S)

	DRAWING SCHEDULE
Sheet Number	Sheet Title
15006-CJA-7D1-00-DR-C-0000	TITLE SHEET AND DRAWING SCHEDULE
15006-CJA-7D1-00-DR-C-0001	NOTES PAGE
15006-CJA-7D1-00-DR-C-0100	EXISTING CONDITIONS
15006-CJA-7D1-00-DR-C-1000	OVERALL LAYOUT PLAN
15006-CJA-7D1-00-DR-C-1100	DETAILED LAYOUT PLAN-SHEET 1 OF 2
15006-CJA-7D1-00-DR-C-1101	DETAILED LAYOUT PLAN-SHEET 2 OF 2
15006-CJA-7D1-00-DR-C-1110	DETAILED DRAINAGE PLAN (SHEET 1 OF 2)
15006-CJA-7D1-00-DR-C-1111	DETAILED DRAINAGE PLAN (SHEET 2 OF 2)
15006-CJA-7D1-00-DR-C-2000	TYPICAL SECTION-WHOLE SITE
15006-CJA-7D1-00-DR-C-4000	LONGSECTION -ROCKWALL A - SHEET 1 OF 2
15006-CJA-7D1-00-DR-C-4001	LONG SECTION AND SETOUT-ROCKWALL A - SHEET 2 OF 2
15006-CJA-7D1-00-DR-C-4002	LONGSECTION - LANDSCAPE RETAINING WALL - SHEET 1 OF 2
15006-CJA-7D1-00-DR-C-4003	LONGSECTION AND SETOUT - LANDSCAPE RETAINING WALL - SHEET 2 OF 2
15006-CJA-7D1-00-DR-C-4004	LONGSECTION AND SETOUT - CONCRETE SLEEPER WALL
15006-CJA-7D1-00-DR-C-8018	CONSTRUCTION DETAILS-RETAINING WALL-SHEET 1 OF 5
15006-CJA-7D1-00-DR-C-8019	CONSTRUCTION DETAILS-RETAINING WALL-SHEET 2 OF 5
15006-CJA-7D1-00-DR-C-8020	CONSTRUCTION DETAILS-RETAINING WALL-SHEET 3 OF 5
15006-CJA-7D1-00-DR-C-8021	CONSTRUCTION DETAILS-RETAINING WALL-SHEET 4 OF 5
15006-CJA-7D1-00-DR-C-8022	CONSTRUCTION DETAILS-RETAINING WALL-SHEET 5 OF 5
15006-CJA-7D1-00-DR-C-9900	FILL LAYOUT PLAN-SHEET 1 OF 2
15006-CJA-7D1-00-DR-C-9901	FILL LAYOUT PLAN-SHEET 2 OF 2
15006-CJA-7D1-00-DR-C-9200	SUB-DIVISION PLANS - SHEET 1 OF 4
15006-CJA-7D1-00-DR-C-9201	SUB-DIVISION PLANS - SHEET 2 OF 4
15006-CJA-7D1-00-DR-C-9202	SUB-DIVISION PLANS - SHEET 3 OF 4
15006-CJA-7D1-00-DR-C-9203	SUB-DIVISION PLANS - SHEET 4 OF 4
15006-CJA-7D-XX-DR-EW-1000	BULK EARTHWORKS - CUT AND FILL PLAN

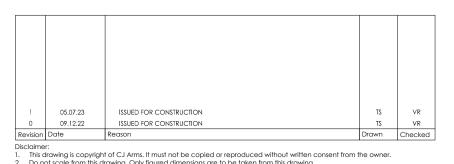

Note for Contractors

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Project RIVER VALLEY - STAGE 7D1 Drawing Title
TITLE SHEET AND DRAWING SCHEDULE YOURLAND ISSUED FOR CONSTRUCTION 15006 CJA 7D1 DWG

#### GENERAL BRIMBANK CITY COUNCIL NOTES

- 1. ALL WORKS TO BE CARRIED OUT IN ACCORDANCE WITH THE SPECIFICATIONS APPROVED BY THE BRIMBANK CITY COUNCIL, BRIMBANK CITY COUNCIL STANDARD DRAWINGS AND TO THE SATISFACTION OF THE SURVEILLANCE COORDINATOR OR HIS REPRESENTATIVE.
- 2. NO TREES AND SHRUBS ARE TO BE REMOVED UNLESS PRIOR APPROVAL HAS BEEN OBTAINED FROM THE RELEVANT AUTHORITY.
- 3. WHERE WORKS ARE IN THE VICINITY OF EXISTING SERVICES, THESE SERVICES ARE TO BE LOCATED PRIOR TO THE COMMENCEMENT OF WORKS.
- 4. ALL VEHICLE CROSSINGS, DRAINAGE PITS, PRAM RAMPS, BOLLARDS ETC SHALL BE CONSTRUCTED AS PER COUNCILS STANDARD DRAWINGS UNLESS OTHERWISE
- COUNCIL'S SURVEILLANCE COORDINATOR MUST BE NOTIFIED IN WRITING, NO LESS
- THAN SEVEN (7) DAYS PRIOR TO THE COMMENCEMENTS OF WORKS. SUBMIT APPLICATION FOR CONSTRUCTION ACCESS TO SITE FOR APPROVAL BY COUNCIL'S SURVEILLANCE COORDINATOR BEFORE COMMENCEMENT OF ANY
- 7. CONTRACTORS ARE RESPONSIBLE WITH RESPECT TO SAFETY OF WORK ON SITE AND APPROPRIATE LEGISLATION.
- 8. FOOTPATHS ARE TO BE OFFSET 25mm FROM THE PROPERTY LINE AND
- CONSTRUCTED AS PER BRIMBANK STANDARD DRAWING \$350. 9. VICROADS' ROADWORK SIGNING CODE OF PRACTICE WHICH COMPLIES WITH AUSTRALIAN STANDARD 1742.3-2002 IS TO BE ADHERED TO DURING
- CONSTRUCTION WORKS (OR ANY SUBSEQUENT LATER VERSION). 10. WHERE DRAINAGE PIPES ARE LOCATED WITHIN NATURE STRIPS, THE TRENCH SHALL BE BACKFILLED WITH COMPACTED 20MM CLASS 3 CRUSHED ROCK UP TO A LEVEL WHERE THE 45DEG. INFLUENCE LINE FROM THE B.O.K. INTERSECTS WITH THE NEAREST
- 11. ALL DRAINAGE PIPES 225mm AND ABOVE SHALL BE SPIGOT & SOCKET TYPE AND RUBBER RING JOINTED CLASS 4 MINIMUM REINFORCED CONCRETE PIPE.
- 12. PROVIDE CCTV FOR COMPLETED DRAINS AS PER CONDUIT INSPECTION REPORTING CODE WSA LATEST VERSION PRIOR TO PRACTICAL COMPLETION OR STATEMENT OF COMPLIANCE, WHICHEVER IS EARLIER
- 13. SERVICE CONDUITS ARE TO BE PROVIDED UNDER FOOTPATHS EXTENDING INTO ALLOTMENTS - LOCATION TO BE MARKED ON THE FOOTPATH AND KERB. 14. AG DRAINS TO BE PROVIDED BEHIND ALL KERBS AT INTERFACE OF EXISTING AND
- NEW PAVEMENT AND SHOULD HAVE SUITABLE OUTLET. REFER TO COUNCIL'S STANDARD DRAWING S110 FOR BACKFILL MATERIAL ETC. SOME WORKS MAY REQUIRE SPECIAL CONSIDERATION EG. VICROADS STANDARDS. 15. CONDUITS ARE TO BE CLEARLY MARKED ON THE KERB AND FOOTPATH FOR EASY
- IDENTIFICATION
- 16. ALL SERVICING TRENCHES UNDER ROAD CARRIAGEWAYS, FOOTPATHS, VEHICLE CROSSINGS AND OTHER STRUCTURES ARE TO BE BACKFILLED WITH 20mm CLASS 3 CRUSHED ROCK IN ACCORDANCE WITH SECTION 706 OF COUNCIL'S STANDARD SPECIFICATION FOR ROADS AND DRAINAGE WORKS IN LAND DEVELOPMENT.
- 17. ALL SERVICES MUST BE CONSTRUCTED PRIOR TO THE CONSTRUCTION OF THE KERB AND CHANNEL
- 18. TMP TO BE SUBMITTED TO COUNCIL'S SURVEILLANCE AND/OR TRAFFIC & TRANSPORT SECTION 7 DAYS PRIOR TO COMMENCEMENT OF WORKS FOR ACCEPTANCE.
- 19. STREET LIGHTING SHALL BE LED 18W FOR STANDARD FITTING AND LED 16W TOORAK/TOORAK ALPHA FOR DECORATIVE NON-STANDARD FITTING.
- 20. THE DRAWINGS, "MUST NOT BE SCALED/MEASURED' FROM HARD OR DIGITAL COPIES.
- 21. MINIMUM EARTHWORKS FILLING REQUIREMENTS FOR ALL ROAD WORKS: a. ROAD FILLING WORKS SHALL BE IN ACCORDANCE WITH SECTION 204 OF COUNCIL'S STANDARD SPECIFICATION FOR ROADS AND DRAINAGE WORKS IN LAND DEVELOPMENT.
- b. TYPE A FILL IS REQUIRED FOR THE LAST 200mm LAYER UNDER ROAD PAVEMENTS, FOOTPATHS, VEHICLE CROSSINGS, NATURE STRIPS AND OTHER ROAD STRUCTURES.
- C. TYPE A MATERIAL IS SPECIFIED IN SECTION 204 OF COUNCIL'S STANDARD SPECIFICATION FOR ROADS AND DRAINAGE WORKS IN LAND DEVELOPMENTS (EQUIVALENT TO THE LATEST VERSION OF VICROADS' CONTRACT SPECIFICATIONS) AND SHALL HAVE MAXIMUM SWELL OF ≤1.5%, MAXIMUM PERMEABILITY OF 5 X 10<sup>-7</sup> CM/SEC, MAXIMUM BOULDER SIZE IS 75 MM ROCK WITH NO OTHER GRADING REQUIREMENTS, AND WITH 99% OF STANDARD COMPACTIVE EFFORT (SCALE A OF TABLE 204.131).
- d. NATURE STRIP WIDTHS SHALL BE FINISHED OFF WITH 100mm THICK TOP SOIL MATERIAL RECOVERED FROM STRIPPING PRIOR TO THE CONSTRUCTION OF EARTHWORKS OR OTHER IMPORTED TOPSOIL TO COMPLY WITH COUNCIL'S LANDSCAPE REQUIREMENTS.
- 22. FILL MATERIAL TO BE IMPORTED TO SITE WILL BE SUBJECT TO THE FOLLOWING
  - CONTROLS: a. BORROW MATERIAL FOR FILLING WORKS IS TO BE SIGNED OFF BY A SUITABLY QUALIFIED INDEPENDENT ENVIRONMENTAL SCIENTIST TO BE CLEAN FILL TO MEET EPA DEFINITION. THE SCIENTIST MUST BE RECOGNISED BY THE EPA TO
  - UNDERTAKE SUCH A JOB. THE INDEPENDENT ENVIRONMENTAL SCIENTIST IS TO CERTIFY THAT THE SOURCE OR SOURCES OF BORROW MATERIAL TO MEET THE EPA DEFINITION OF CLEAN FILL SUITABLE FOR ROAD CONSTRUCTION. THE SCIENTIST IS TO OVERSEE ALL TESTING, FREQUENCY OF TESTING, ETC. TO MEET EPA
  - REQUIREMENTS FOR CLEAN FILL. THE SCIENTIST IS TO ENSURE THAT ONLY THE CERTIFIED CLEAN FILL MATERIAL IS USED. TRANSPORTATION DOCKETS ARE TO BE ISSUED FOR EACH TRUCK LOAD. DATE AND TIME OF LOADING AND ARRIVAL ON SITE ARE TO BE
  - AT THE END OF BORROW FILLING, A REPORT IS TO BE SUBMITTED TO COUNCIL BY THE INDEPENDENT SCIENTIST DETAILING THE TESTINGS CARRIED OUT LEADING TO THE APPROVAL OF THE SOURCE OR SOURCES.
  - THE REPORT IS ALSO TO INCLUDE COPIES OF ALL THE TRANSPORTATION DOCKETS AND SUMMARY OF THE REQUIRED BORROW VOLUME.
  - IN THE REPORT, THE SCIENTIST IS TO SIGN OFF THE COMPLETED BORROW FILL WORKS FOR EPA REQUIREMENTS FOR CLEAN FILL WORKS.
  - b. BORROW MATERIAL FILLING WORKS IS TO BE SIGNED OFF BY A SUITABLY QUALIFIED INDEPENDENT (NATA REGISTERED COMPANY) GEOTECHNICAL ENGINEER TO BE TYPE B FILL TO MEET BCC SPECIFICATIONS FOR TYPE B FILL
  - THE GEOTECHNICAL ENGINEER IS TO APPROVE THE SOURCE OR SOURCES OF THE BORROW MATERIAL THAT MEETS TYPE B FILL (INCLUDING MINIMUM
  - THE GEOTECHNICAL ENGINEER IS TO CARRY OUT ALL THE TESTING AT THE
  - SITE OR SOURCE(S) AS REQUIRED IN SECTION 204. THE ENGINEER IS TO ENSURE THAT ONLY THE CERTIFIED TYPE B FILL MATERIAL IS USED. TRANSPORTATION DOCKETS ARE TO BE ISSUED FOR EACH TRUCK LOAD. DATE AND TIME OF LOADING AND ARRIVAL ON SITE ARE TO BE
  - RECORDED. • AT THE COMPLETION OF THE FILLING WORKS, THE ENGINEER IS TO SUBMIT A SEPARATE REPORT TO COUNCIL TO VERIFY ALL BORROW MATERIAL FILLING WORKS MEET THE TYPE B SPECIFICATION.
  - IN THE REPORT, THE GEOTECHNICAL ENGINEER IS TO SIGN OFF THE
  - COMPLETED BORROW FILL WORKS THAT MEET TYPE B SPECIFICATIONS. c. PRIOR TO THE COMMENCEMENT OF THE BORROW MATERIAL FILLING, BOTH THE SCIENTIST AND THE GEOTECHNICAL ENGINEER ARE TO INFORM COUNCIL SURVEILLANCE OF THE APPROVED SOURCE OR SOURCES OF BORROW MATERIAL AND SUBMIT TESTING RESULTS VERIFYING THE ACCEPTANCE OF THE MATERIAL.

#### ADDITIONAL GENERAL NOTES

- 23. EARTHWORKS & SEDIMENTATION CONTROL
- a. NO POLLUTED OR SEDIMENT LADEN RUNOFF IS TO BE DISCHARGED DIRECTLY OR INDIRECTLY
- INTO EXISTING DRAINAGE SYSTEM DURING OR AFTER THE WORKS. b. STOCKPILING OF MATERIAL IS TO BE PLACED AS DIRECTED BY THE SUPERINTENDENT.
- 24. ALL LEVELS & SETOUT TO MGA55 AND AHD.
- PRECEDENCE OVER BCC EARTHWORKS REQUIREMENTS. 26. PIPE BEDDING AND BACKFILL TO BE IN ACCORDANCE WITH BCC SPECIFICATION 701A. 27. ABORIGINAL PROTECTION REQUIREMENTS MUST BE ADHERED TO AS PER PLANNING PERMIT

25. AS PART OF THESE WORKS DOUGLAS AND PARTNERS EARTHWORKS SPECIFICATION WILL TAKE

- CONDITIONS 6 AND 7 28. ENVIRONMENTAL MANAGEMENT PLAN MUST BE SUBMITTED AND APPROVED AS PER
- PLANNING PERMIT CONDITION 5
- 29. ADHERE TO PLANNING PERMIT CONDITIONS 12 & 13
- 30. OBTAIN APPROVAL FOR CONSTRUCTION VEHICLE ACCESS AS PER PLANNING PERMIT CONDITION 44



- Note for Contractors
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15006 CJA 7D1

RIVER VALLEY - STAGE 7D1 YOURLAND

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NOTES PAGE

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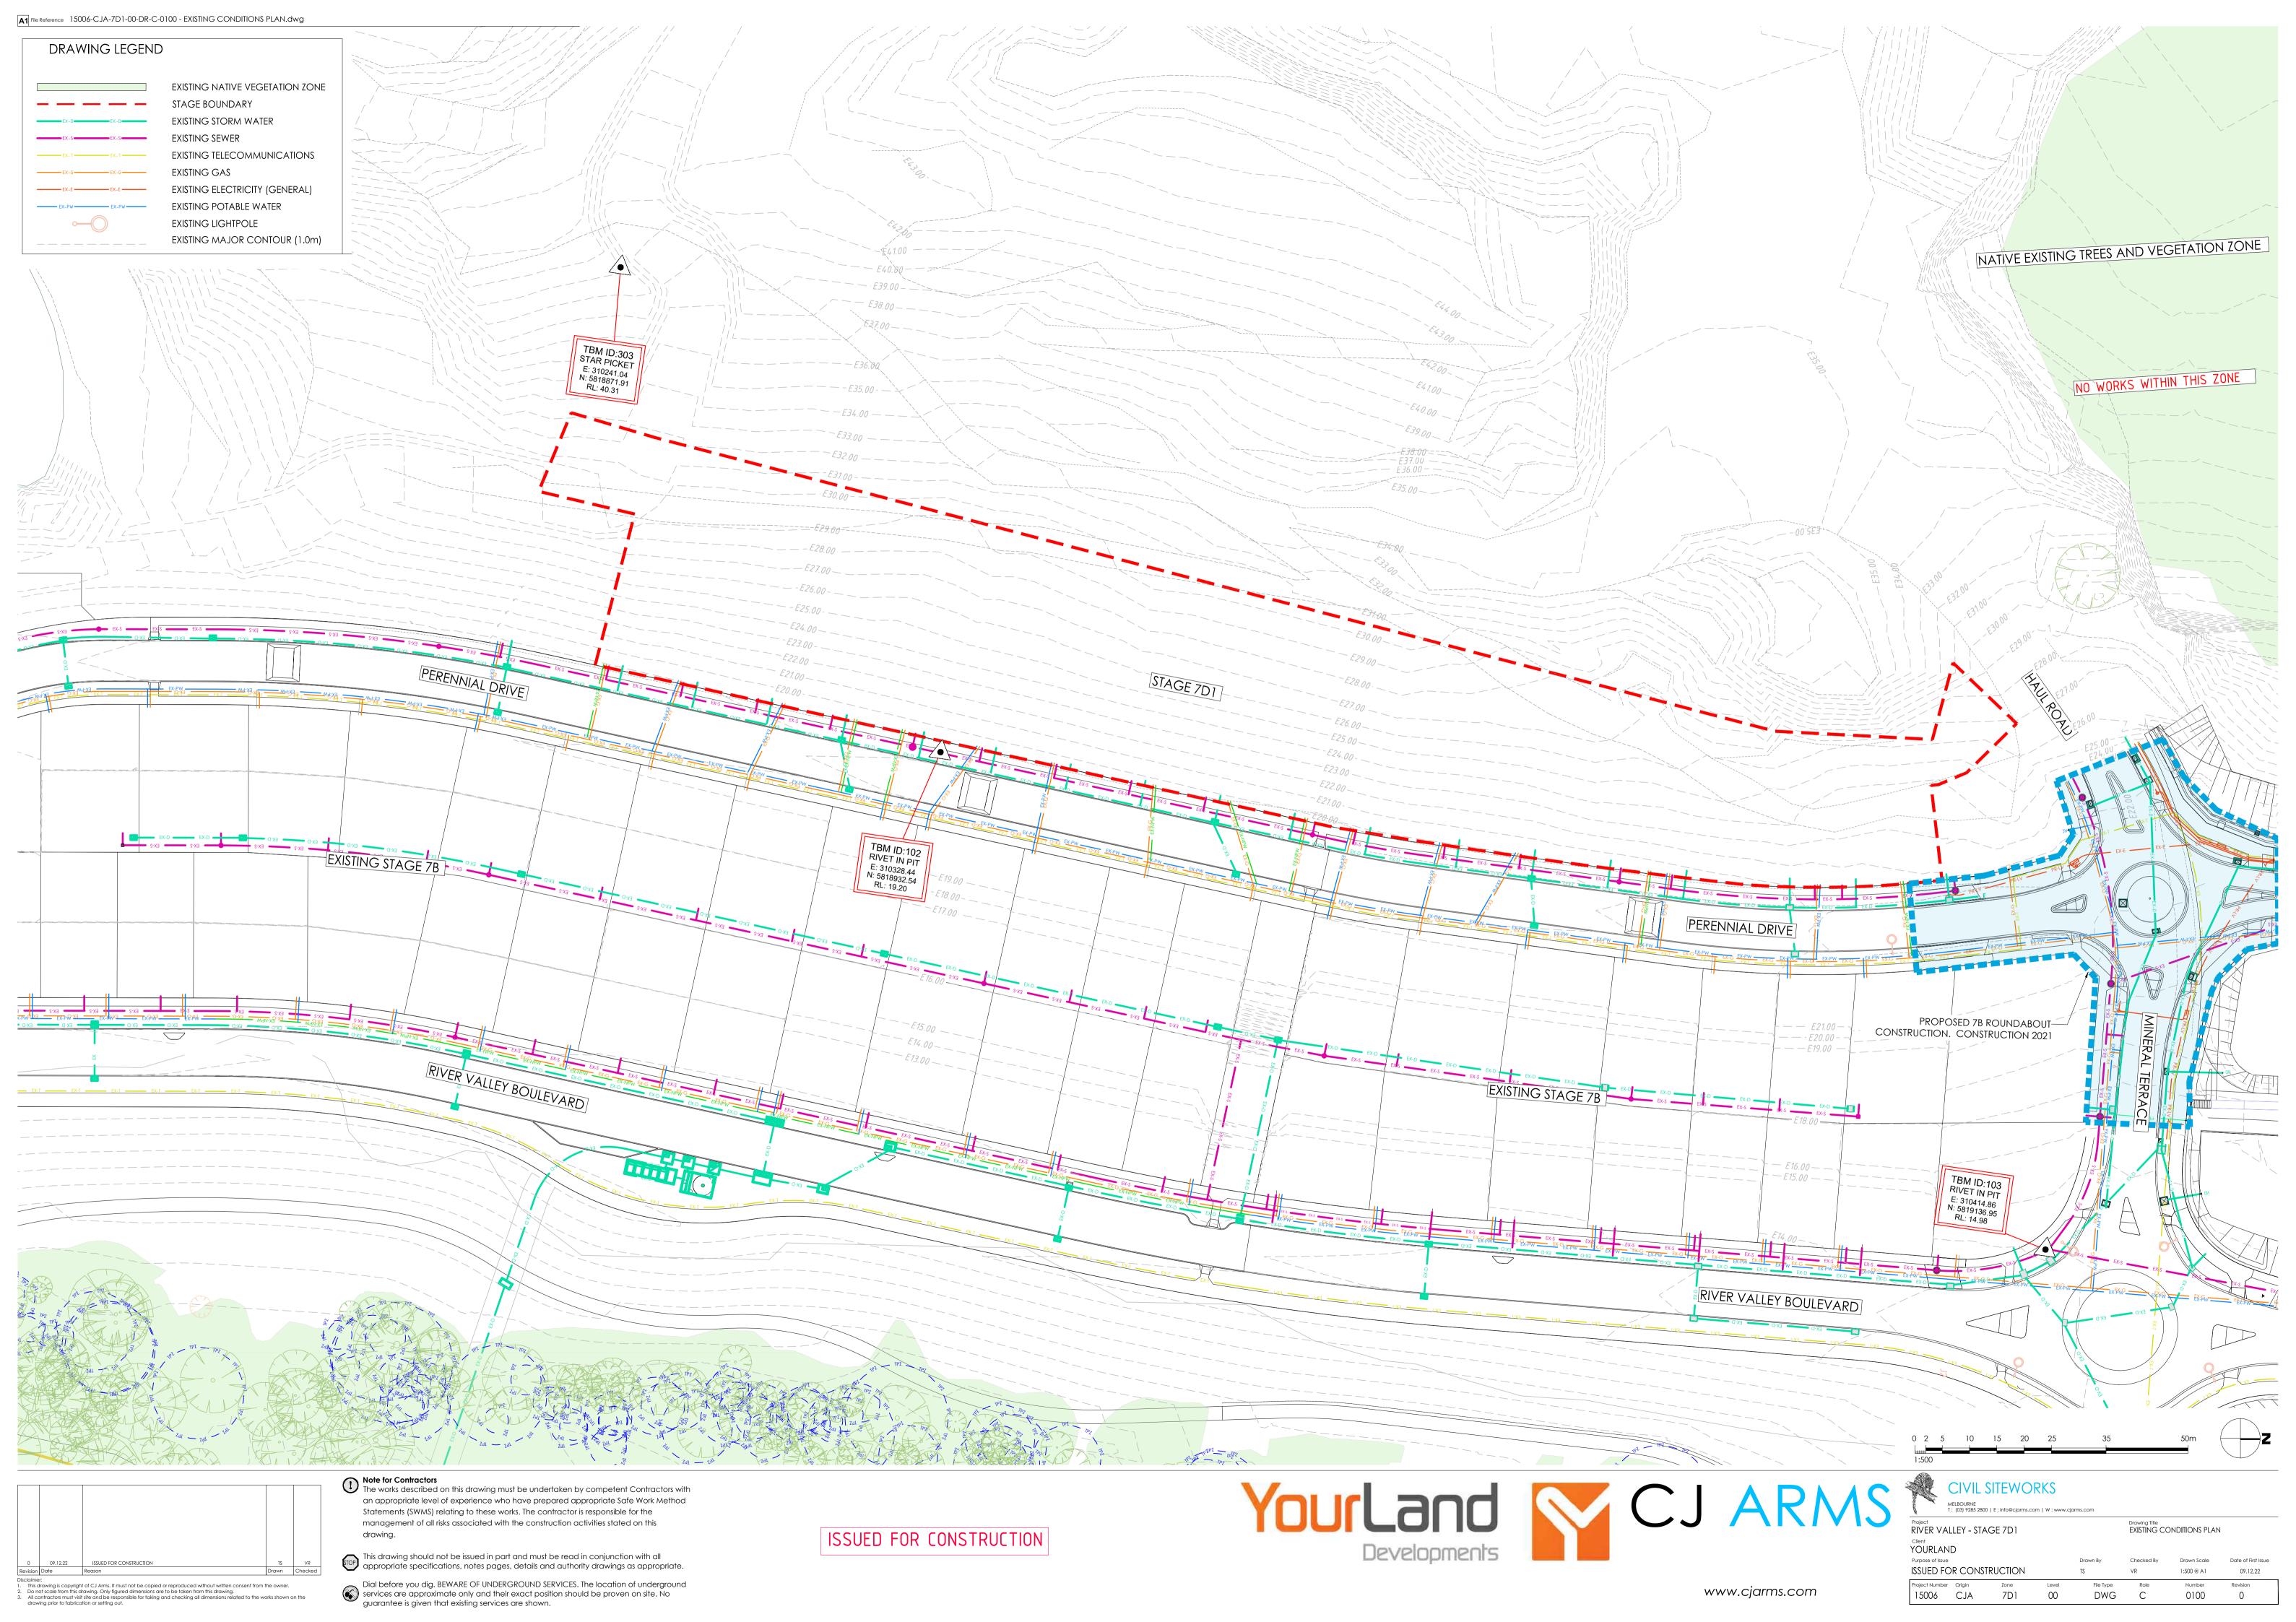
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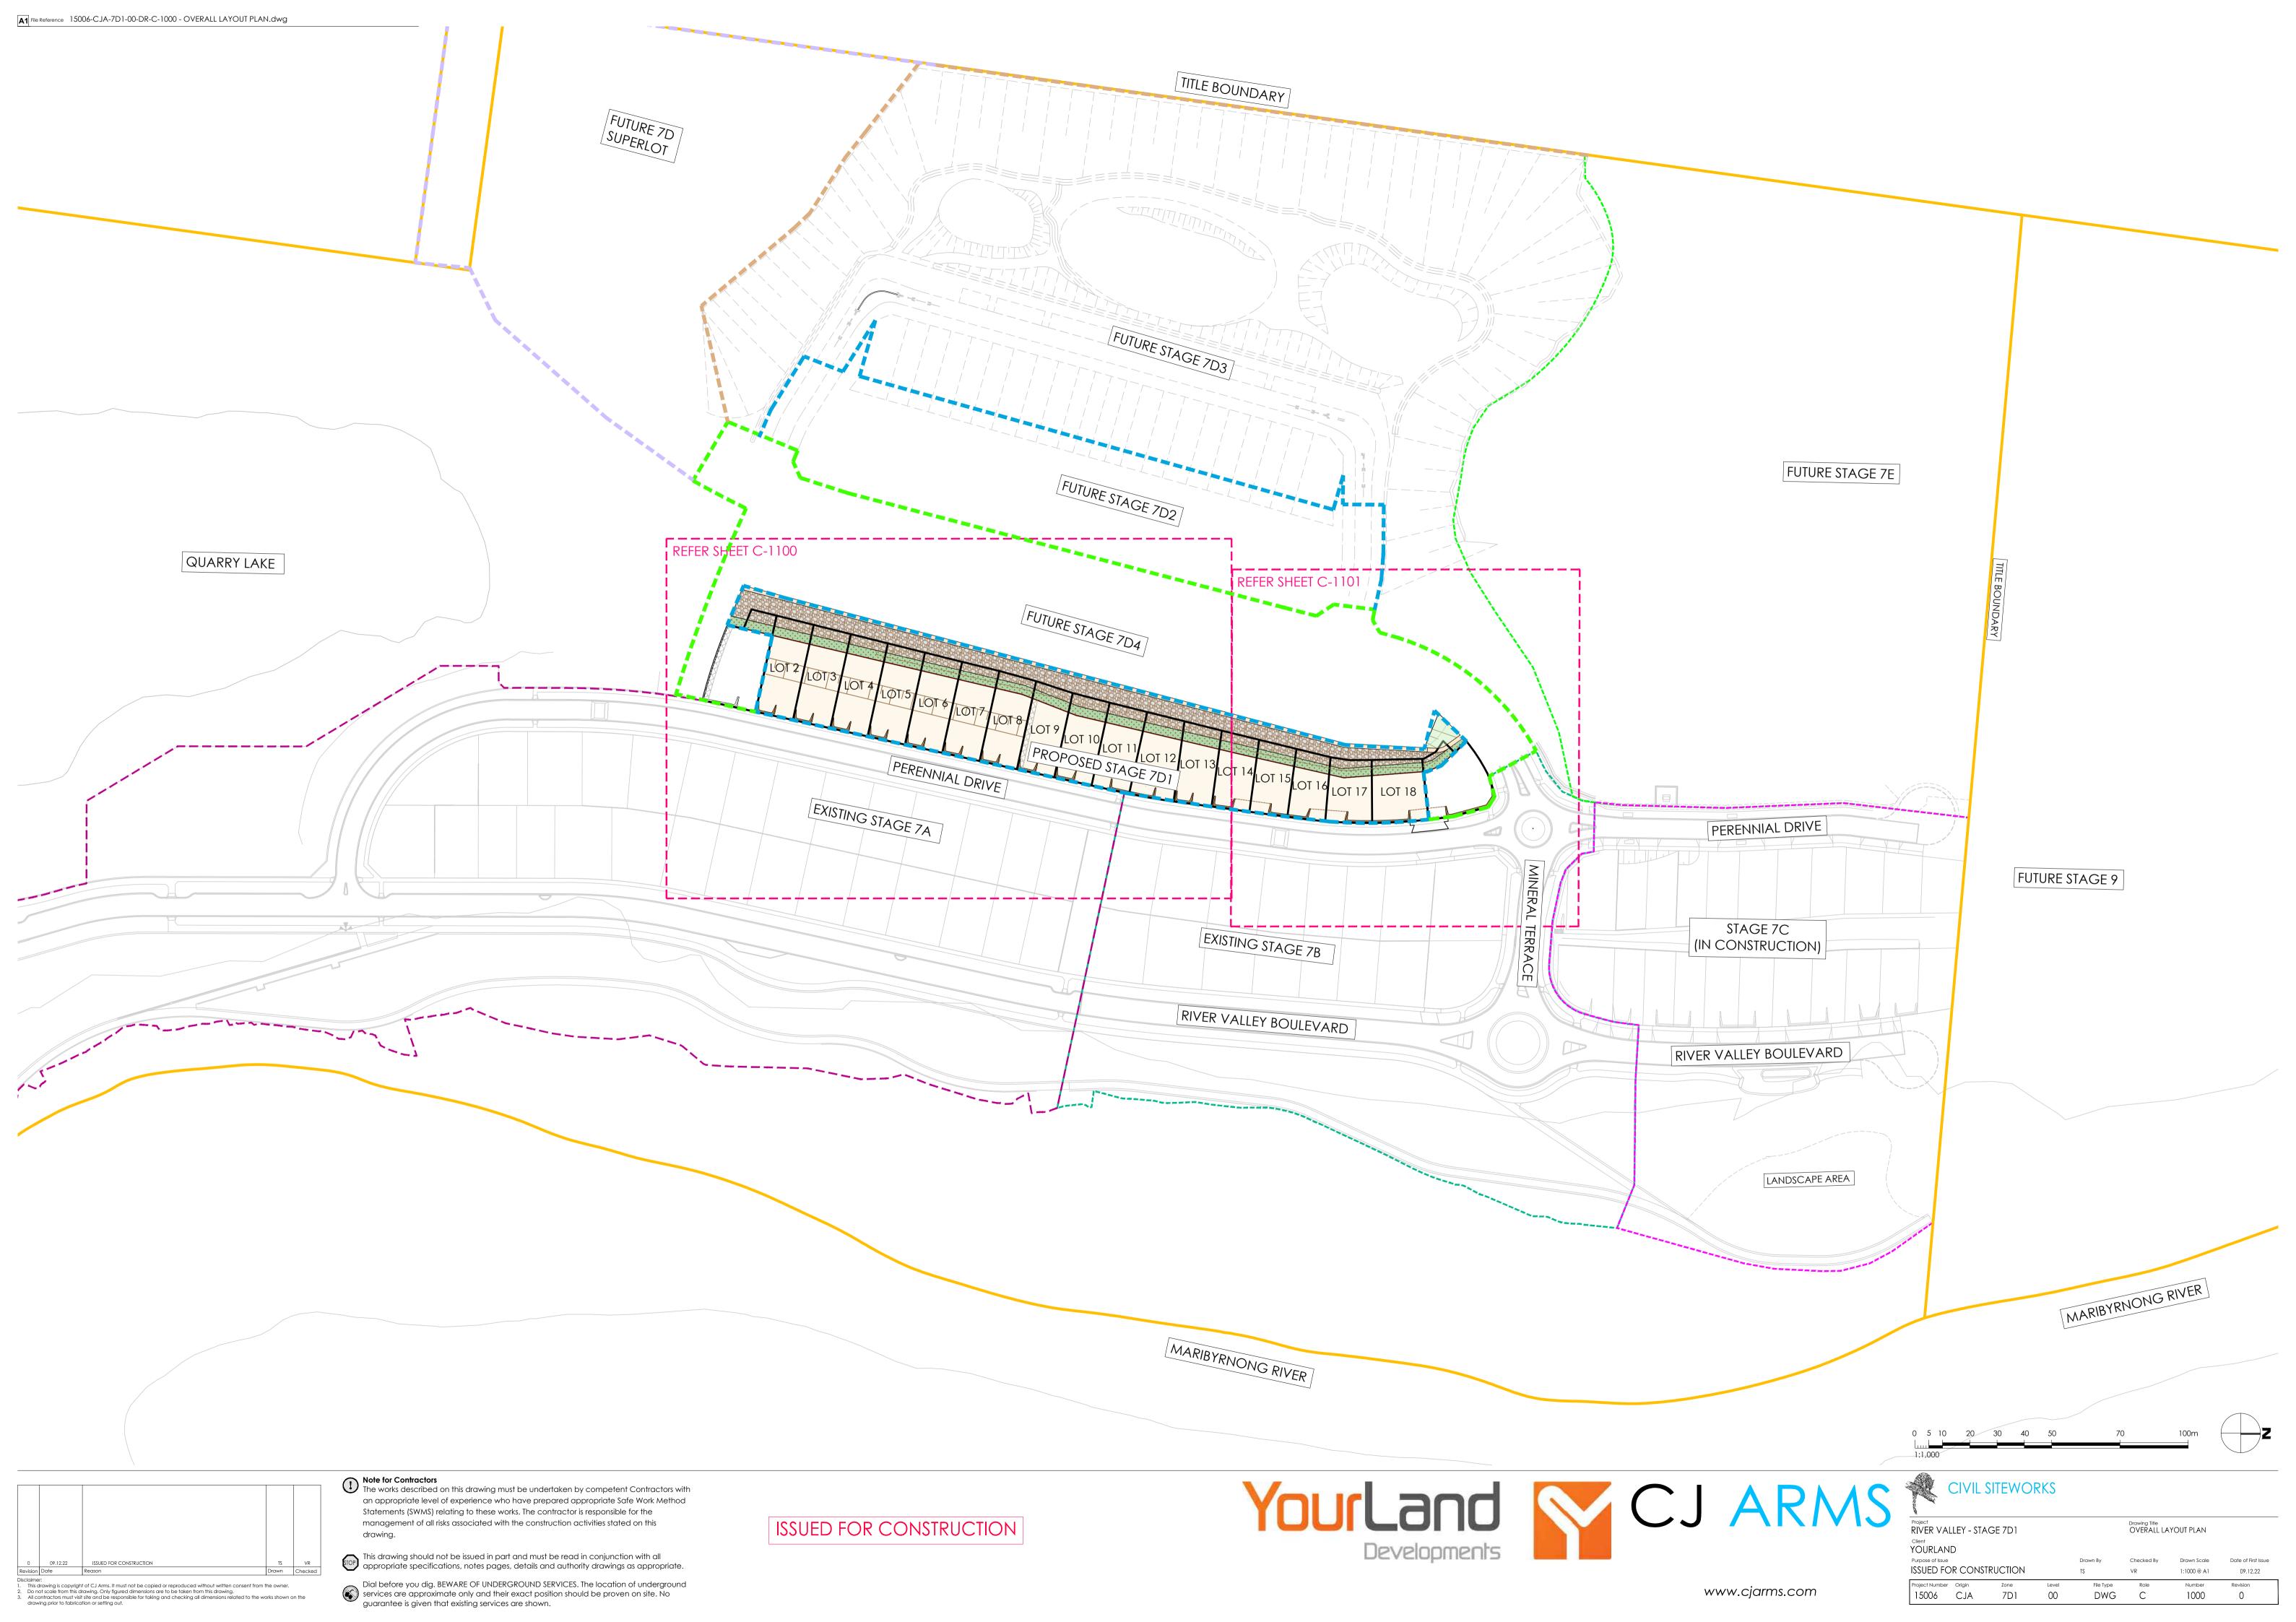
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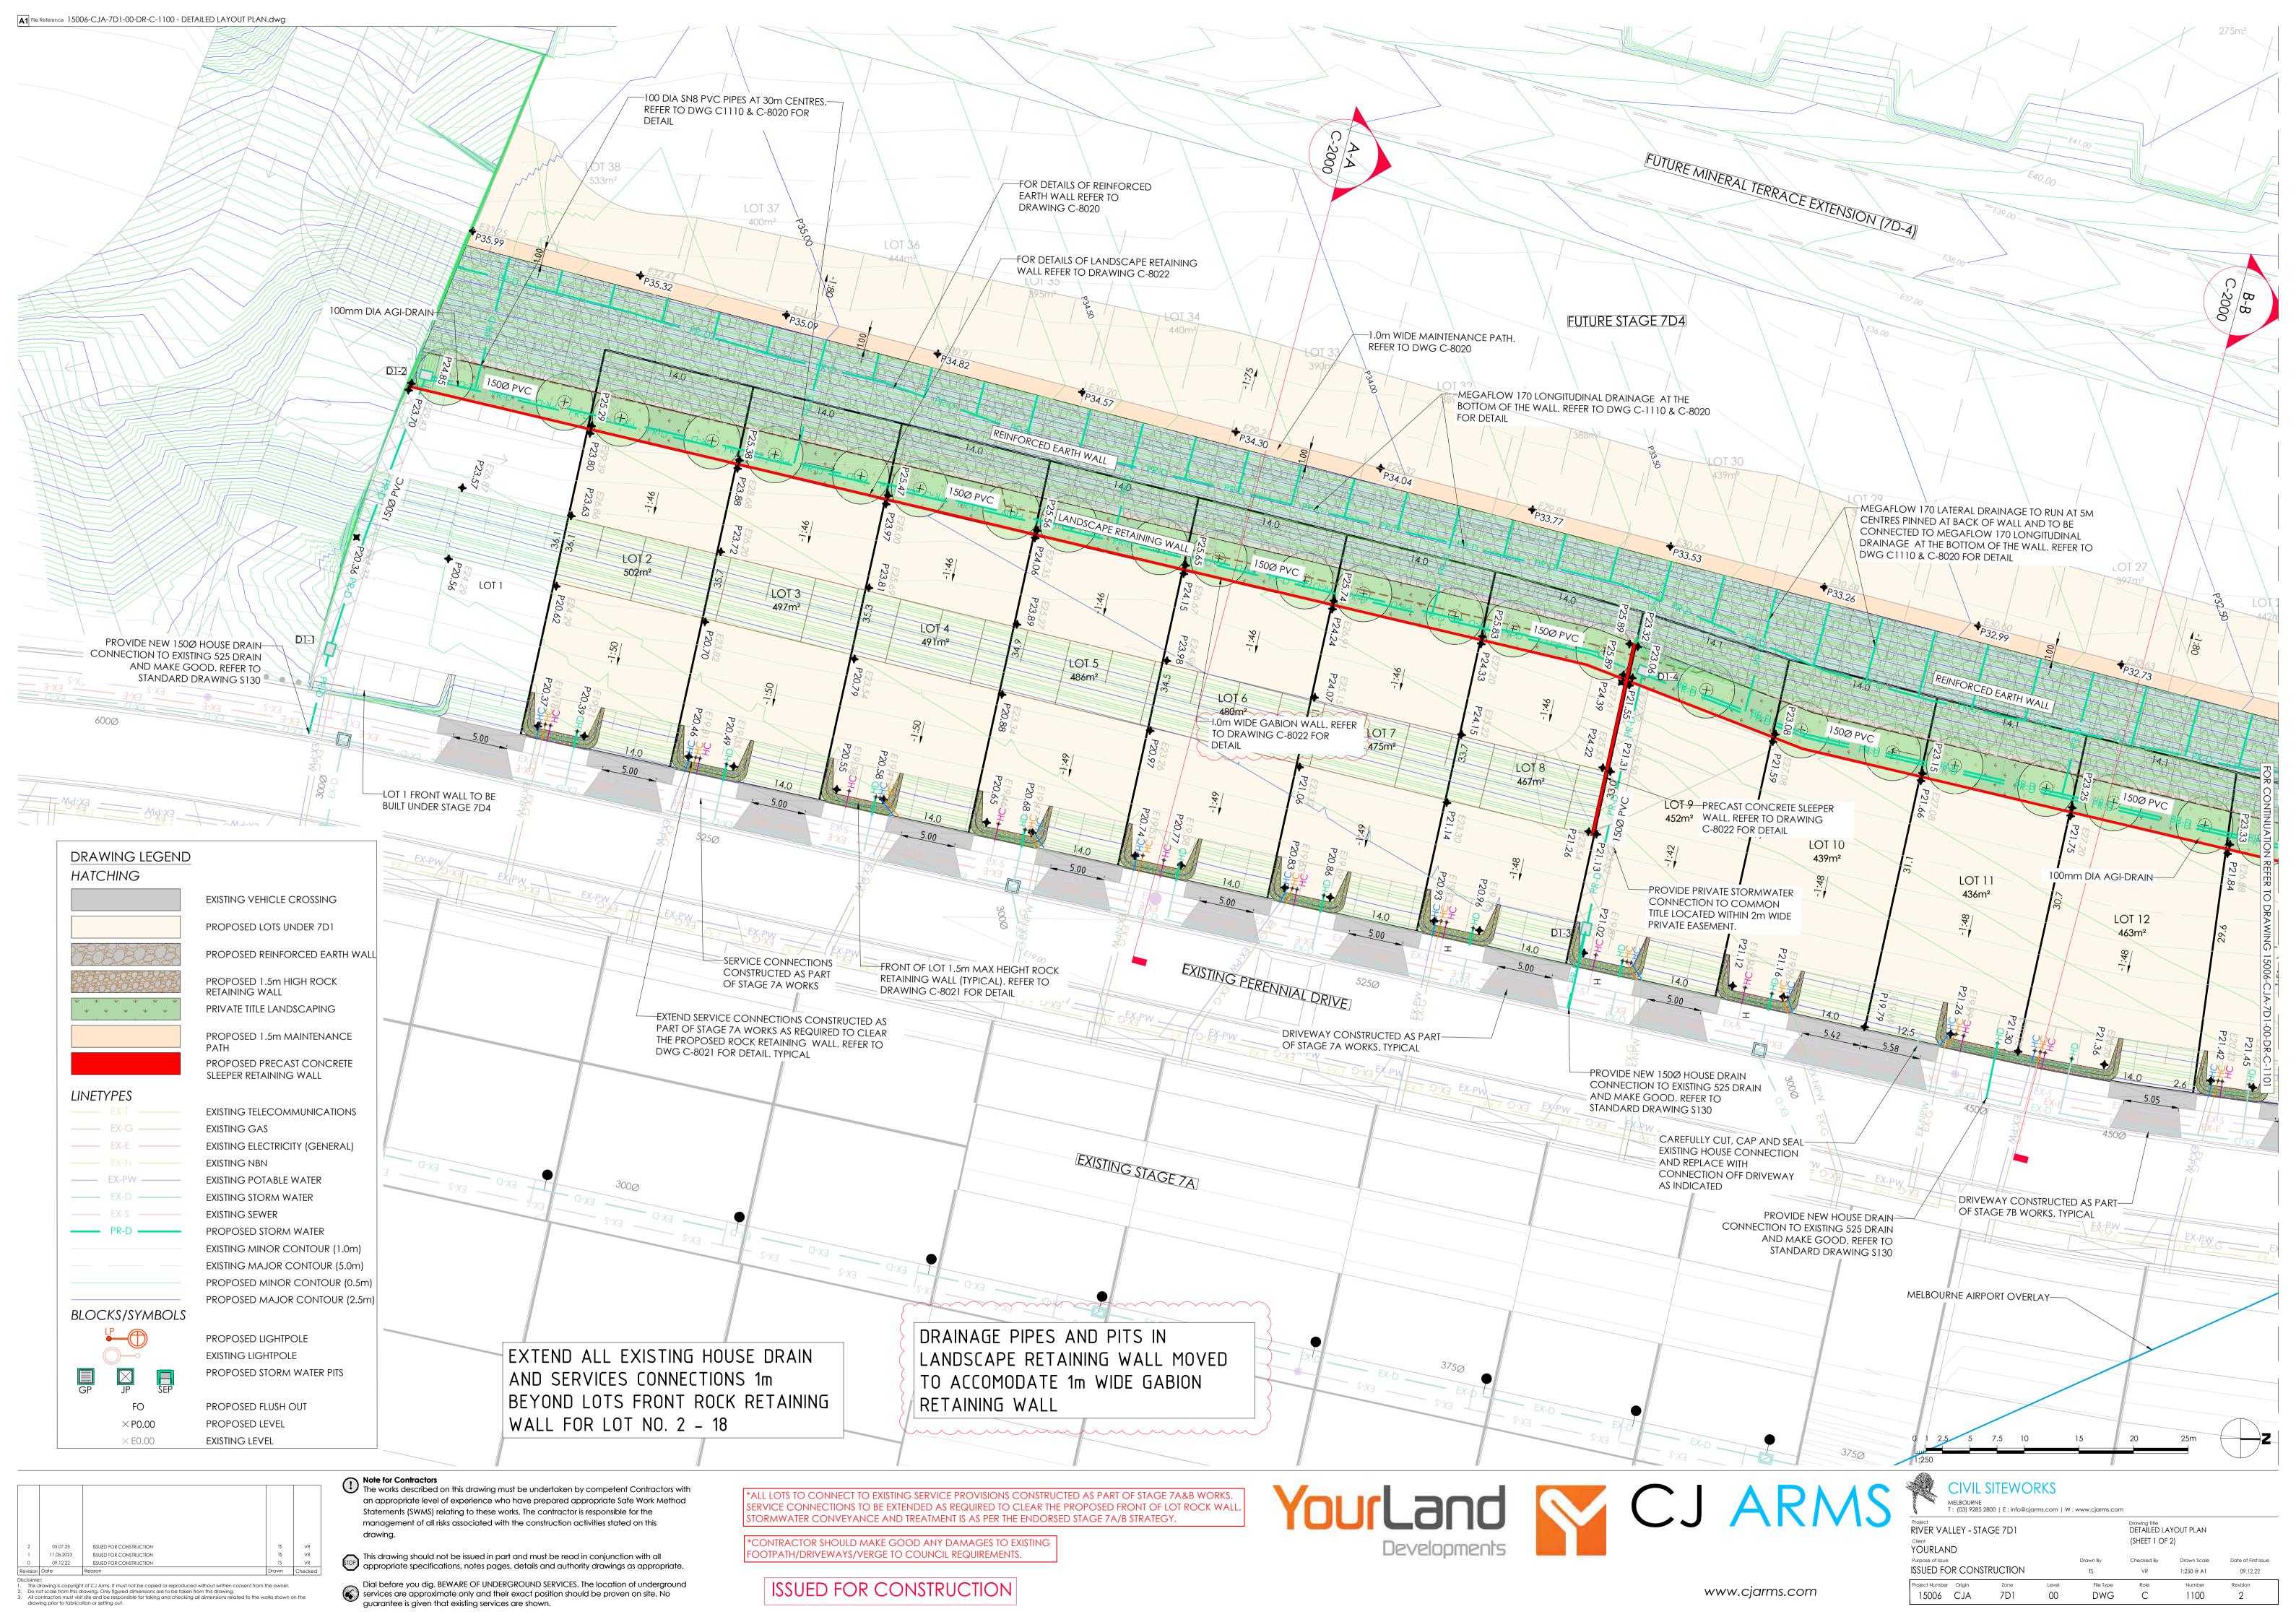
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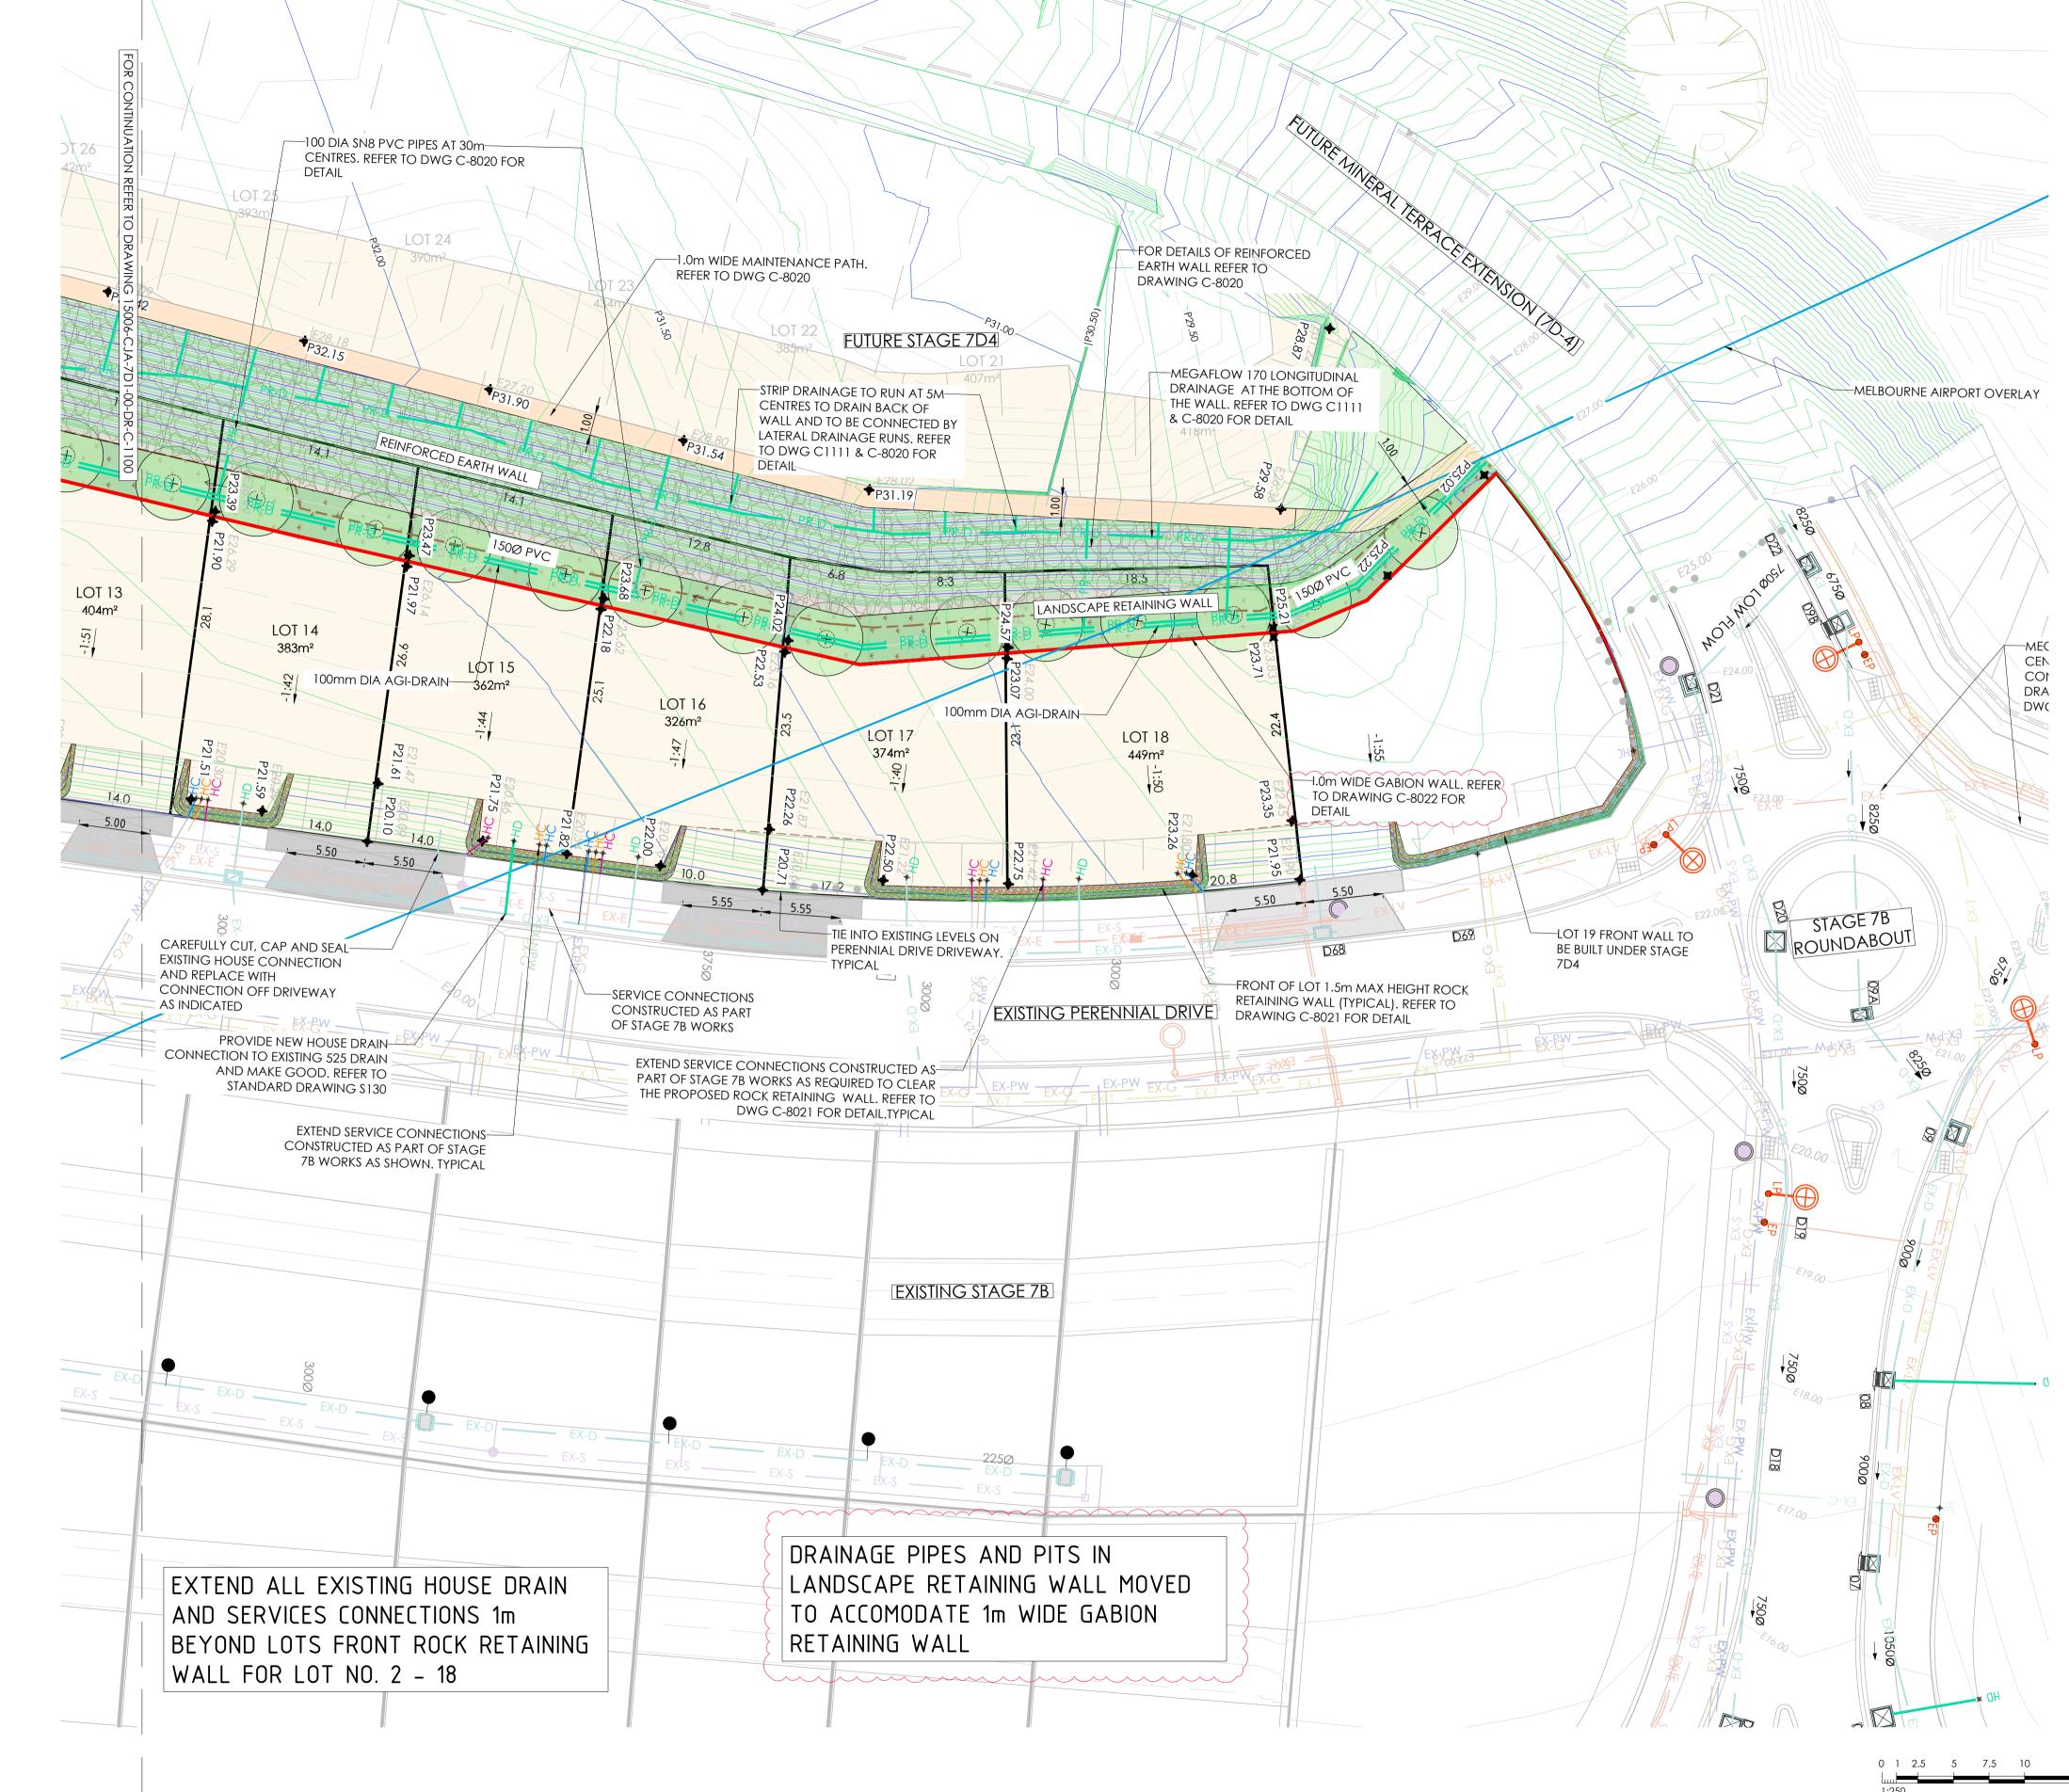
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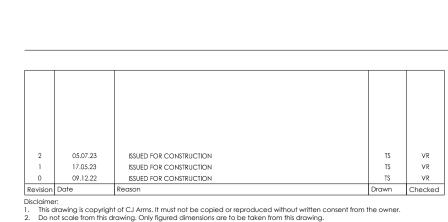
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DRAWING LEGEND

PROPOSED LOTS UNDER 7D1

PROPOSED 1.5m HIGH ROCK

PRIVATE TITLE LANDSCAPING

PROPOSED 1.5m MAINTENANCE

PROPOSED PRECAST CONCRETE

EXISTING TELECOMMUNICATIONS

EXISTING ELECTRICITY (GENERAL)

SLEEPER RETAINING WALL

EXISTING POTABLE WATER EXISTING STORM WATER

PROPOSED STORM WATER

PROPOSED LIGHTPOLE

PROPOSED STORM WATER PITS

EXISTING LIGHTPOLE

PROPOSED FLUSH OUT

PROPOSED LEVEL

EXISTING LEVEL

EXISTING MINOR CONTOUR (1.0m) EXISTING MAJOR CONTOUR (5.0m) PROPOSED MINOR CONTOUR (0.5m) PROPOSED MAJOR CONTOUR (2.5m)

RETAINING WALL

EXISTING GAS

EXISTING NBN

EXISTING SEWER

PROPOSED REINFORCED EARTH WALL

HATCHING

LINETYPES

BLOCKS/SYMBOLS

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>
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Dial before you dig. BEWARE OF UNDERGROUND SERVICES. The location of underground services are approximate only and their exact position should be proven on site. No guarantee is given that existing services are shown.

SERVICE CONNECTIONS TO BE EXTENDED AS REQUIRED TO CLEAR THE PROPOSED FRONT OF LOT ROCK WALL. TORMWATER CONVEYANCE AND TREATMENT IS AS PER THE ENDORSED STAGE 7A/B STRATEGY.

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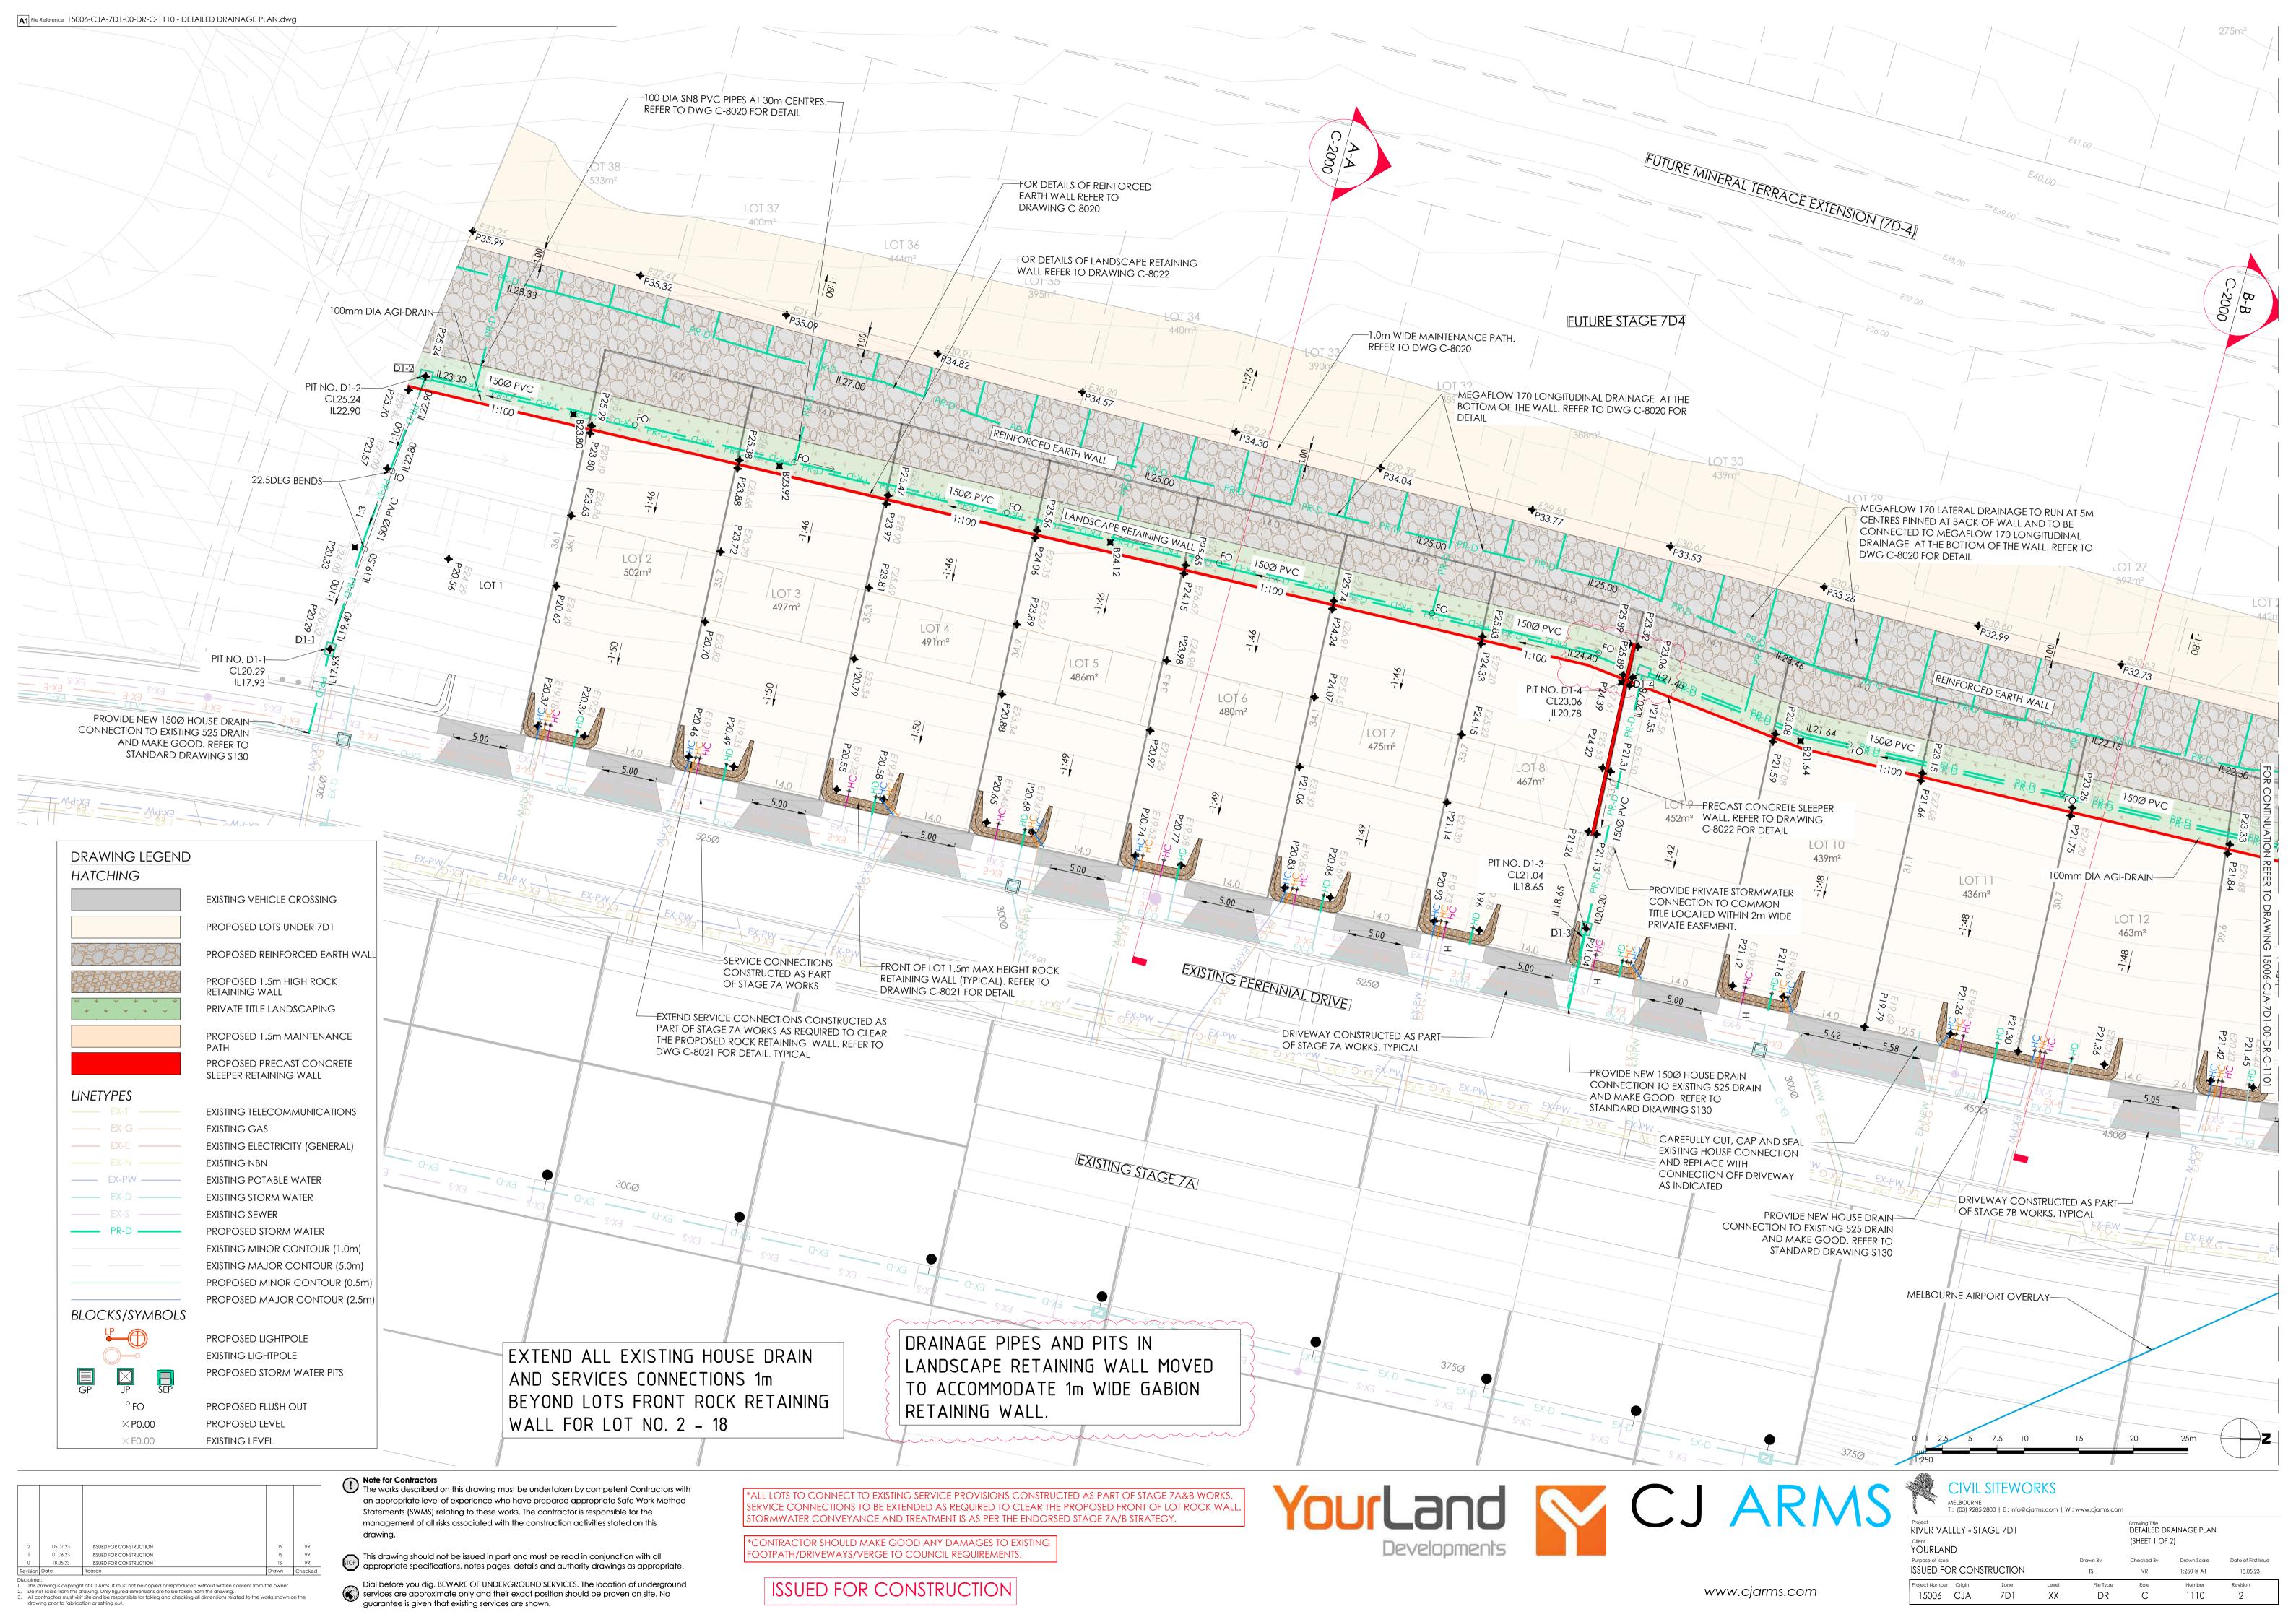
\*CONTRACTOR SHOULD MAKE GOOD ANY DAMAGES TO EXISTING OOTPATH/DRIVEWAYS/VERGE TO COUNCIL REQUIREMENTS.









Project RIVER VALLEY - STAGE 7D1 Drawing Title
DETAILED LAYOUT PLAN SHEET 2 OF 2 ISSUED FOR CONSTRUCTION 15006 CJA 7D1 00 DWG 1101 D



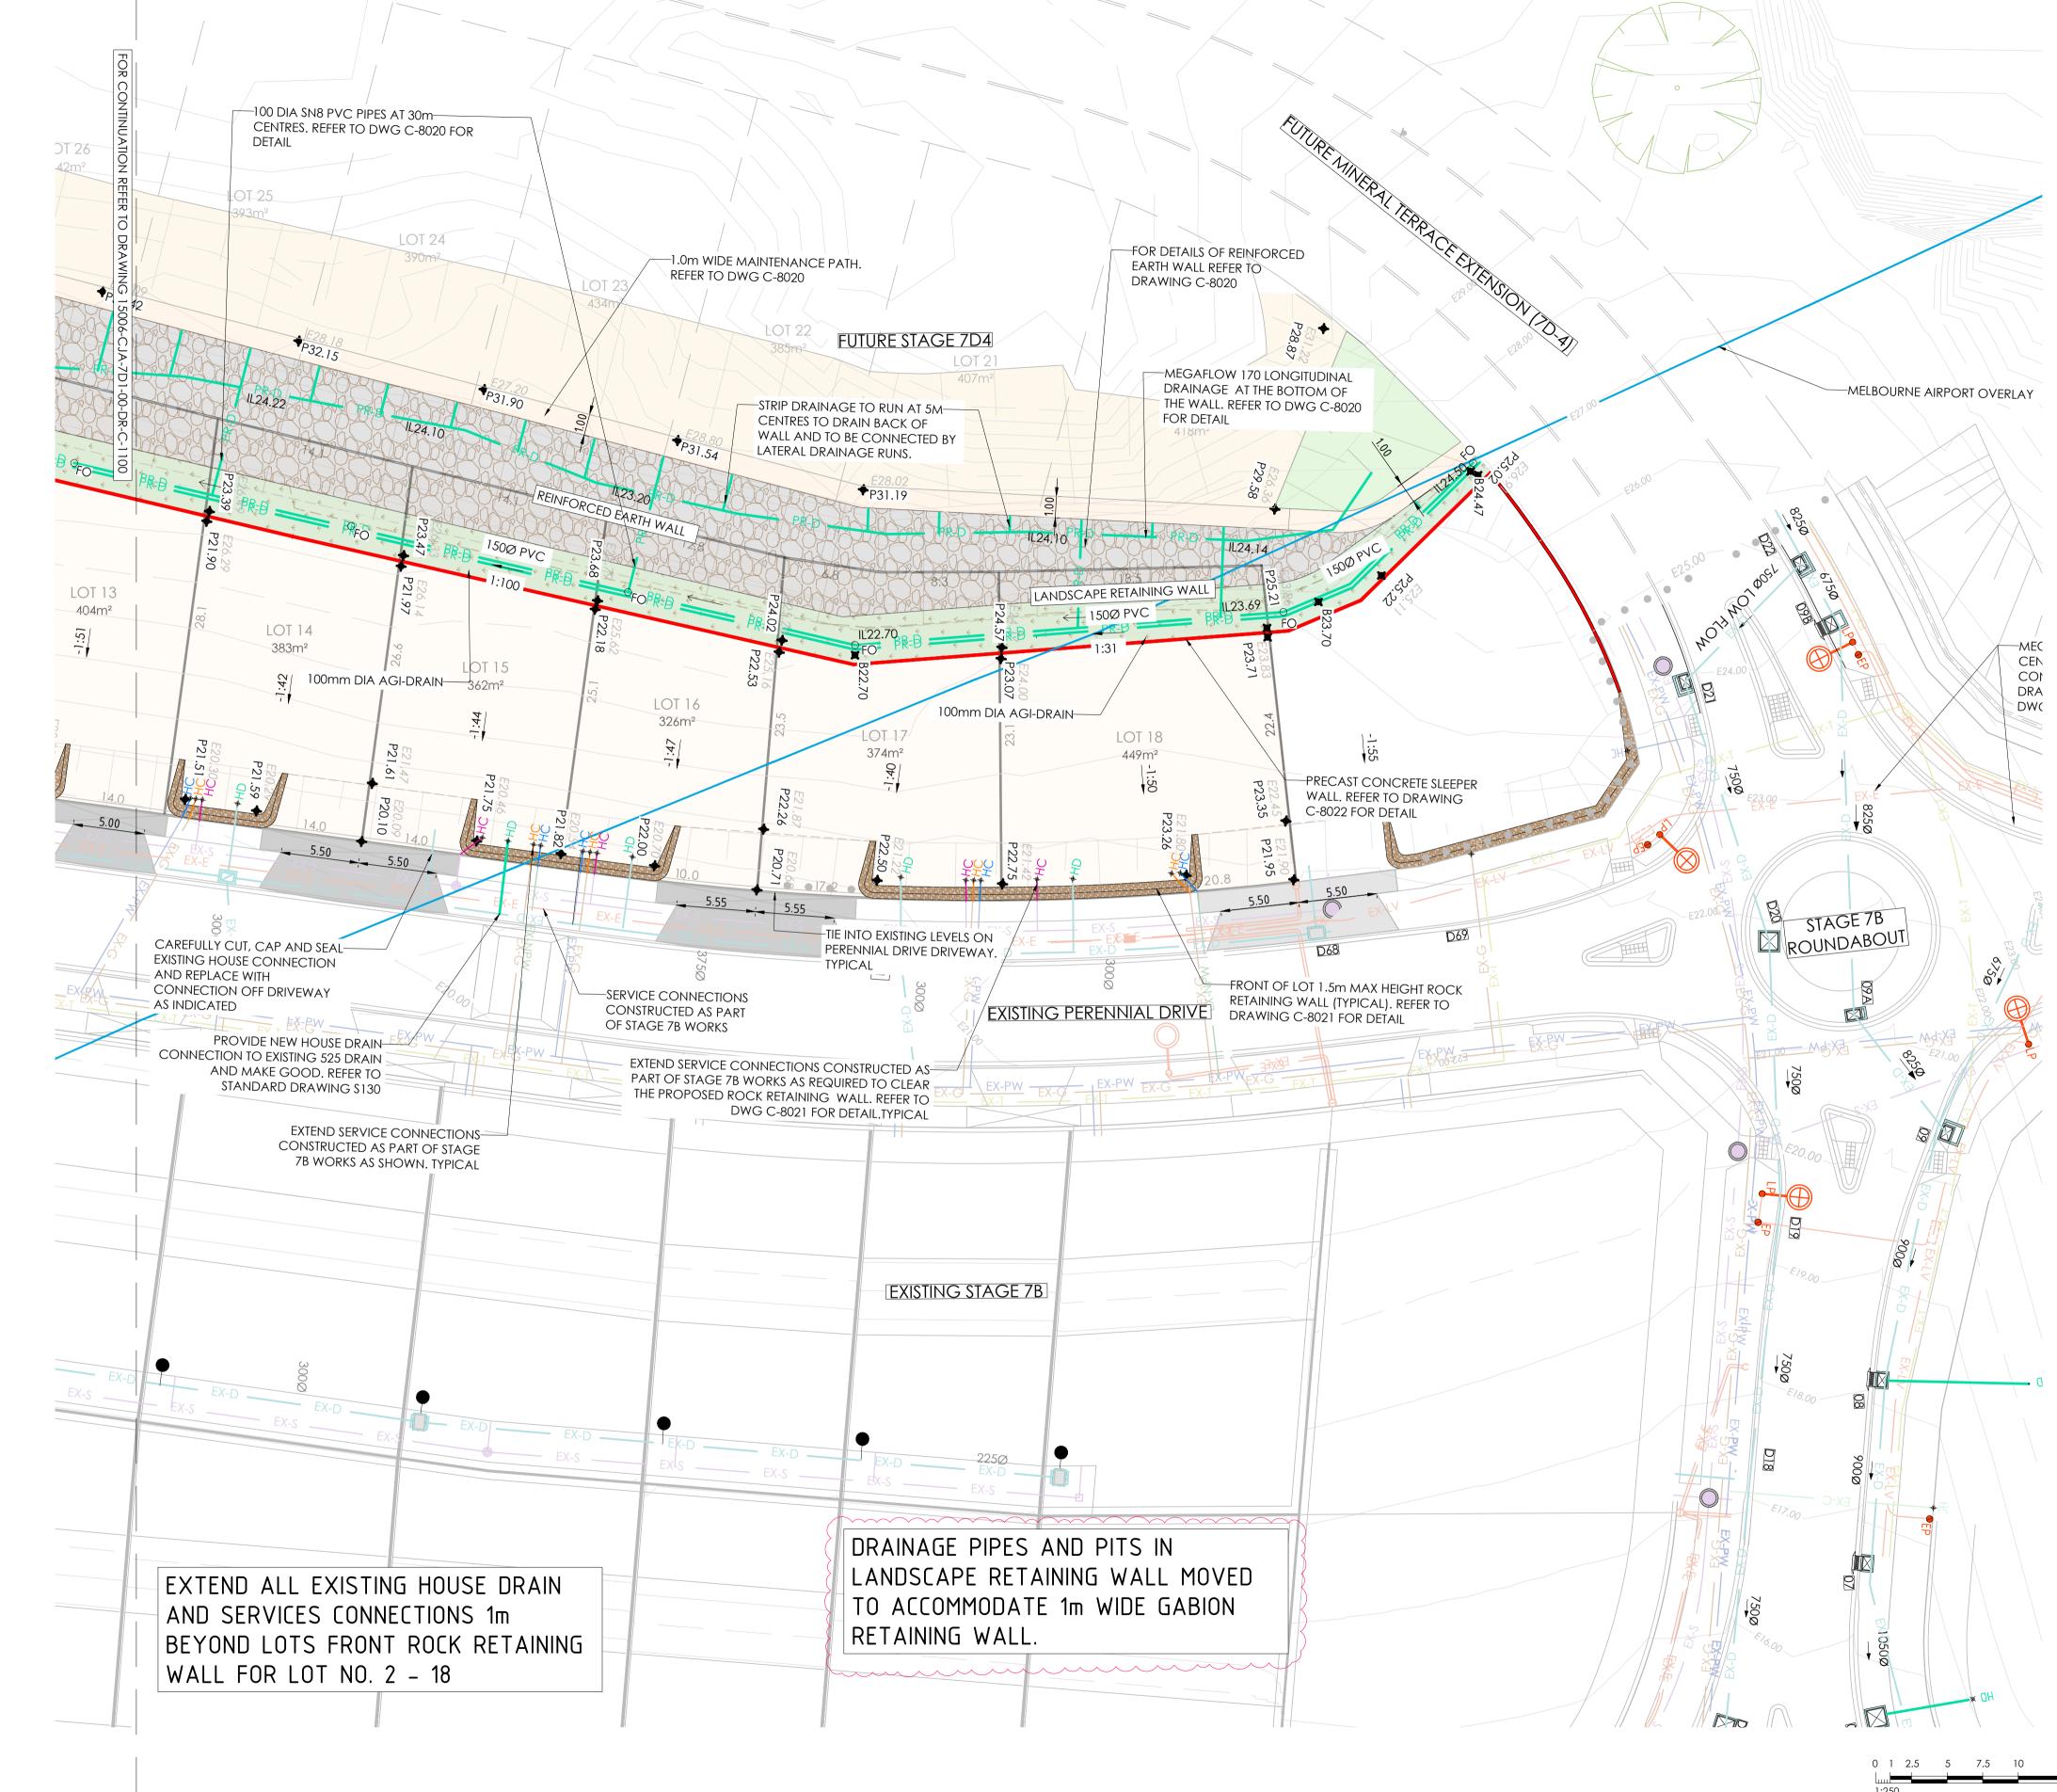

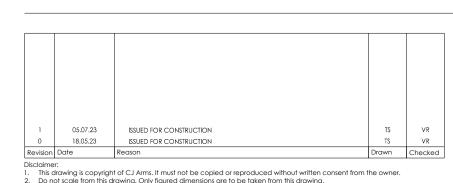

DRAWING LEGEND

PROPOSED LOTS UNDER 7D1

PROPOSED 1.5m HIGH ROCK

PRIVATE TITLE LANDSCAPING

PROPOSED 1.5m MAINTENANCE

PROPOSED PRECAST CONCRETE

EXISTING TELECOMMUNICATIONS

EXISTING ELECTRICITY (GENERAL)

SLEEPER RETAINING WALL

EXISTING POTABLE WATER EXISTING STORM WATER

PROPOSED STORM WATER

PROPOSED LIGHTPOLE

PROPOSED STORM WATER PITS

EXISTING LIGHTPOLE

PROPOSED FLUSH OUT

PROPOSED LEVEL

EXISTING LEVEL

EXISTING MINOR CONTOUR (1.0m) EXISTING MAJOR CONTOUR (5.0m) PROPOSED MINOR CONTOUR (0.5m) PROPOSED MAJOR CONTOUR (2.5m)

RETAINING WALL

EXISTING GAS

EXISTING NBN

EXISTING SEWER

PROPOSED REINFORCED EARTH WALL

HATCHING

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Project RIVER VALLEY - STAGE 7D1 Drawing Title
DETAILED DRAINAGE PLAN SHEET 2 OF 2 YOURLAND ISSUED FOR CONSTRUCTION

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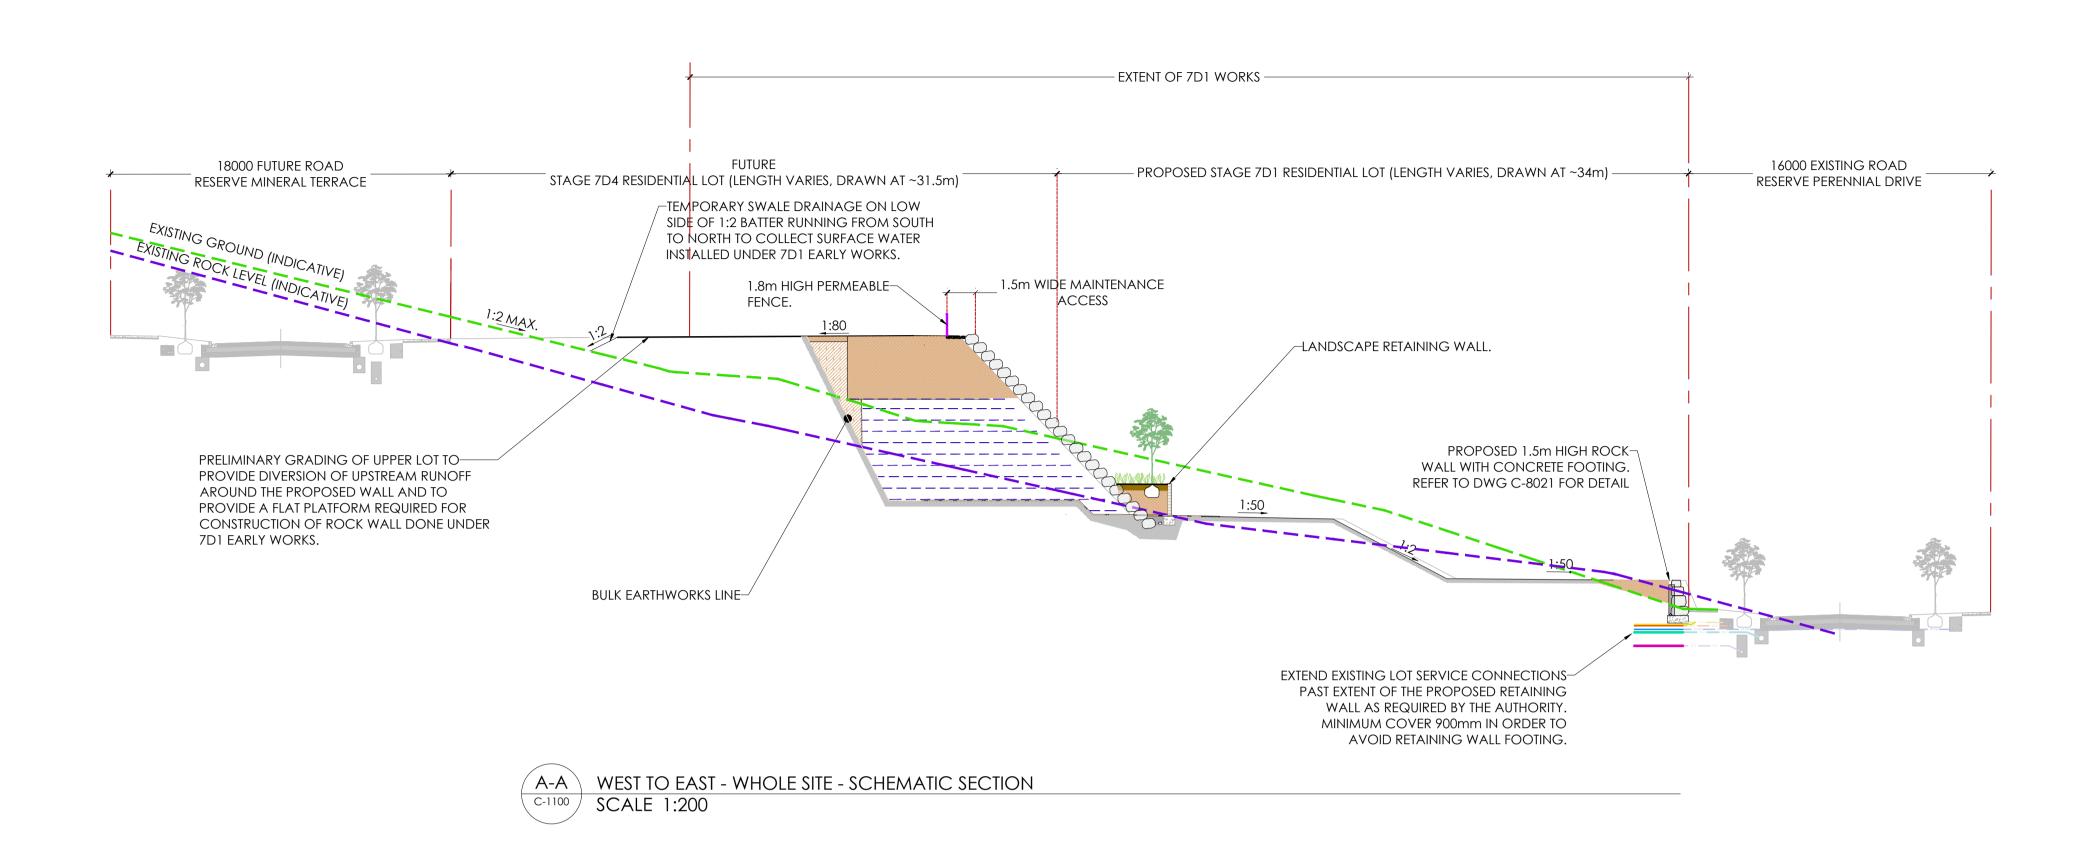
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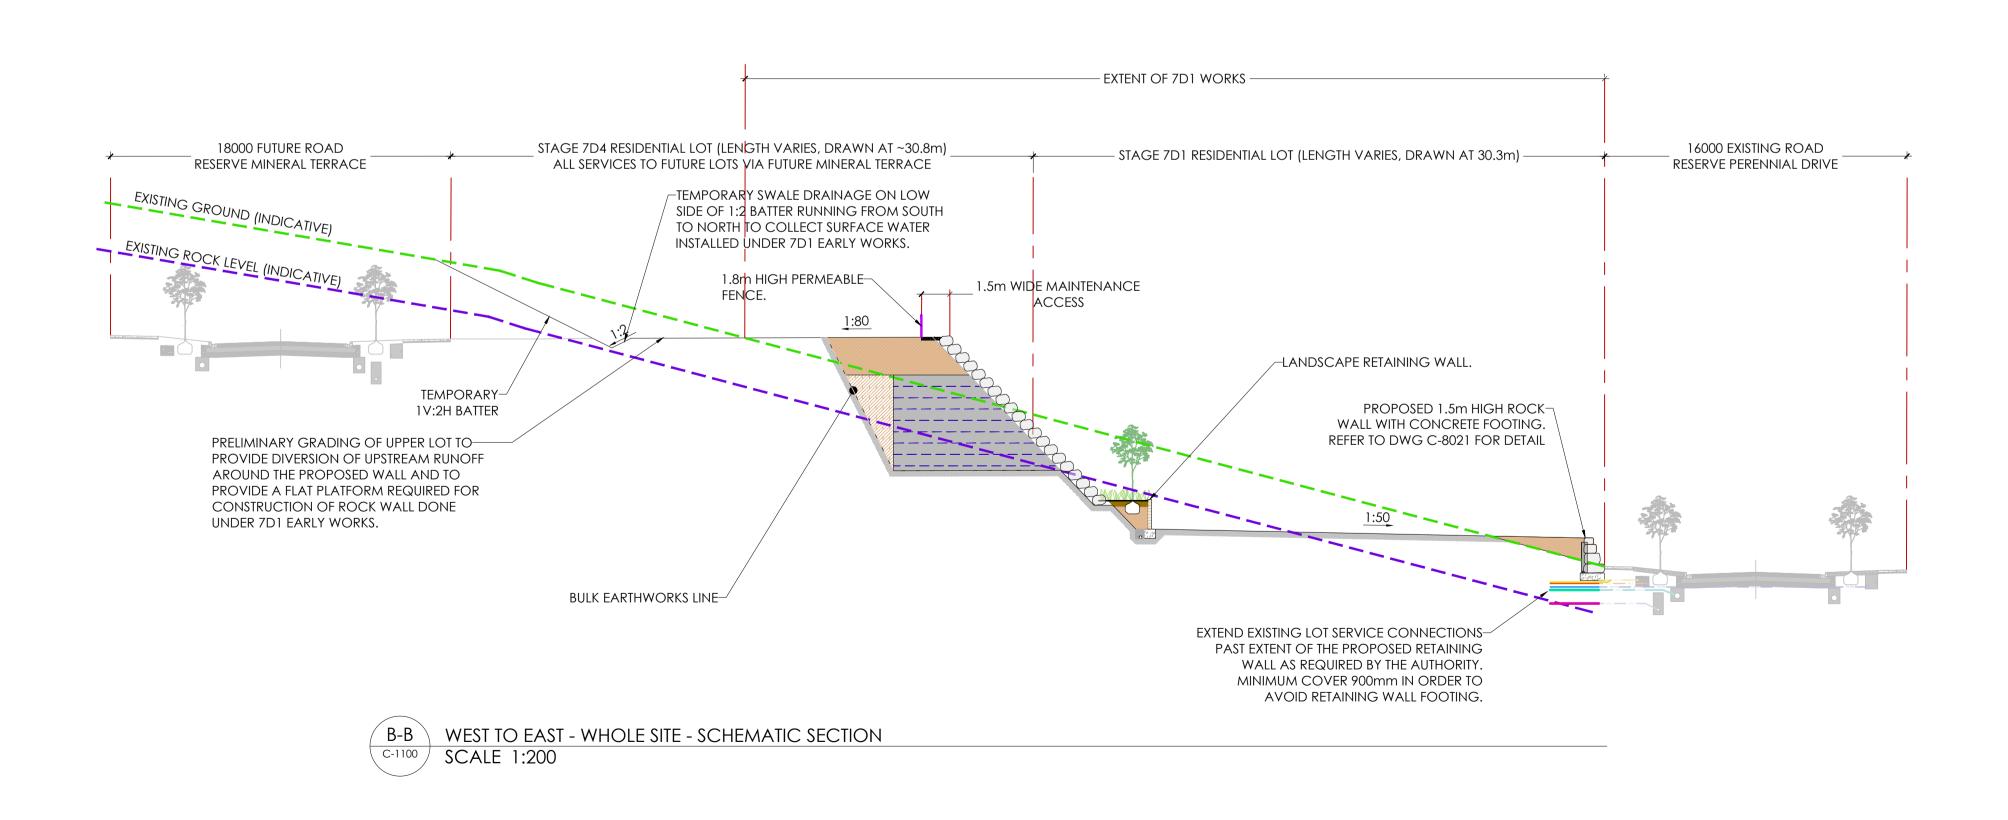
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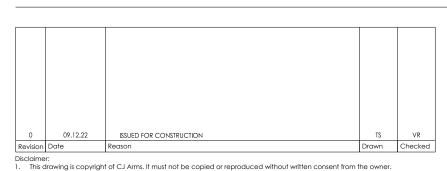
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OOTPATH/DRIVEWAYS/VERGE TO COUNCIL REQUIREMENTS.

\*CONTRACTOR SHOULD MAKE GOOD ANY DAMAGES TO EXISTING







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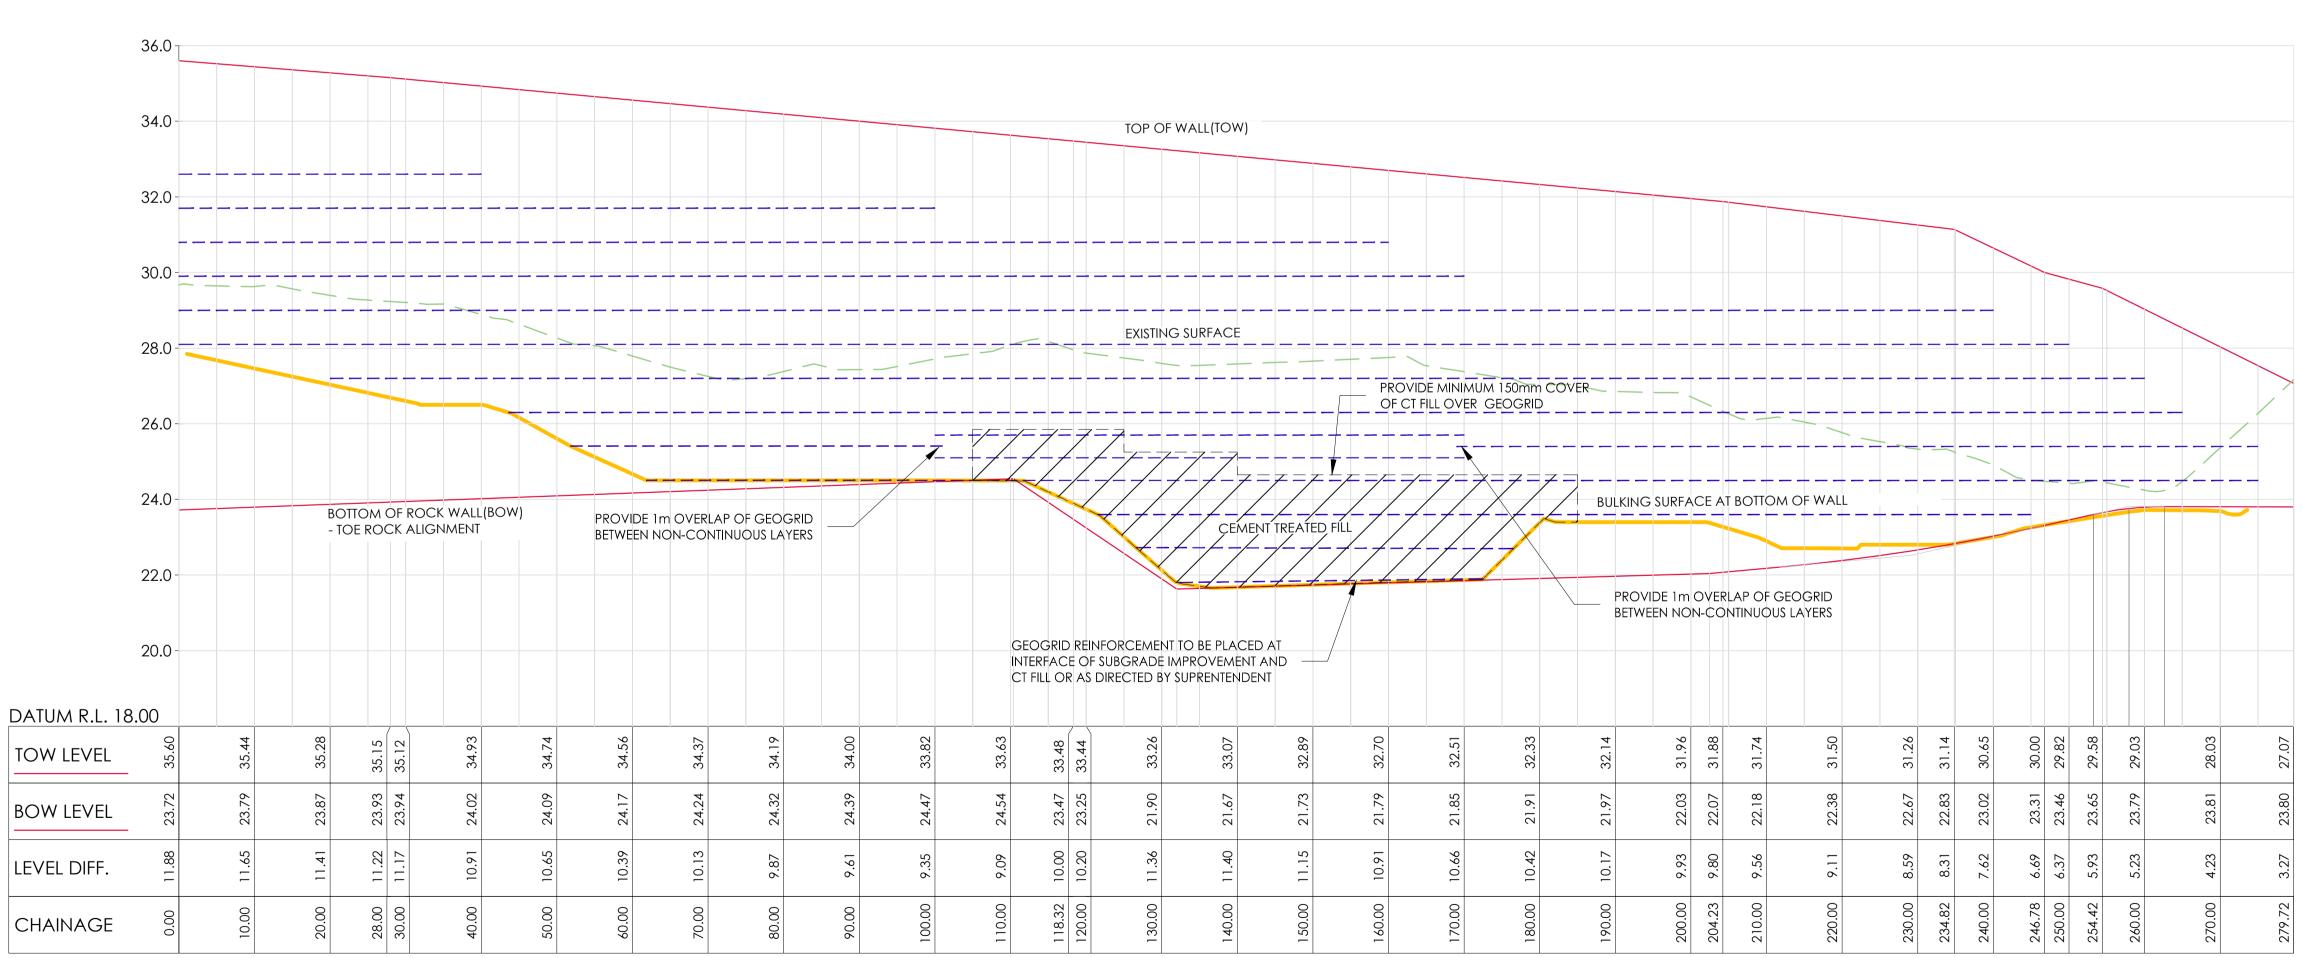
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T: (03) 9285 2800 | E:info@cjarms.com | W:www.cjarms.com Project RIVER VALLEY - STAGE 7D1 TYPICAL SECTION - WHOLE SITE YOURLAND ISSUED FOR CONSTRUCTION 1:200 @ A1 09.12.22 15006 CJA 7D1 00 DWG 2000



FER TO DWG C-4001 FOR GEOSYNTHETIC REINFORCEMENT TABLE

GEOGRID REINFORCEMENT UPDATED

LOWER LOTS - BOTTOM OF ROCK WALL A - LONG SECTION SCALES: HORIZONAL 1:500 VERTICAL 1:100 (5x)

31.05.23 ISSUED FOR CONSTRUCTION 15.05.23 ISSUED FOR CONSTRUCTION 09.12.22 ISSUED FOR CONSTRUCTION sciaimer:
This drawing is copyright of CJ Arms. It must not be copied or reproduced without written consent from the owner.
Do not scale from this drawing. Only figured dimensions are to be taken from this drawing.

All contractors must visit site and be responsible for taking and checking all dimensions related to the works shown on the

drawing prior to fabrication or setting out.

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THE INFORMATION CONTAINED ON THIS PLAN IS A REPRESENTATION OF THE DESIGN PREPARED BY DOUGLAS PARTNERS. REFER TO: DOUGLAS PARTNERS REPORT #95572.01\_R001 FOR DESIGN AND CERTIFICATION OF THE

DOUGLAS PARTNERS REPORT #95572.01\_R002 FOR CONSTRUCTION SPECIFICATION. ANY DISCREPANCIES BETWEEN THE DESIGN DRAWINGS AND THE DOUGLAS PARTNERS

REQUIREMENTS SHALL BE REFERRED TO THE SUPERINTENDENT. ISSUED FOR CONSTRUCTION





Drawing Title
LONGSECTION - ROCKWALL A RIVER VALLEY - STAGE 7D1 YOURLAND Purpose of Issue

ISSUED FOR CONSTRUCTION VR 1:500@ A1 09.12.22 15006 CJA 7D1 DWG 4000

River Valley St																																		
River valley St	age 7D																																	
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Extrapolated Geo	synthetic r	einforcem	ent for Lo	ower Lots	s - 600 to	900mm ge	eosynthe	tic reinfor	rcement in	iterval																								
Platform heigh	t 35.3	35.2	35	34.85	34.7	34.5	34.3	34.1	33.9	33.7	33.5	33.5	33.35	33.25	33.15	33.0	32.8	32.6	32.4	32.4	32.25	32.25	32.05	31.85	31.6	31.35	31.15	31.1	31.1					
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28.1 0.9	6.3	6.3	6.3	6.3	5.8	6.7	6.7	7.6	7.6	7.6	6.3	6.3	5.8	5.8	5.8	5.8	5.8	5.8	4.9	4.9	4.9	4.9	4.9	4	4	4	4	4	4	4				1
27.2 0.9			6.3	6.3	6.3	6.7	6.7	7.6	7.6	7.6	6.3	6.3	5.8	5.8	5.8	5.8	5.8	5.8	5.8	5.8	5.8	5.8	5.8	4.9	4.9	4.9	4.9	4.9	4.9	4.9	4			
26.3 0.9					6.3	6.3	6.3	6.3	6.3	6.3	6.3	6.3	6.3	6.3	6.3	6.3	6.3	6.3	5.8	5.8	5.8	5.8	5.8	5.8	5.8	5.8	5.8	5.8	5.8	4.9	4	4		
25.7 0.6											6.3	6.3	6.3	6.3	6.3	6.3	6.3	6.3	6.3	6.3														
25.4 0.3						6.3	6.3	6.3	6.3	6.3	-	-	-	-	-	-	IH.	-	-	-	5.8	5.8	5.8	5.8	5.8	5.8	5.8	5.8	5.8	5.8	4.9	4.9	4.9	4.9
<b>25.1</b> 0.3	1										6.3	6.3	6.3	6.3	6.3	6.3	6.3	6.3	6.3	6.3														
24.5 0.6							6.3	6.3	6.3	6.3	6.3	6.3	6.3	6.3	6.3	6.3	6.3	6.3	6.3	6.3	6.3	6.3	6.3	6.3	6.3	5.8	5.8	5.8	5.8	5.8	5.8	5.8	5.8	5.8
23.6 0.9														6.3	6.3	6.3	6.3	6.3	6.3	6.3	6.3	6.3	6.3	6.3	6.3	6.3	6.3	6.3	6.3					<del></del>
23.6 0.9															6.3	6.3	6.3	6.3	6.3	6.3														
															6.3	6.3	6.3	6.3	6.3	6.3														
Current	oulk excavat	on level		27	26	25	24.6	24.6	24.6	24.6	24.6	24.6	23.7	22	22	22	22	<b>7 22</b>	22.5	22.5	24	24	24	24	23.7	23.7	24	24	24	25				
Neter	C		211									GEO	PID PEINEOPO	CENTENIT TO BE I	PLACED AT INTE	PEACE OF SUB	CPADE																	
Note:	Cement tro			ogria								IMPRO	OVEMENT AND	CT FILL OR AS	DIRECTED BY SU	IPRENTENDENT		/																
	Retaining																																	
	Retaining			to 6.2m																														
	Retaining																																	
	First strap Strap for s				ad on site																													
	Strap for S	ingraue IIII	provemen	t as un ett	eu on site																													





isclaimer:

This drawing is copyright of CJ Arms. It must not be copied or reproduced without written consent from the owner.

Do not scale from this drawing. Only figured dimensions are to be taken from this drawing.

All contractors must visit site and be responsible for taking and checking all dimensions related to the works shown on the drawing prior to fabrication or setting out.

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- THE INFORMATION CONTAINED ON THIS PLAN IS A REPRESENTATION OF THE DESIGN PREPARED BY DOUGLAS PARTNERS. REFER TO:
- DOUGLAS PARTNERS REPORT #95572.01\_R001 FOR DESIGN AND CERTIFICATION OF THE ROCK WALL.
- DOUGLAS PARTNERS REPORT #95572.01\_R002 FOR CONSTRUCTION SPECIFICATION. ANY DISCREPANCIES BETWEEN THE DESIGN DRAWINGS AND THE DOUGLAS PARTNERS REQUIREMENTS SHALL BE REFERRED TO THE SUPERINTENDENT.

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END

START

END

TP

ΙP

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START

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END

C1

L2

C2

L3

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C4

C5

C6

C7

C8

L9

60.83

60.83

108.96

110.85

112.73

112.73

130.24

132.11

133.97

133.97

202.86

203.09

203.31

203.31

227.26

231.85

236.38

236.38

245.40

245.40

246.13

246.86

253.35

254.04

254.72

254.72

260.64

265.08

268.88

268.88

279.72



Set Out Table for LOWER LOTS - BOTTOM OF ROCK WALL A

310280.451 5818858.552

310293.095 5818918.054

310293.095 5818918.054

310293.112 5818918.136

310293.112 5818918.136

310302.941 5818965.164

310303.327 5818967.012

310310.104 5818985.196

310310.757 5818986.946

310311.142 5818988.774

310311.142 5818988.774

310325.342 5819056.186

310325.342 5819056.186

310325.388 5819056.403

310325.430 5819056.620

310325.430 5819056.620

310329.950 5819080.142

310329.950 5819080.142

310330.817 5819084.653

310329.268 | 5819098.186

310329.186 5819098.910

310329.145 5819099.636

310329.145 5819099.636

310328.783 5819106.121

310328.745 5819106.803

310328.745 5819107.487

310328.745 5819107.487

310328.738 5819113.402

310328.656 5819117.848

310317.505 5819128.222

5819089.216

5819089.216

5819098.186

5819106.121

5819113.402

5819120.454

5819120.454

310330.295

310330.295

310329.268

310328.783

310328.738

310325.054

310325.054

5818965.164

5818968.780

5818968.780

5818985.196

310302.941

310303.986

310303.986

310310.104

310293.104 | 5818918.095

CHAINAGE EASTING NORTHING LENGTH RADIUS BEARING

0.08

48.04

3.77

17.52

3.73

68.89

0.44

23.95

9.11

1.46

6.49

1.37

8.25

10.83

25.0

25.0

25.0

30.0

25.0

25.0

8.9

011° 59′ 47″

011° 48′ 17″

016° 07' 21.87"

020° 26′ 27″

016° 10' 05.17"

011° 53′ 43″

011° 23′ 14.07″

010° 52′ 45″

002° 10' 30.97"

353° 28′ 17″

355° 08' 21.56"

356° 48′ 26″

358° 22' 26.41"

359° 56′ 27″

332° 24' 40.60"

315° 49′ 17″

25.0 011° 54' 01.97"


Drawing Title
SETOUT - ROCKWALL A RIVER VALLEY - STAGE 7D1 YOURLAND

Purpose of Issue Drawn Scale Date of First Issue Checked By ISSUED FOR CONSTRUCTION AS SHOWN @ A1 09.12.22 15006 CJA 7D1 DWG 4001








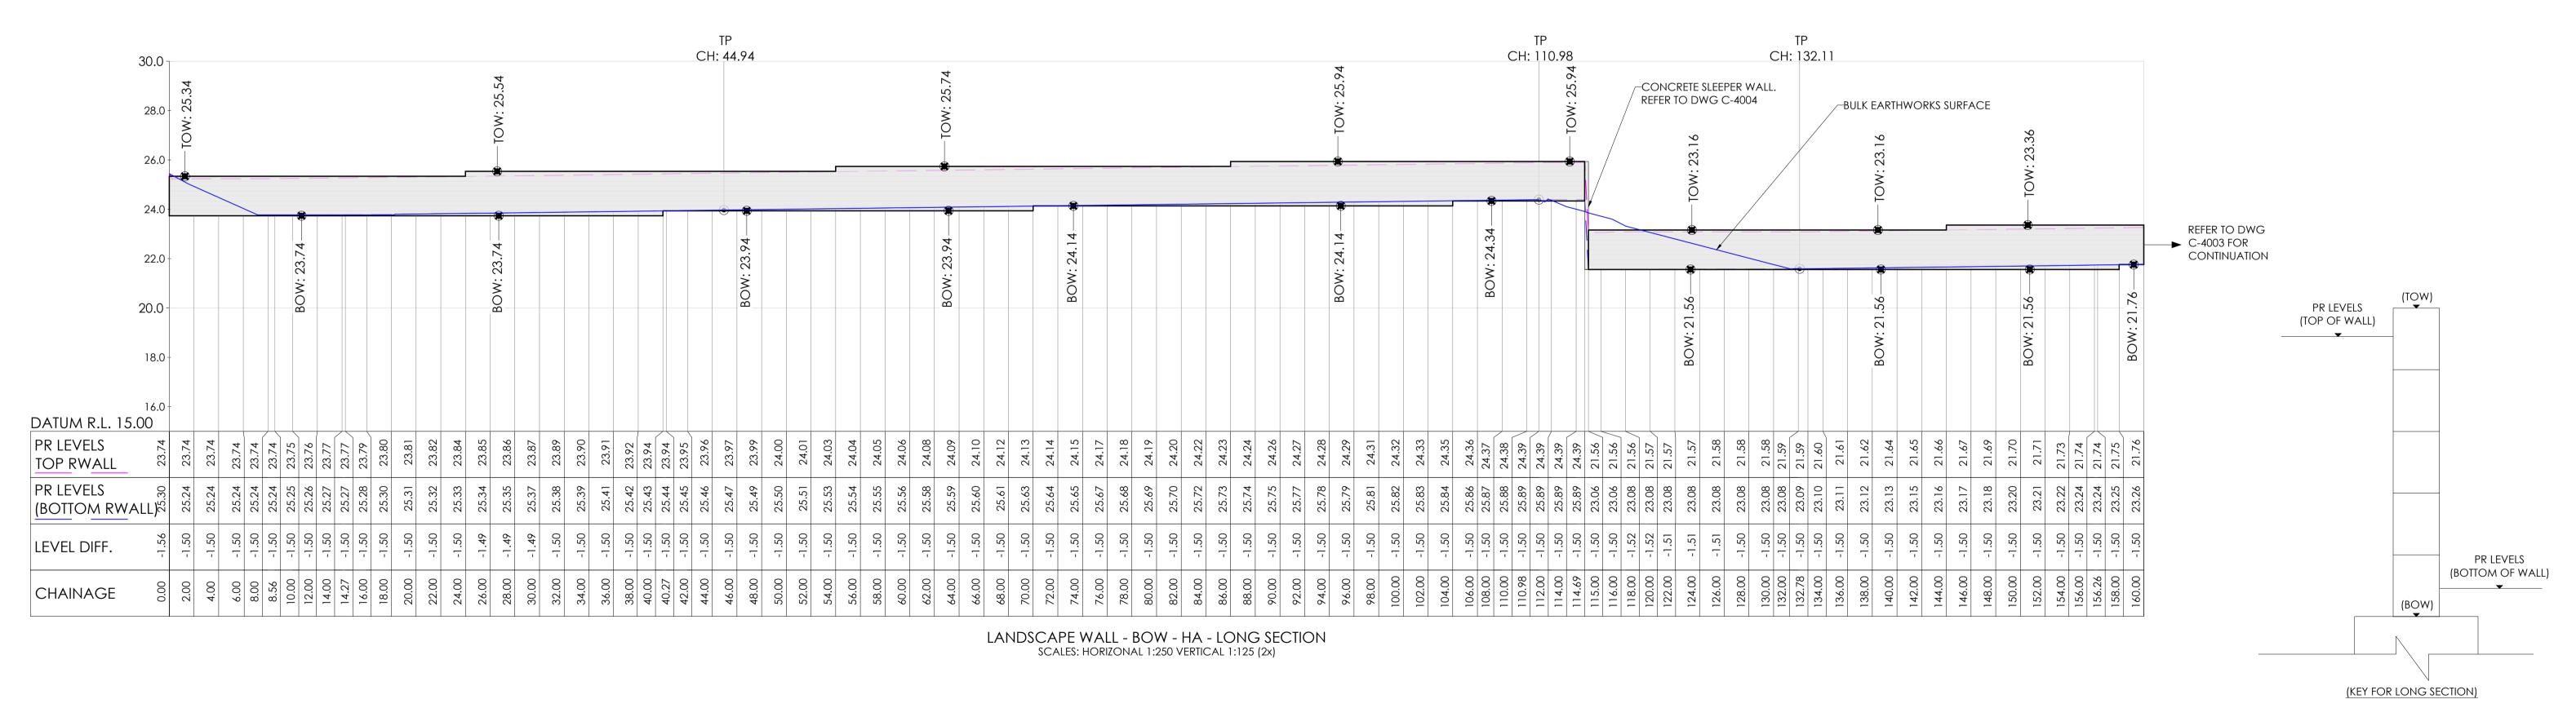

0 1 2.5 5 7.5 10 15 20 25m

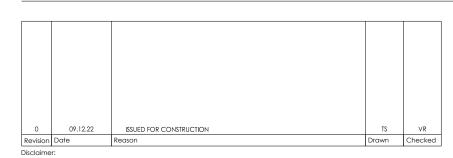

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drawing.

RETAINING WALL SECTIONS ARE PROVIDED BY CJ ARMS TO REPRESENT THE PROPOSED GROUND LEVEL AT THE TOP AND BOTTOM OF RETAINING WALLS.

THE CONTRACTOR IS TO DETERMINE OPTIMAL CONCRETE SLEEPER HEIGHT/POST SPACING AND ASSOCIATED FOUNDATIONS TO ACHIEVE THE PROPOSED GROUND LEVELS SHOWN BY CJA.

REFER TO DRAWING C-8022 FOR RETAINING WALL DETAILS.

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YourLand Developments



MELBO	/IL SITEWORKS  JRNE SYDNEY 3 9285 2800   T: +61 2 8036 8370	E:info@cjarms.com	W : www.cjarms	.com	
Project RIVER VALLEY	- STAGE 7D1		Drawing Title LONGSECTION	ON - LANDSCAPE	RETAINING WALL
Client YOURLAND			(SHEET 1 OF	2)	
Purpose of Issue		Drawn By	Checked By	Drawn Scale	Date of First Issue
ISSUED FOR CO	ONSTRUCTION	TS	VR	AS SHOWN @ A1	09.12.22

Level 00


15006 CJA 7D1

File Type Role

DWG C

4002

14.0

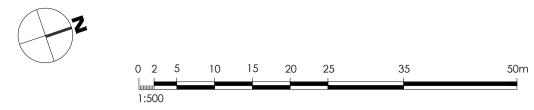






310318.696 5819129.437


START

END

281.93



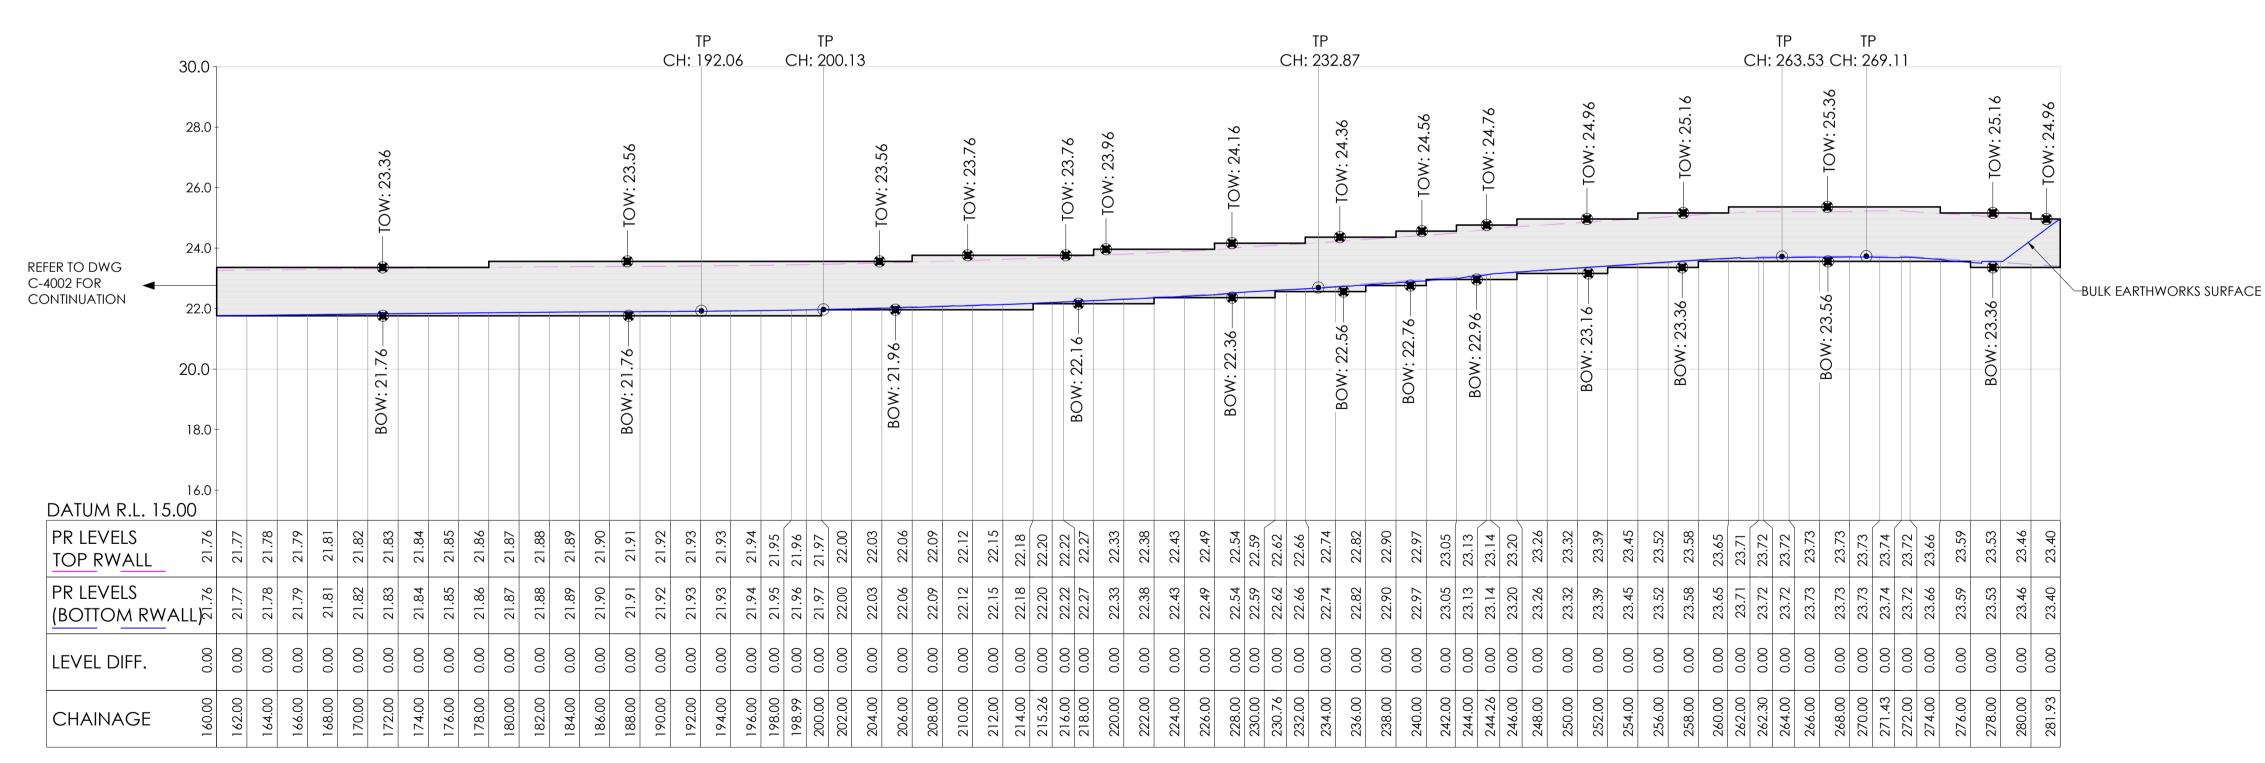

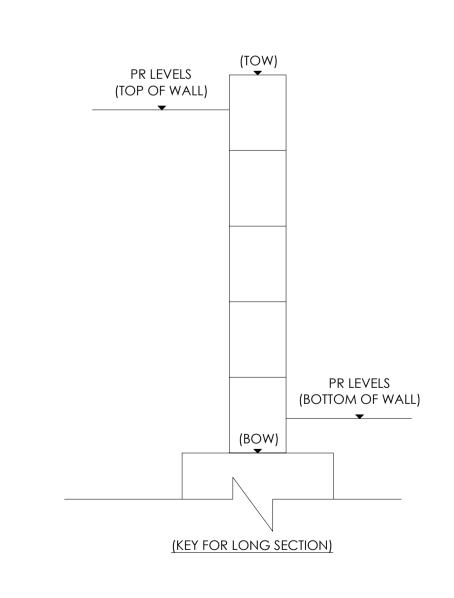

314° 10′ 42″

LANDSCAPE WALL - BOW - HA - LONG SECTION SCALES: HORIZONAL 1:250 VERTICAL 1:125 (2x)

09.12.22 ISSUED FOR CONSTRUCTION ate Reason

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retaining wall sections are provided by CJ arms to represent the proposed ground LEVEL AT THE TOP AND BOTTOM OF RETAINING WALLS.

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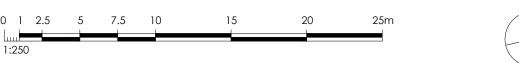
CIVIL SITEWORKS MELBOURNE SYDNEY
T: +61 3 9285 2800 | T: +61 2 8036 8370 | E:info@cjarms.com | W:www.cjarms.com Project RIVER VALLEY - STAGE 7D1 Drawing Title
LONGSECTION AND SETOUT - LANDSCAPE RETAINING WALL YOURLAND (SHEET 2 OF 2)


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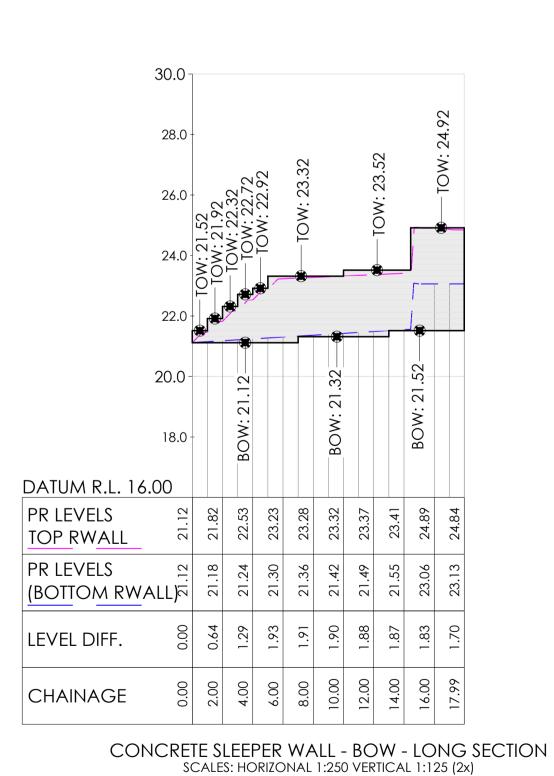
ISSUED FOR CONSTRUCTION 15006 CJA


Checked By VR AS SHOWN @ A1 09.12.22 File Type 7D1 00 DWG 4003








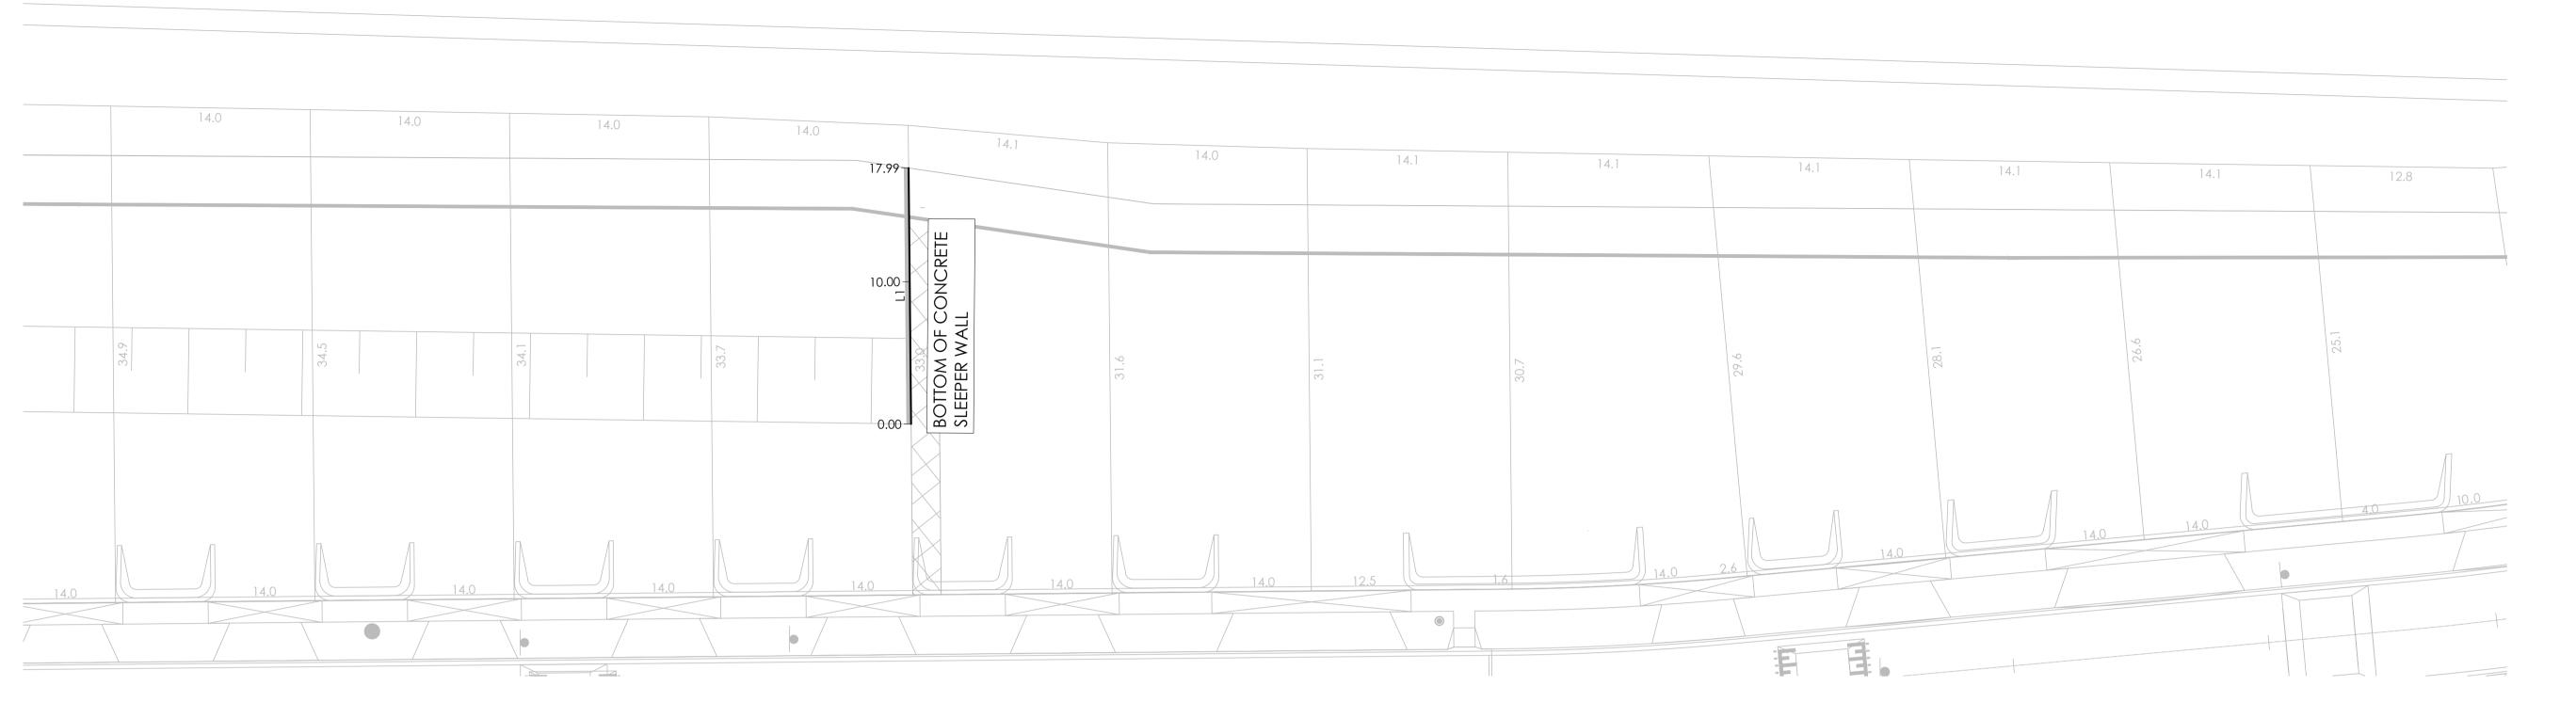

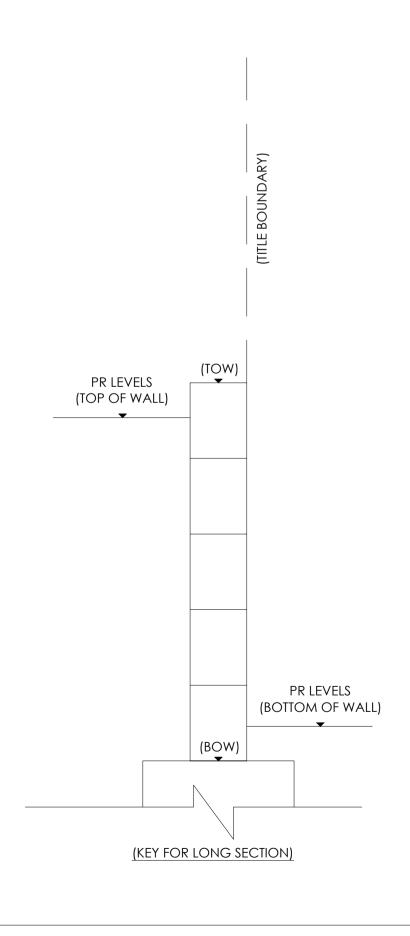

	Set	Out Table	e for CON	CRETE SLEEI	PER WA	LL - BO\	W
TAG		CHAINAGE	EASTING	NORTHING	LENGTH	RADIUS	BEARING
L1	START END	0.00 17.99	310320.969 310303.317	5818967.419 5818970.870	17.99		281° 03′ 39"

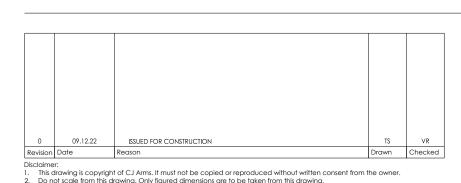

drawing.

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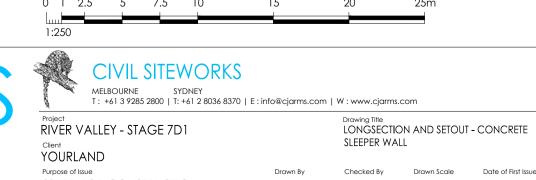
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ISSUED FOR CONSTRUCTION

REFER TO DRAWING C-8022 FOR RETAINING WALL DETAILS.








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15006 CJA 7D1

ISSUED FOR CONSTRUCTION AS SHOWN @ A1 09.12.22 00 4004 DWG

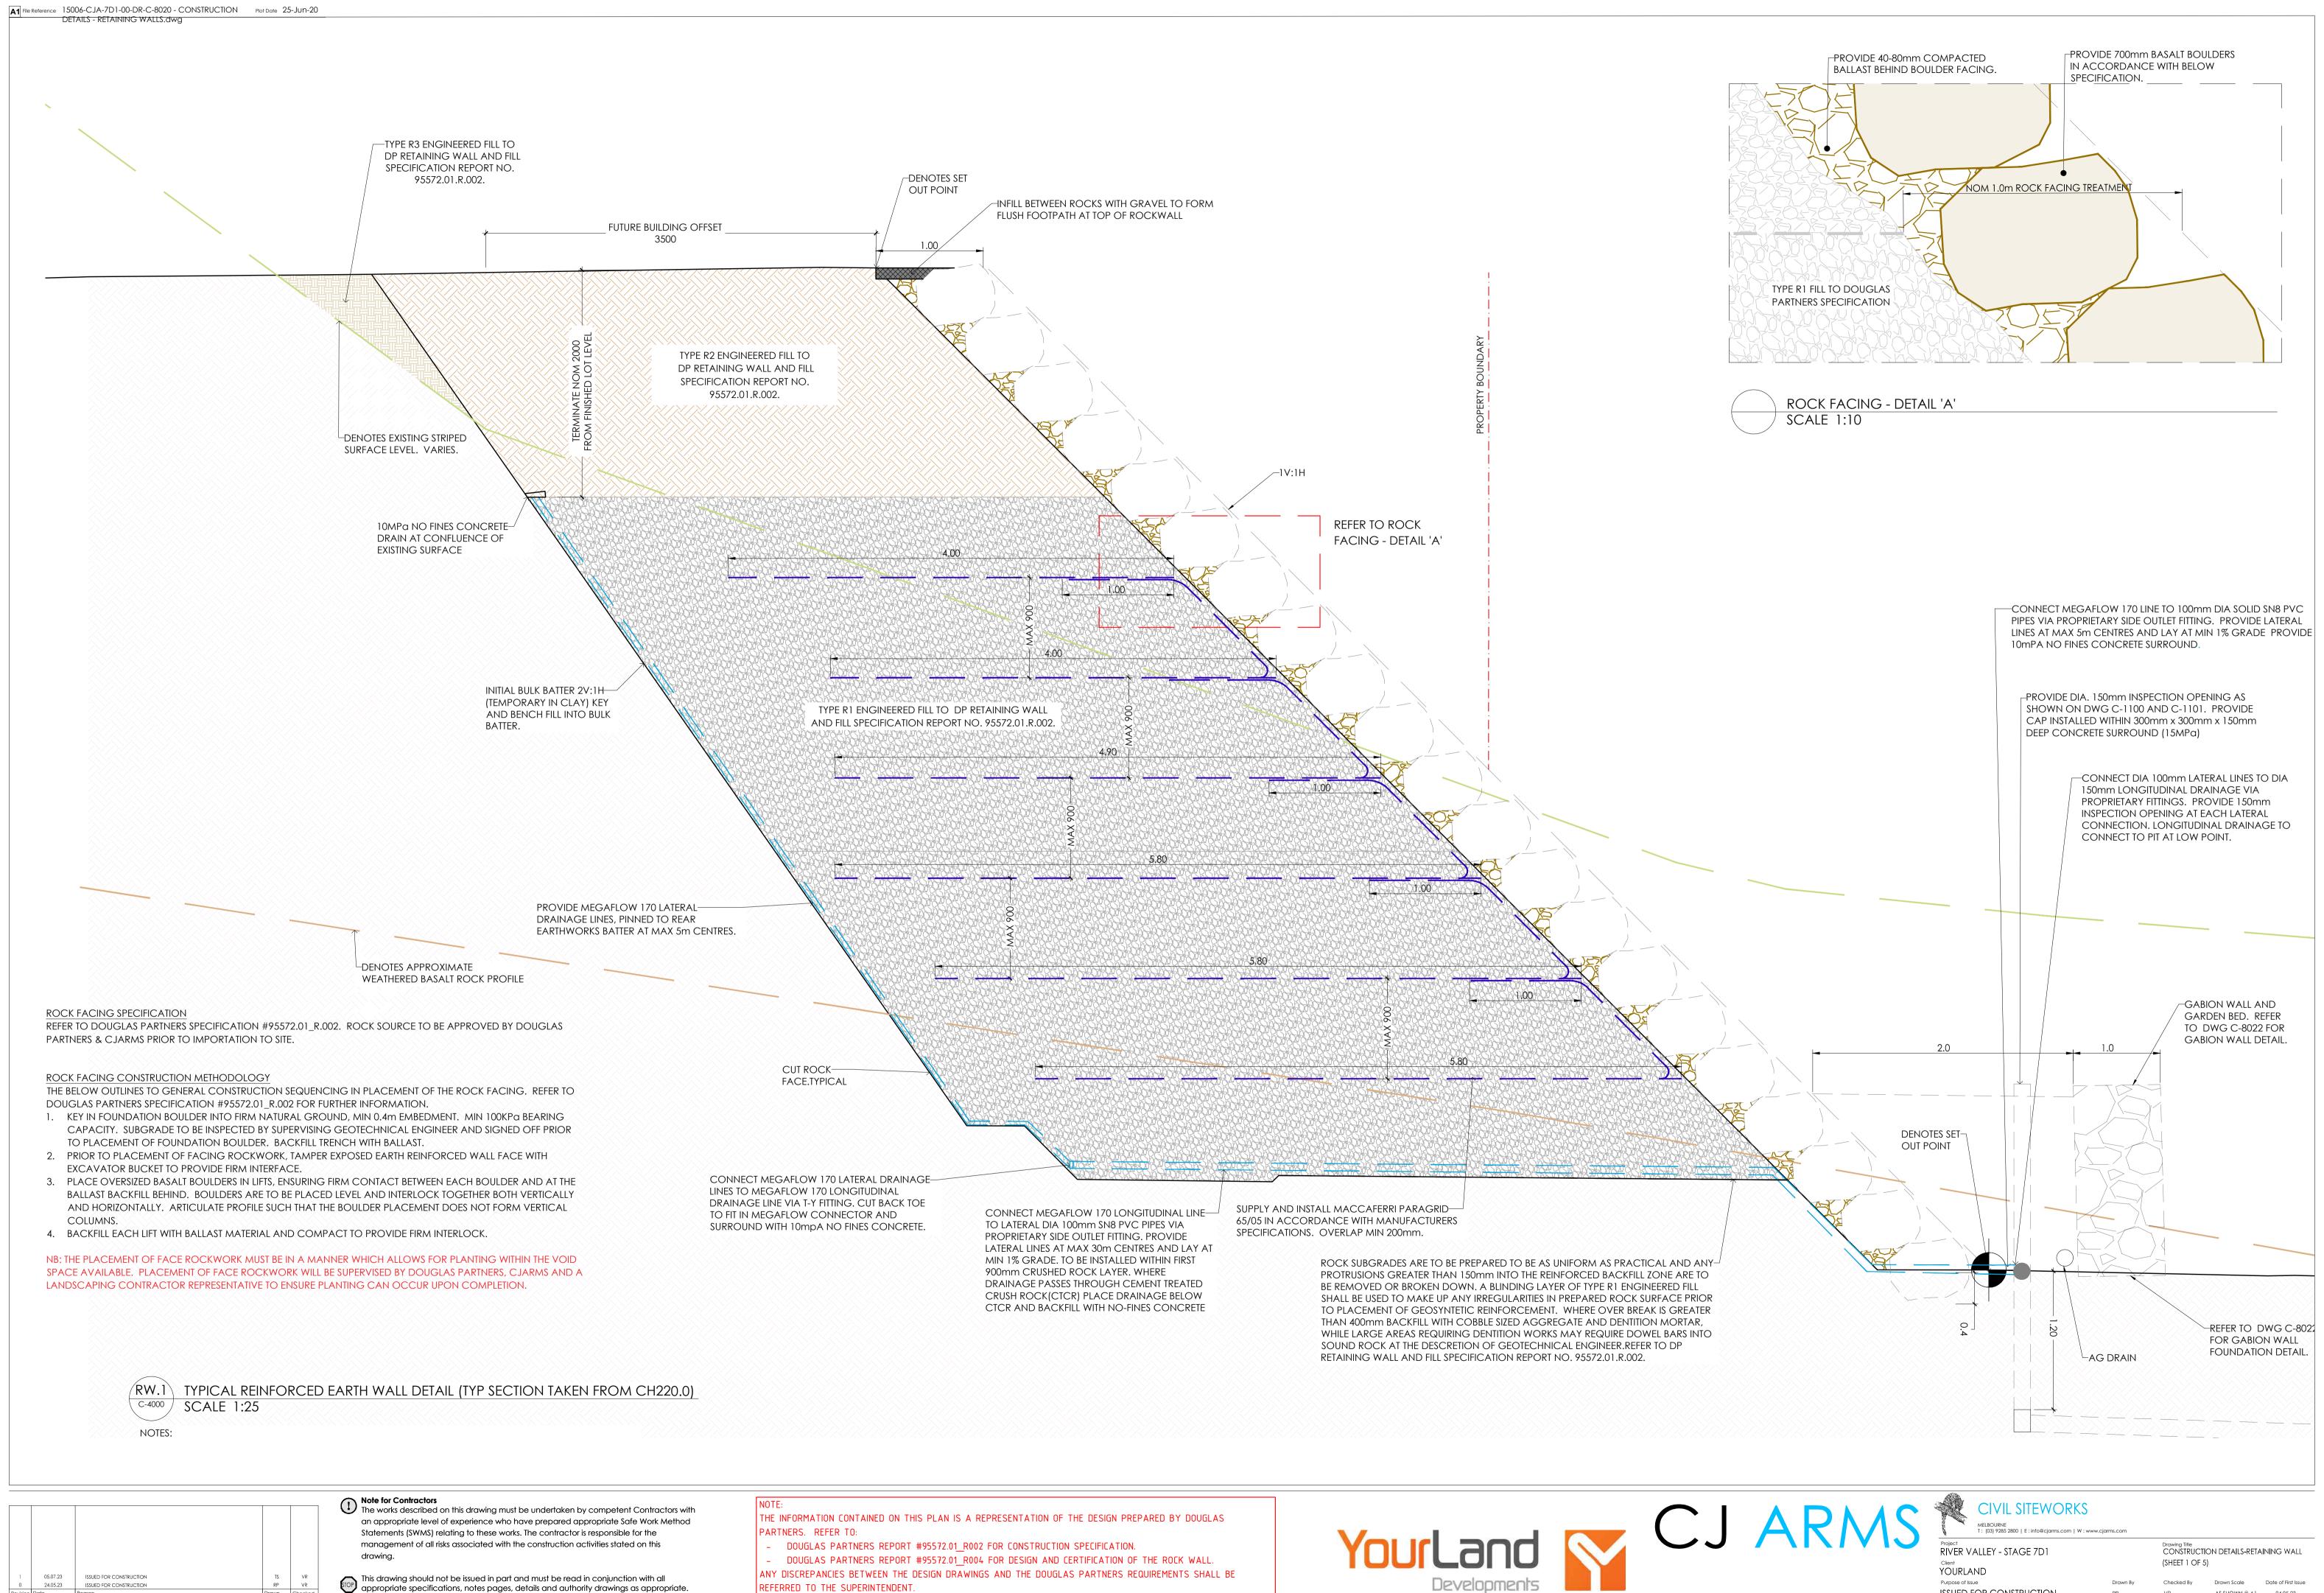


24.05.23 ISSUED FOR CONSTRUCTION te Reason

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ISSUED FOR CONSTRUCTION AS SHOWN @ A1 24.05.23 15006 CJA 7D1 DR




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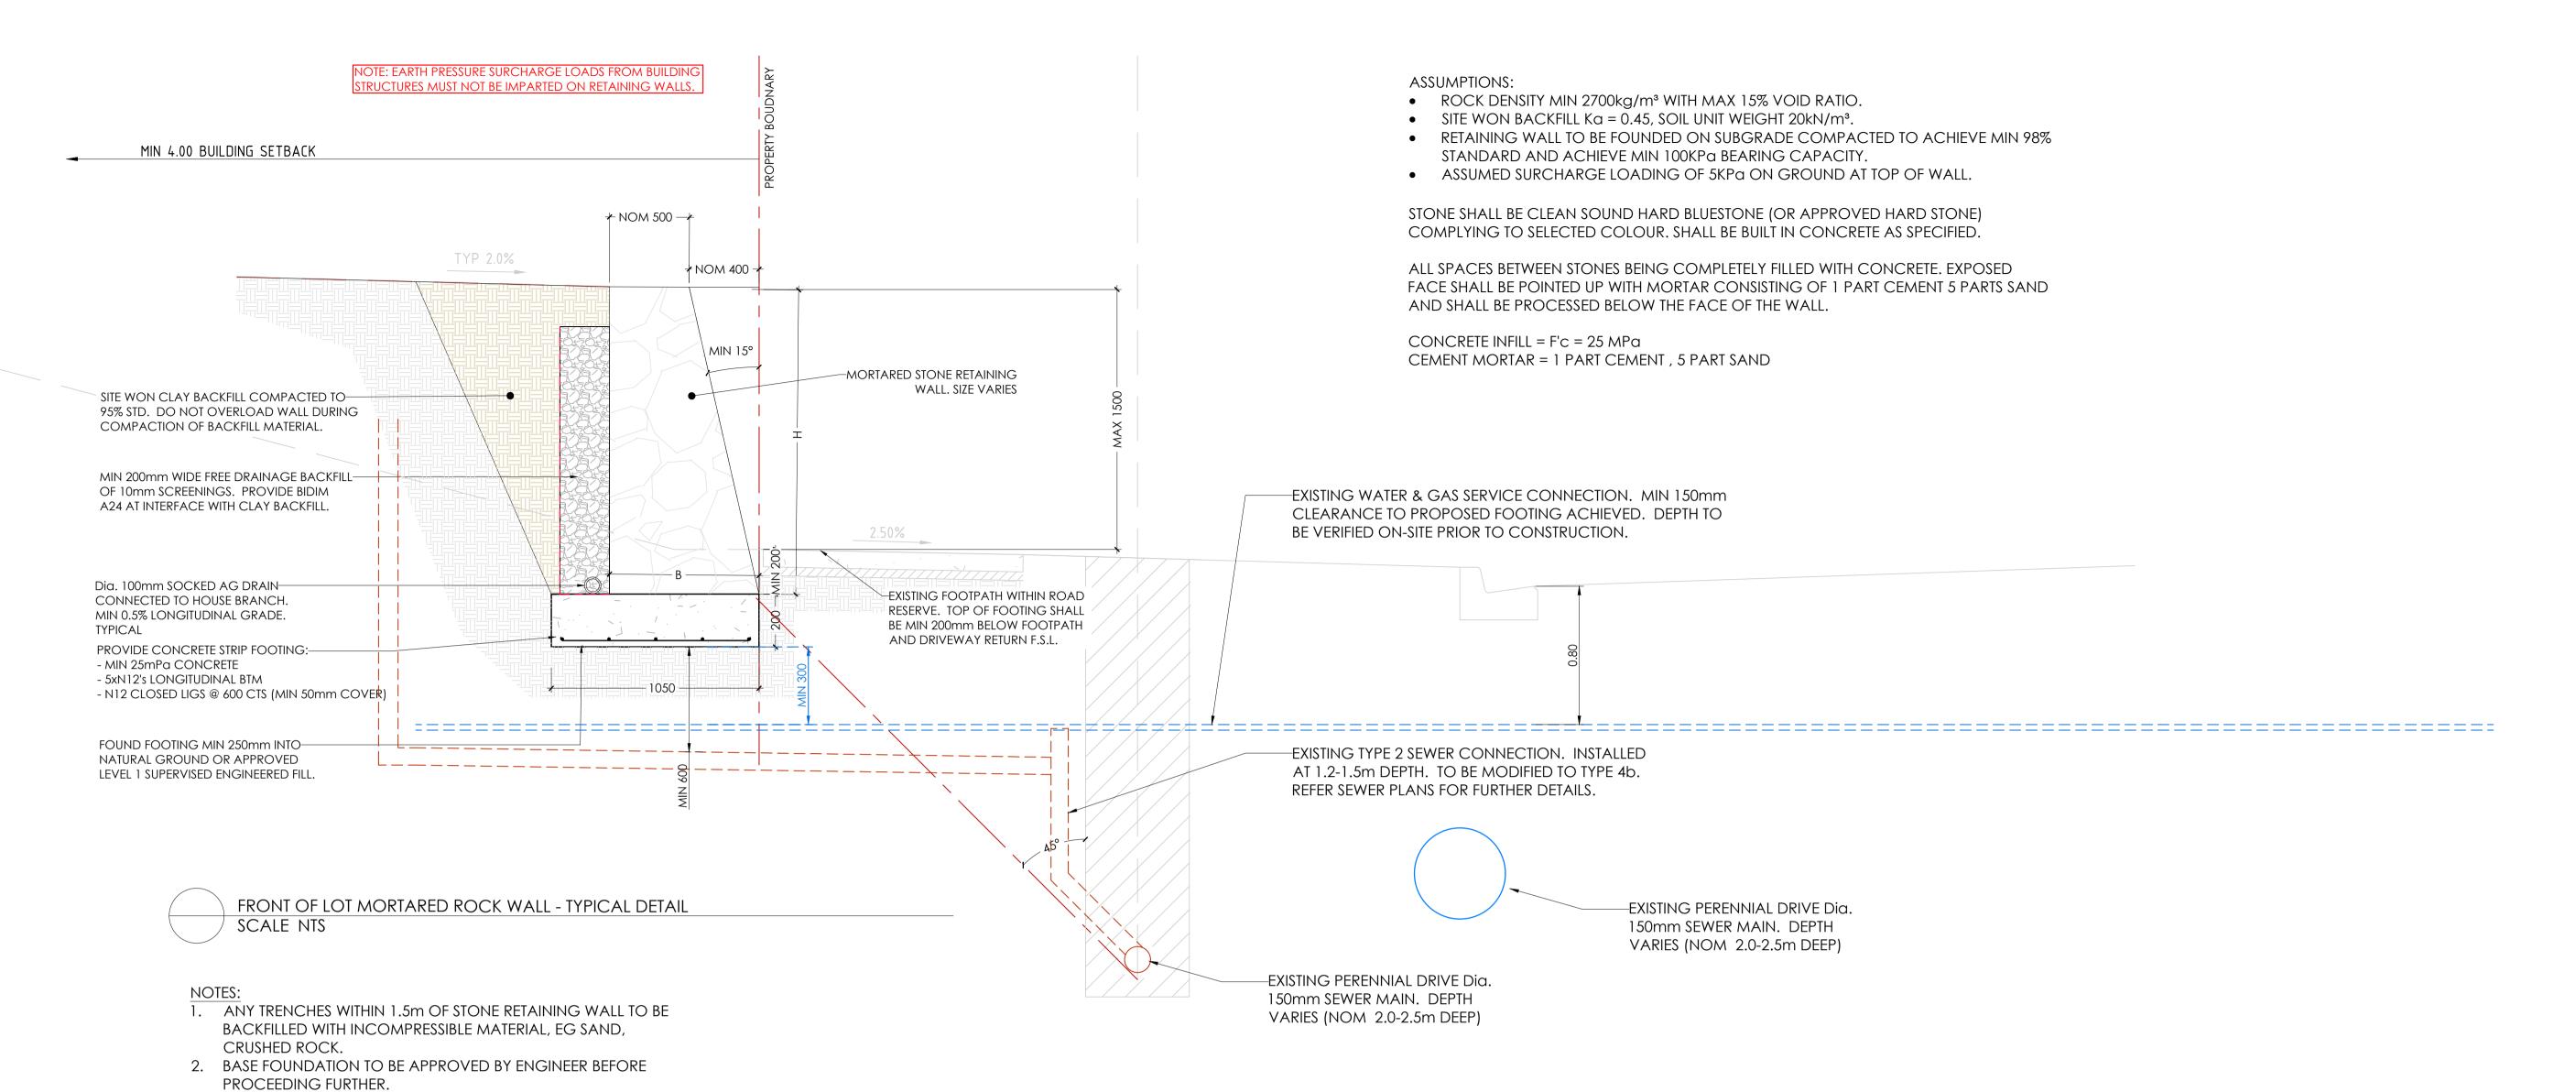


TABLE.01	- ROCKWORK - RETAININ	G WALL SCHEDULE - 5kPa SURC	CHARGE
RETAINED HEIGHT (H)	SLANT OF FACE	TOP ROCK WIDTH	BASE ROCK WIDTH (B)
0mm - 1700mm	15 DEGREES	500mm (MIN)	0.6 x WALL HEIGHT (H)
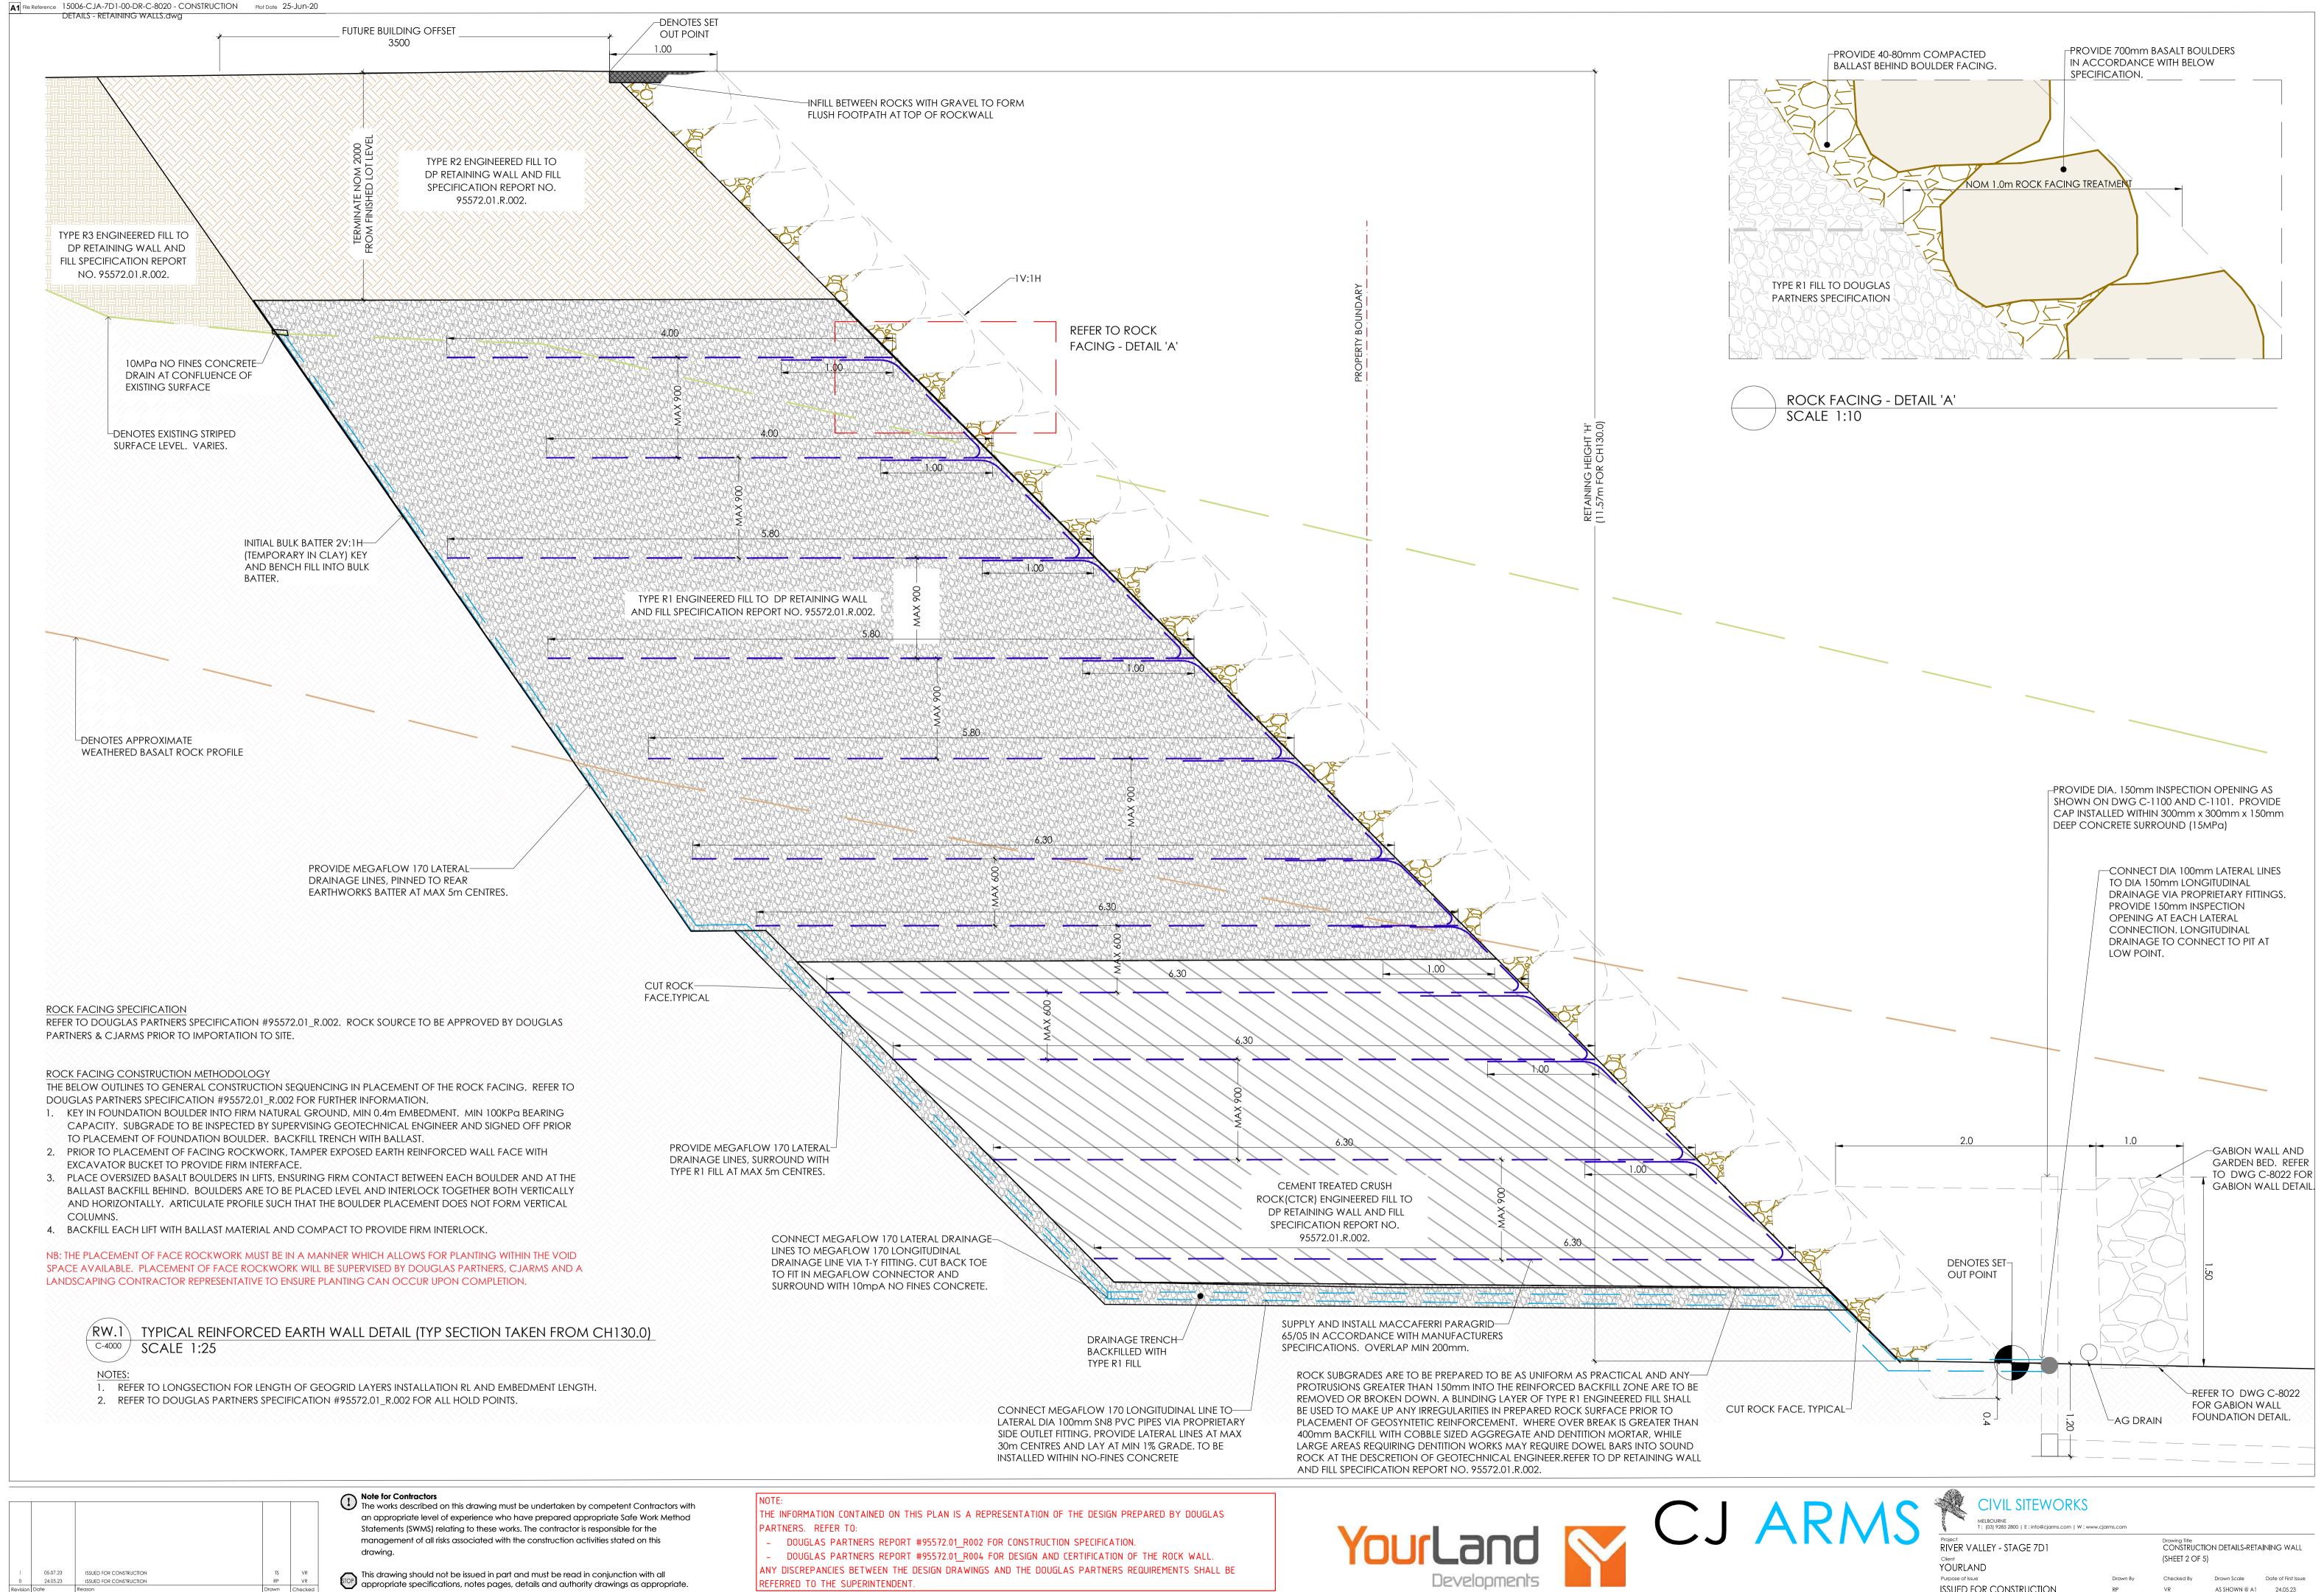
#### ASSUMPTIONS:

drawing.

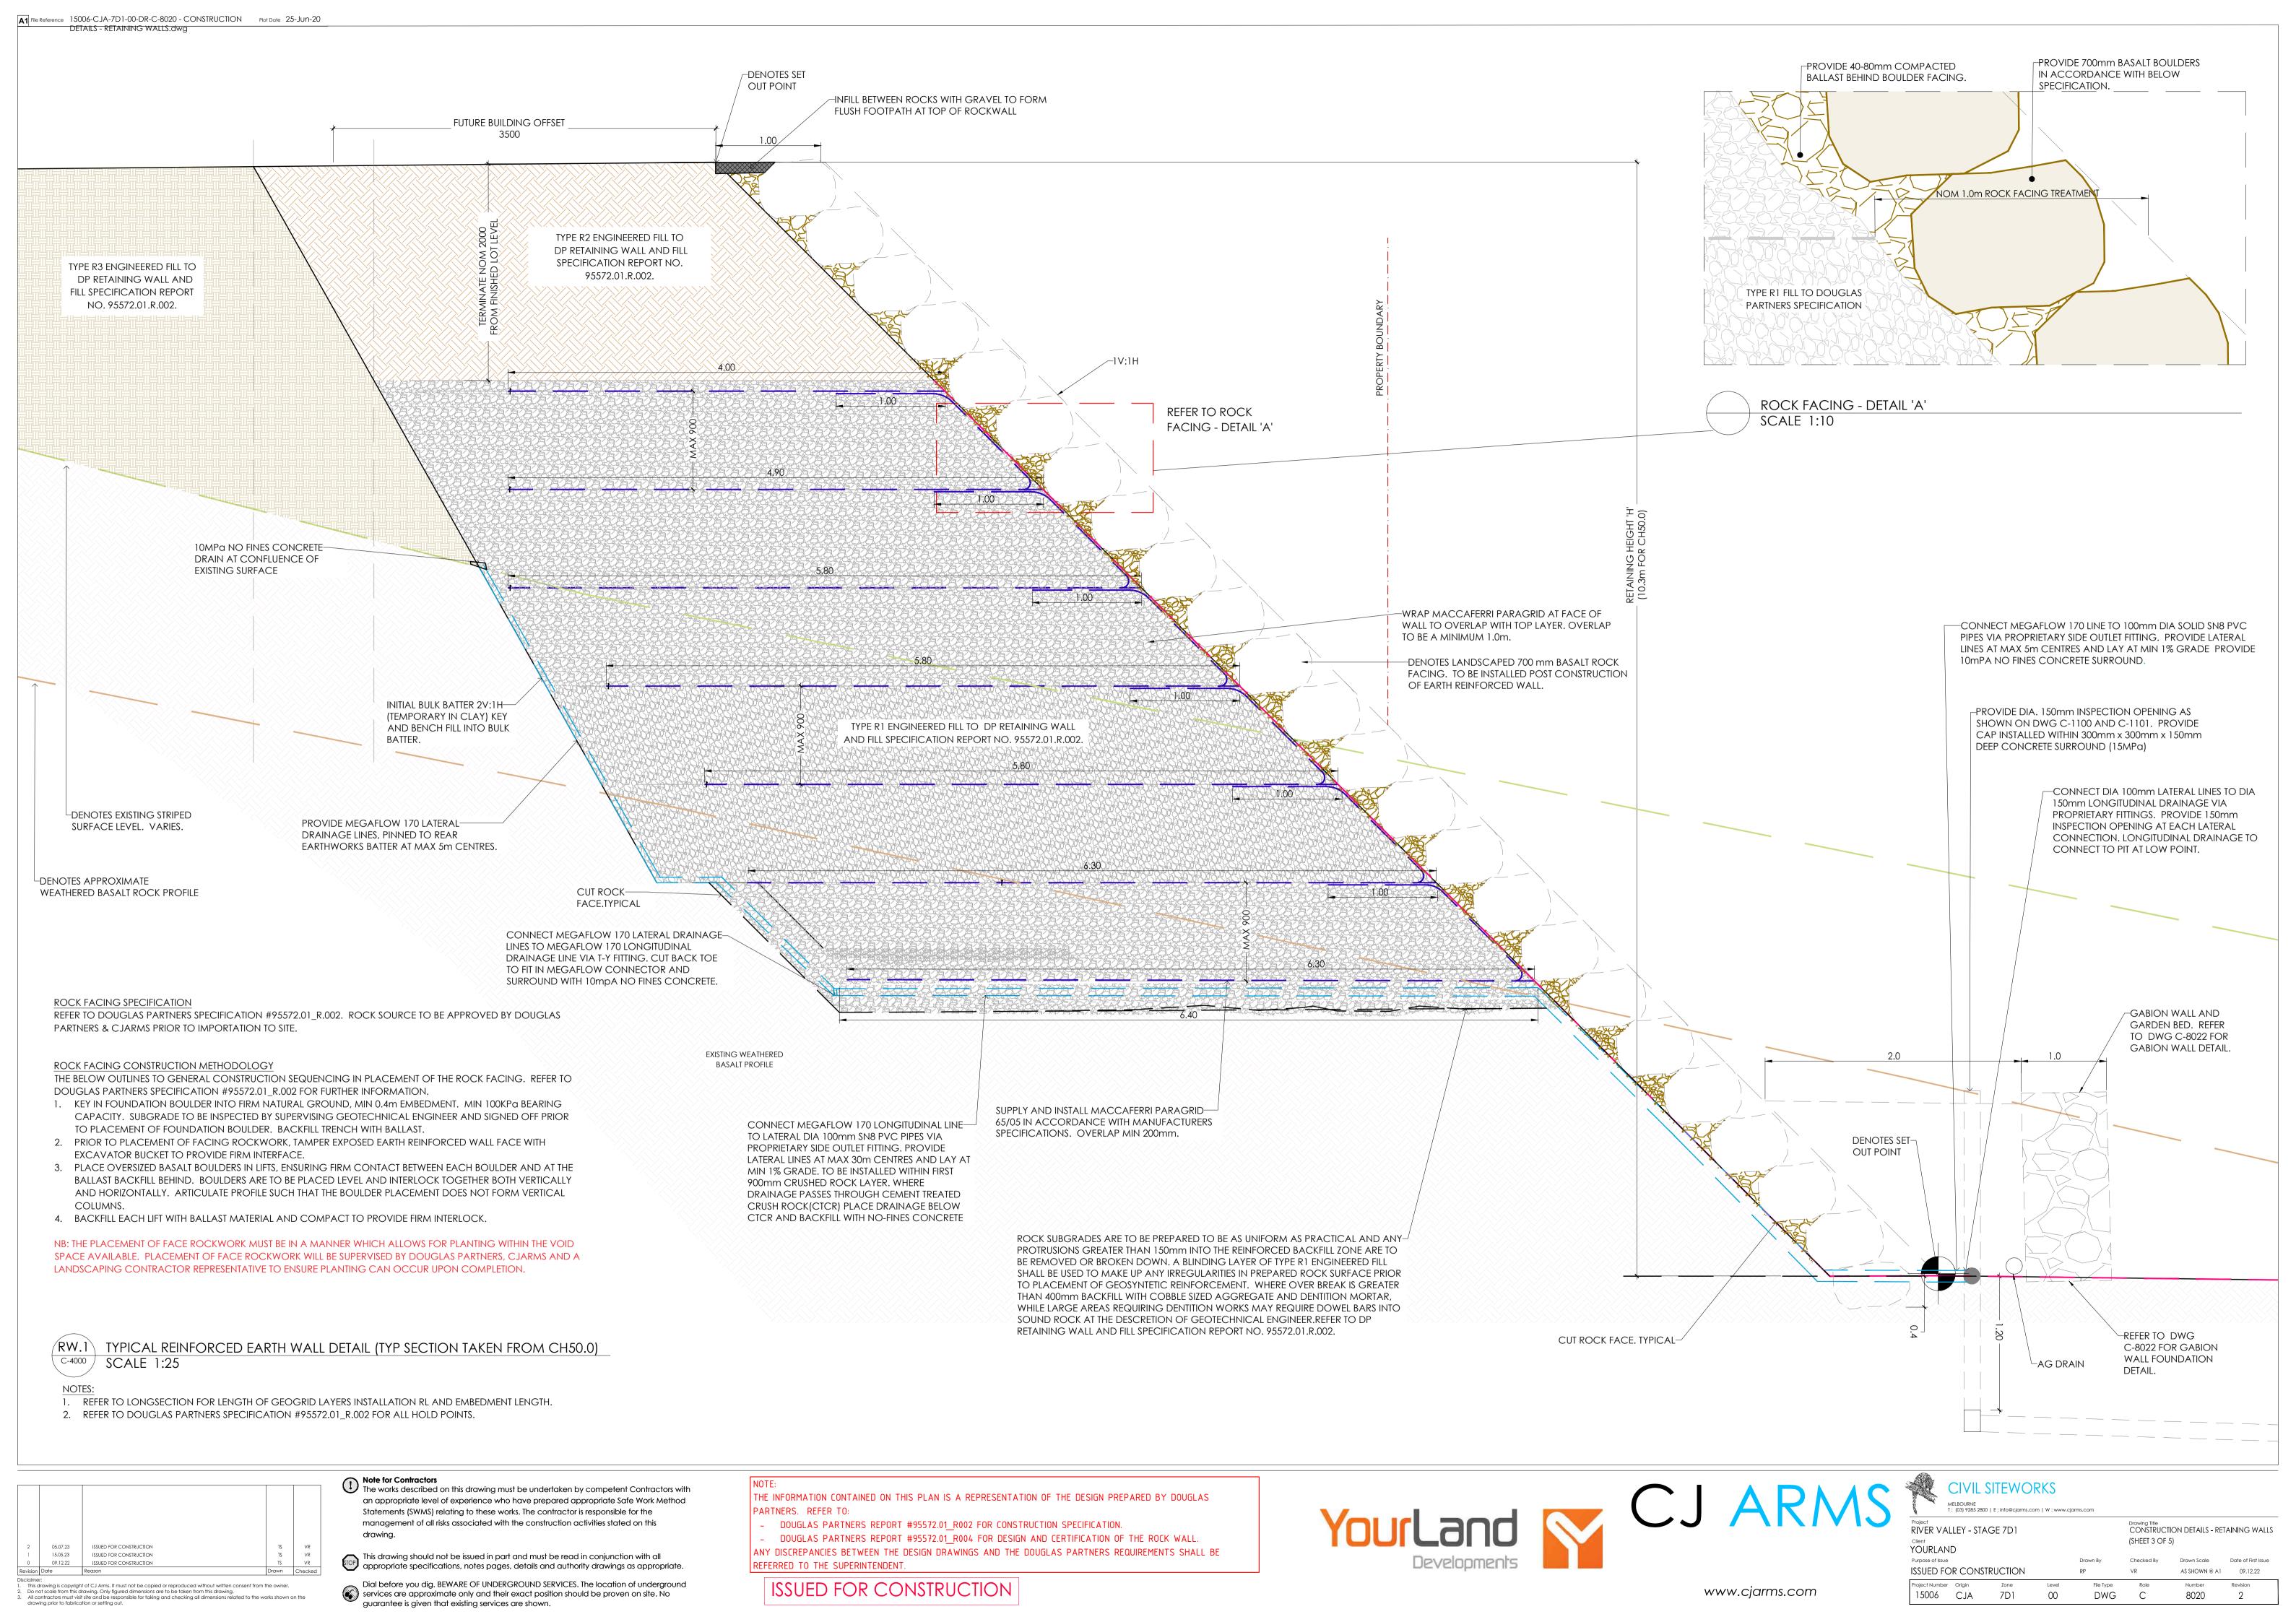ROCK DENSITY MIN 2700kg/m³ WITH MAX 15% VOID RATIO.

3. CROSSING SEWER SPUR BRANCHES TO BE CONSTRUCTED AS

CLEARANCE REQUIRED TO RETAINING WALL FOOTINGS,

PER MRWA-S-209. 0.6m MINIMUM VERTICAL AND HORIZONTAL

- SITE WON BACKFILL Ka = 0.45, SOIL UNIT WEIGHT 20kN/m³.
   RETAINING WALL TO BE FOUNDED ON SUBGRADE COMPACTED TO ACHIEVE MIN 98%
- STANDARD AND ACHIEVE MIN 100KPa BEARING CAPACITY.
- STANDARD AND ACHIEVE MIN 100KPa BEARING CAP.
   ASSUMED SURCHARGE LOADING OF 5KPa ON WALL.

# 2 05.07.23 ISSUED FOR CONSTRUCTION TS VR 1 28.04.23 ISSUED FOR CONSTRUCTION TS VR 0 09.12.22 ISSUED FOR CONSTRUCTION TS VR Revision Date Reason Drawn Checked

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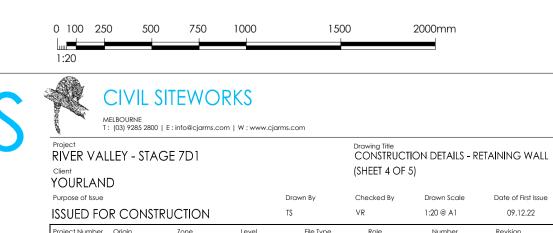
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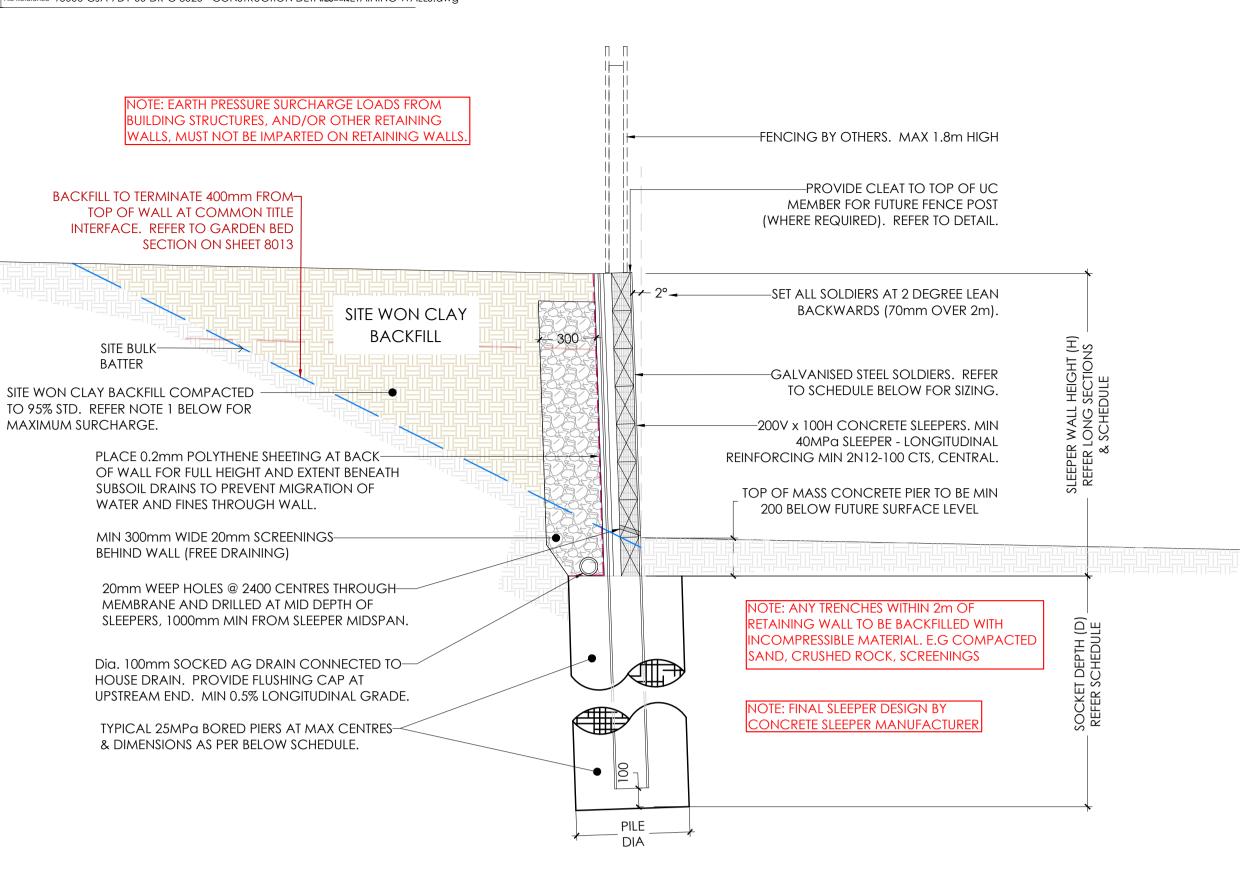


DWG

8021

00

15006 CJA 7D1



#### NOIES:

- . DESIGN LOADS ARE:
- 1.1. 5KPa WHERE RETAINING LOTS/LANDSCAPING RESERVES
- 1.2. 10KPa WHERE RETAINING ROADS
- WHERE COMPACTION EQUIPMENT LOADS EXCEEDS THE ABOVE DESIGN LOADS, ALLOW TO TEMPORARILY PROP THE FACE OF THE WALL.

  2. SOCKET DEPTH IS DEPTH INTO APPROVED NATURAL GROUND OR APPROVED SUPERVISED ENGINEERED FILL. TABULATED SOCKET DEPTHS ARE
- BASED ON THE GROUND ON THE HIGH SIDE OF THE WALL BEING HORIZONTAL. SHOULD THERE BE AN INCLINE BEHIND THE TOP OF WALL OF UP TO 1V:4H MAX: ADOPT THE DESIGN FOR HEIGHT (H) = 1.2 x ACTUAL WALL HEIGHT.

  3. WHERE THE SOCKET DEPTH EXTENDS INTO APPROVED BASALT ROCK, SOCKET DEPTH SHALL BE THE LESSER OF THE DEPTH NOTED IN THE BELOW
- SCHEDULE AND MIN 1.2m INTO THE APPROVED HIGH STRENGTH BASALT PROFILE.
- 4. BORE HOLES FOR PIERS SHALL BE CLEAN OF LOOSE SOIL AND DEBRIS. DO NOT BORE HOLES WHEN RAIN IS EXPECTED.
  5. ALL SLEEPERS ARE TO BE SLEEPER DIRECT RUSTIC WOODGRAIN SLEEPER CHARCOAL.

TABLE	TABLE.01 - PRE CAST SLEEPER WALL SCHEDULE - 5kPa SURCHARGE								
RETAINED HEIGHT	H.D GALV. SOLDERS	max. solder spacing	PIER DIAMETER (PØ)	SOCKET DEPTH (D)					
0mm - 600mm	150 UC 23	2400mm	600mm	1500mm					
601mm - 900mm	150 UC 23	2400mm	600mm	1800mm					
901mm - 1200mm	150 UC 23	2400mm	600mm	2100mm					
1201mm - 1500mm	150 UC 23	2400mm	600mm	2400mm					
1501mm - 1800mm	150 UC 23	2400mm	600mm	2800mm					
1801mm - 2100mm	150 UC 23	1800mm	600mm	2800mm					
2101mm - 2400mm	150 UC 30	1800mm	600mm	3100mm					
2401mm - 2700mm	150 UC 37	1800mm	600mm	3500mm					
2701mm - 3000mm	200 UC 46	1800mm	600mm	3800mm					
3001mm - 3300mm	200 UC 52	1800mm	600mm	4100mm					


TABLE.02 - PRE CAST SLEEPER WALL SCHEDULE - 10kPa SURCHARGE									
RETAINED HEIGHT	H.D GALV. SOLDERS	max. solder spacing	PIER DIAMETER (PØ)	SOCKET DEPTH (D)					
0mm - 600mm	150 UC 23	1800mm	600mm	1500mm					
601mm - 900mm	150 UC 23	1800mm	600mm	1800mm					
901mm - 1200mm	150 UC 23	1800mm	600mm	2100mm					
1201mm - 1500mm	150 UC 23	1800mm	600mm	2400mm					
1501mm - 1800mm	150 UC 23	1200mm	600mm	2400mm					
1801mm - 2100mm	150 UC 23	1200mm	600mm	2700mm					
2101mm - 2400mm	150 UC 30	1200mm	600mm	3000mm					
2401mm - 2700mm	150 UC 37	1200mm	600mm	3300mm					
2701mm - 3000mm	200 UC 46	1200mm	600mm	3500mm					
3001mm - 3300mm	200 UC 52	1200mm	600mm	3800mm					

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RW.04 RW.04 - PRE-CAST SLEEPER - FENCE CONNECTION DETAIL


SCALE 1:10

# GABION WALL NOTES

- HEXAGONAL MESH WIRE NETTING SHALL HAVE THE FOLLOWING PROPERTIES:
- a) WIRE AND SELVEDGE WIRE SHALL HAVE A MINIMUM TENSILE STRENGTH OF 380 MPa AND A MINIMUM DIAMETER OF 2.7mm AND 3.4mm RESPECTIVELY
- b) WIRE AND SELVEDGE WIRE SHALL SHALL BE COATED WITH A MINIMUM OF 240g/m2 ZINC/5% ALUMINIUM ALLOY AND A MINIMUM O.5mm OF GREY COLOURED EXTRUDED PVC, PRIOR TO NETTING MANUFACTURE.
- c) NETTING SHALL BE MANUFACTURED BY WINDING TWO WIRES AROUND EACH OTHER THROUGH THREE 180DEG ROTATIONS TO FORM A TIGHT, HELICAL TWIST WITH A NOMINAL MESH SIZE OF 80mm x 100mm.
- 2. GABION FILL MATERIAL
- a) ROCK SIZE: MIN 100mm, MAX 250mm
- b) GABION FILL MATERIAL SHALL CONSIST OF ROCK WITH NOT LESS THAN TWO BROKEN OR ANGULAR FACES. THE ROCK SHALL BE RESISTANT TO WEATHERING ACTION OF AIR, WIND AND WATER AND SHALL BE FREE FROM STAINING, LAMINATIONS, CRACKS AND OTHER STRUCTURAL DEFECTS WHICH MAY REDUCE ITS MECHANICAL STRENGTH.
- c) THE ROCK SHALL HAVE A MINIMUM APPARENT PARTICLE DENSITY OF 2.5 t/m3 WHEN TESTED IN ACCORDANCE WITH AS 1141.6.1. IN ADDITION, THE ROCK SHALL HAVE A MINIMUM WET STRENGTH OF 100 KN AND A WET/DRY STRENGTH VARIATION NOT EXCEEDING 35% WHEN TESTED IN ACCORDANCE WITH AS 1141.22.
- 3. GABION ASSEMBLY, INSTALLATION AND FILLING
- a) FOUNDATION PREPARATION: AREAS UPON WHICH GABIONS ARE TO BE INSTALLED SHALL BE PREPARED AND TEST ROLLED AS SPECIFIED. ANY UNSTABLE AREAS DETECTED BY TEST ROLLING SHALL BE RECTIFIED AS SPECIFIED. THE PREPARED SURFACE SHALL HAVE A SLOPE OF 10(H):1(V).
- b) ASSEMBLY: GABIONS SHALL BE LAID OUT ON A HARD, FLAT SURFACE AND STRETCHED TO REMOVE ALL KINKS AND BENDS. INDIVIDUAL GABIONS SHALL BE ASSEMBLED BY RAISING THE SIDES AND PARTITIONS AND CONNECTING SELVEDGE WIRES AT ALL ABUTTING EDGES WITH FASTENERS AT MAXIMUM 150 MM INTERVALS. GABIONS MAY BE CUT INTO TWO SEGMENTS AND SPLICED BY A MINIMUM LENGTH OF 200 MM TO FORM NONSTANDARD DIMENSIONS. FASTENERS SHALL BE INSTALLED AT BOTH EDGES OF THE SPLICE AT MAXIMUM 150 MM HORIZONTAL AND VERTICAL INTERVALS.
- C) INSTALLATION: GABIONS SHALL BE INSTALLED IN THE POSITIONS SHOWN ON THE DRAWINGS AND EACH GABION SHALL BE CONNECTED TO ALL ADJACENT GABIONS BY CONNECTING ALL ABUTTING EDGES WITH FASTENERS AT MAXIMUM 150 MM INTERVALS. TEMPORARY SUPPORTS, PERMANENT SUPPORTS CONSISTING OF GALVANIZED STAR PICKETS OR GALVANIZED STEEL STRUCTURAL SECTIONS, OR TENSIONING SHALL BE USED AS REQUIRED TO ENSURE THE SIDES OF THE INSTALLED GABIONS DO NOT VARY BY MORE THAN 50 MM FROM A 3 METRE STRAIGHT EDGE LAID ACROSS THE SURFACE PRIOR TO, DURING AND AFTER FILLING WITH GABION FILL MATERIAL
- d) FILLING: GABIONS SHALL BE FILLED WITH GABION FILL MATERIAL BY MECHANICAL MEANS AIDED BY HAND SORTING TO ENSURE THAT EXPOSED SURFACES ARE FREE FROM EXCESSIVE BULGES AND DEPRESSIONS.

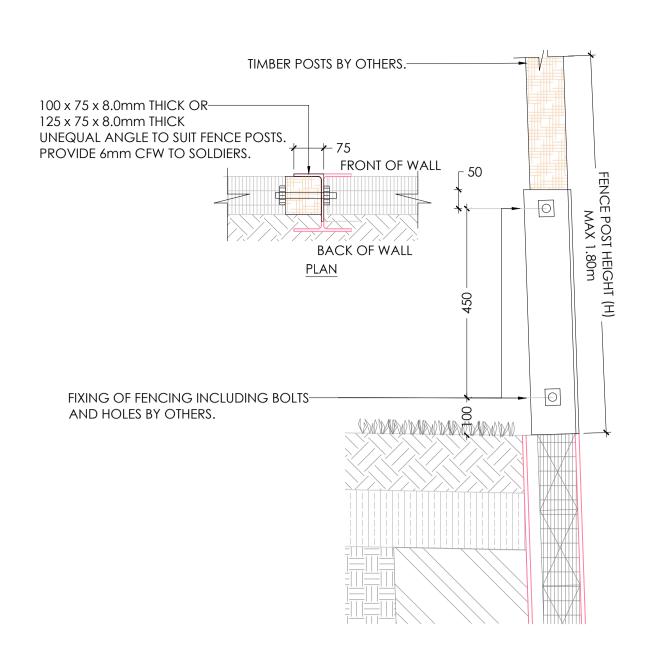  GABIONS SHALL BE ONE THIRD FILLED AND BRACES INSTALLED AT EVENLY DISTRIBUTED NOMINAL 330 MM HORIZONTAL CENTRES. GABIONS SHALL THEN BE TWO THIRDS FILLED AND ADDITIONAL BRACES INSTALLED AT EVENLY DISTRIBUTED NOMINAL 330 MM HORIZONTAL CENTRES. GABIONS SHALL THEN BE FULLY FILLED, THE SELVEDGE WIRES ON THE LIDS CONNECTED TO SELVEDGE WIRES AT ALL ABUTTING EDGES WITH FASTENERS AT MAXIMUM 150 MM INTERVALS, AND ANY TEMPORARY SUPPORTS OR TENSIONING REMOVED.

  WHERE BULGES AND DEPRESSIONS GREATER THAN 50 MM ARE PRESENT AFTER FILLING, THE GABIONS SHALL BE REFILLED. SQUARE WELDED MESH THAT IS BUCKLED BY IMPACTS DURING FILLING SHALL BE REPLACED.

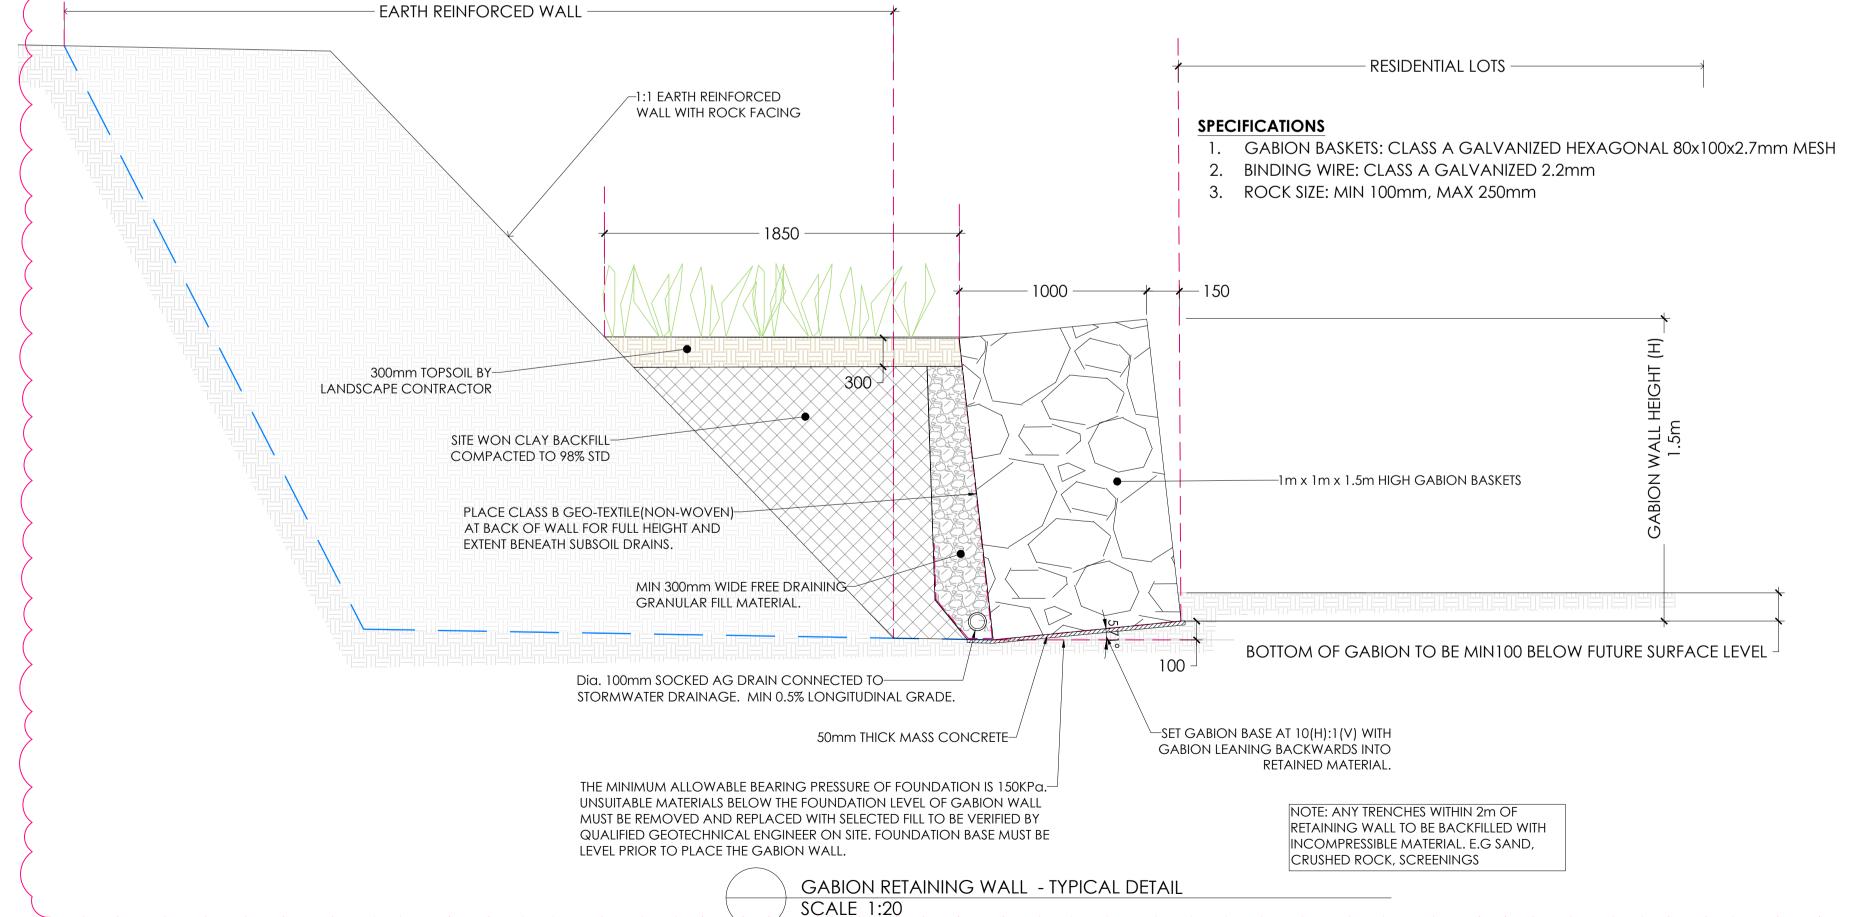







15006 CJA 7D1

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Project
RIVER VALLEY - STAGE 7D1

Client
YOURLAND
Purpose of Issue
ISSUED FOR CONSTRUCTION
TS

Drawing Title
CONSTRUCTION DETAILS - RETAINING WALLS
(SHEET 5 OF 5)

Drawn By
Checked By
Drawn Scale
Date of First Issue
Drawn By
New AS SHOWN @ A1 09.12.22

DWG

8022

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PLAN OF S	SUBDIVISIO	N		EDITIO	ON 1	PS82	1131G
LOCATION OF L	AND			COUNCIL N	AME: BRII	MBANK CITY COU	NCIL
PARISH: SECTION: CROWN ALLOTMENT SECTION: CROWN ALLOTMENT TITLE REFERENCE:	В						
LAST PLAN REFERE	NCE: Lot F on PS81748	39J					
POSTAL ADDRESS: (at time of subdivision)  MGA 94 CO-ORDINAT (of approx centre of land in plan)	Halong Drive SUNSHINE NOR ES: E: 310 260 N: 5819 000		55	THIS (REC LS IS SUF	CEIVED 07 / 01 S SUBJECT TO RVEY, APPROV	ED ON DESIGN DRAWIN / 2022) AND PRELIMINAI DESIGN CHANGES, VEI	GS BY CIVIL ENGINEERING CAD RY LINE WORK RECEIVED FROM RIFICATION OF BOUNDARIES BY ID REFERRAL AUTHORITIES, & STRATION SERVICES.
VESTING	OF ROADS AND/OF	RESERVES				NOTATIONS	
IDENTIFIER Nil	COUNCIL/E	Nil		OWNERS COF For details of a & liability see o	RPORATIONS ny Owners Co wners corpora	rporations including pu	rpose, responsibility, entitlement ners corporation additional
NOTATIONS				Lot 1 has been	omitted from t	his plan.	
DEPTH LIMITATION: 15.24 metres below the surface applied to land as shown in Vol. 11151 Fol.184.					•	affected by one or more sheet 7 and 8 of this p	e restrictions. Refer to Creation lan for details.
SURVEY: This plan is based on partial STAGING: This is a staged subdivision Planning Permit No. P277/2				purposes.	erty No.1 has t		et 5 of this plan for clarity ed on sheet 6 of this plan for
Area of Release: 7	STATE - Release S7 485m² 7 Lots, Lot S2 and Bala	nce Lots G and		CP1 - denotes Common Property No.1			
LEGEND A Assert	1. F			NFORMATIC			
LEGEND: A - Appurtenar	nt Easement E - Encumber	ing Easement R	- Encumberir	ng Easement (Roa	ad)		
Easement Reference	Purpose	Width (Metres)	0	rigin		Land Benefited	d/In Favour Of
	RS It Environments   Infrastructu	Licensed Su	S FILE REF:	Pof 02044 7	'D1	ORIGINAL SHEET SIZE: A3	SHEET 1 OF 8

0 09.12.22 ISSUED FOR CONSTRUCTION
 TS VR
Revision Date Reason Drawn Checke

Disclaimer:
1. This drawing is copyright of CJ Arms. It must not be copied or reproduced without written consent from the owner.
2. Do not scale from this drawing. Only figured dimensions are to be taken from this drawing.
3. All contractors must visit site and be responsible for taking and checking all dimensions related to the works shown on the drawing prior to fabrication or setting out.

Note for Contractors

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PS821131G

## **EASEMENT INFORMATION**

LEGEND: A - Appurtenant Easement E - Encumbering Easement R - Encumbering Easement (Road)

Easement Reference	Purpose	Width (Metres)	Origin	Land Benefited/In Favour Of
	Support  * See definition above			Relevant abutting lot on This Plan
E-1	Right for entry - for the purposes of maintenance of the sloped rock batter	See Diag.	This Plan	Common Property No.1
E-2	Drainage and way	2	This Plan	Lots on This Plan
E-3	Power Line	2	PS817489J Section 88 Electricity Industry Act 2000	Powercor Australia Ltd
E-4	Supply of Water (through underground pipes)	6	PS817489J	City West Water Corporation
E-5	Power Line	2	PS817489J Section 88 Electricity Industry Act 2000	Powercor Australia Ltd
E-6	Carriageway	2	This Plan	Brimbank City Council
			TH (R LS	RELIMINARY  IS PLAN IS BASED ON DESIGN DRAWINGS BY CIVIL ENGINEERING CAD ECEIVED 07 / 01 / 2022) AND PRELIMINARY LINE WORK RECEIVED FROM IS SUBJECT TO DESIGN CHANGES, VERIFICATION OF BOUNDARIES BY RVEY, APPROVALS FROM COUNCIL AND REFERRAL AUTHORITIES, & TIMATE REGISTRATION AT LAND REGISTRATION SERVICES.
	YLORS			ORIGINAL SHEET Ref. 02044-7D1



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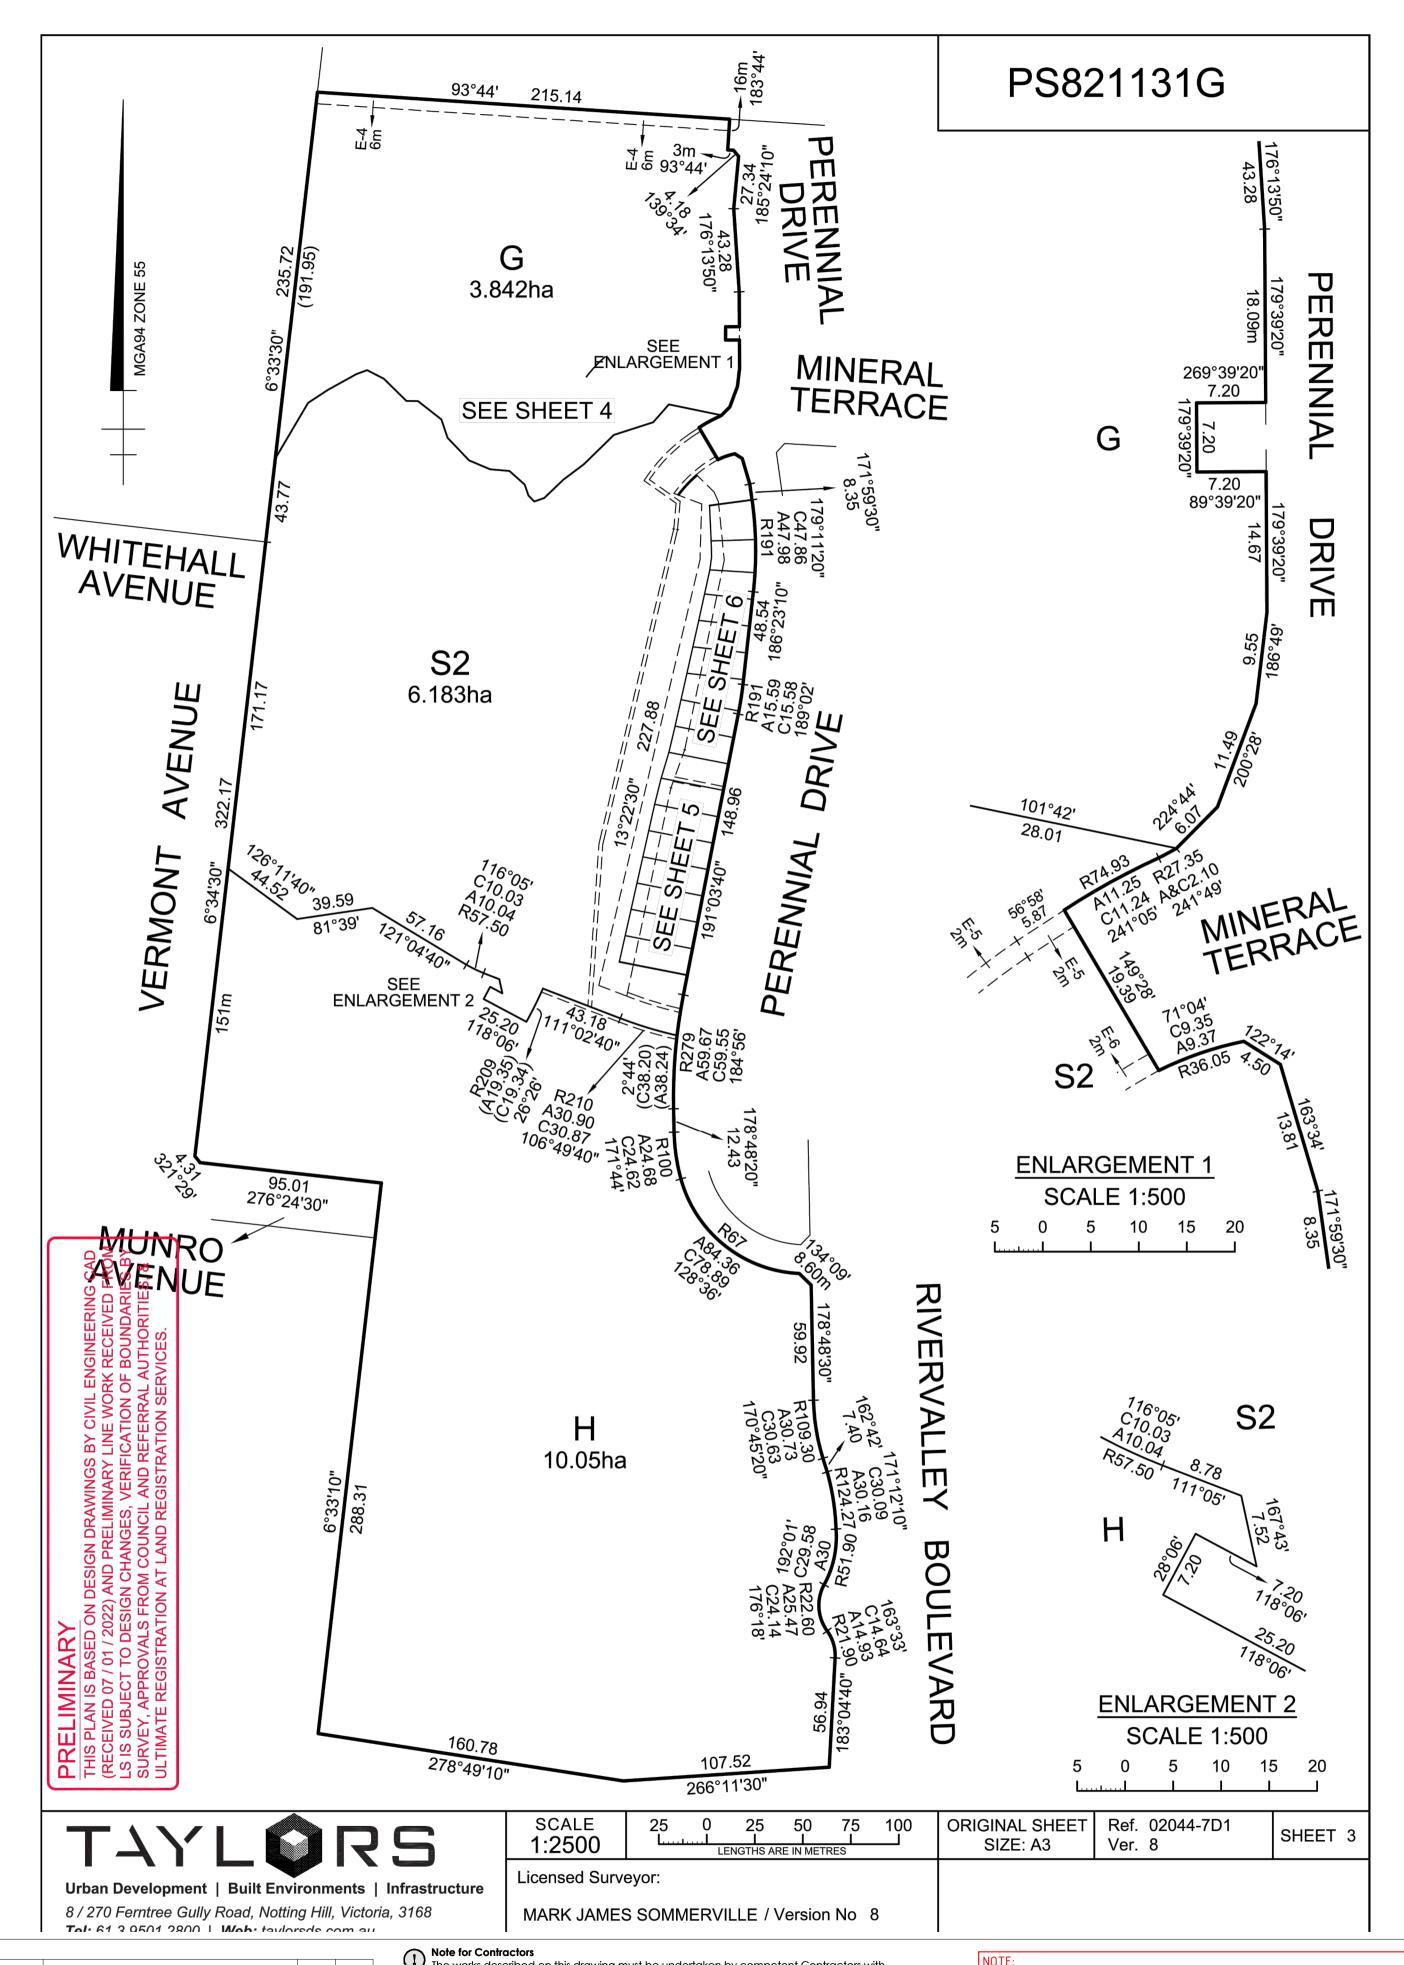



Project RIVER VALLEY - STAGE 7D1 Client YOURLAND Drawing Title SUB-DIVISION PLANS (SHEET 1 OF 4)


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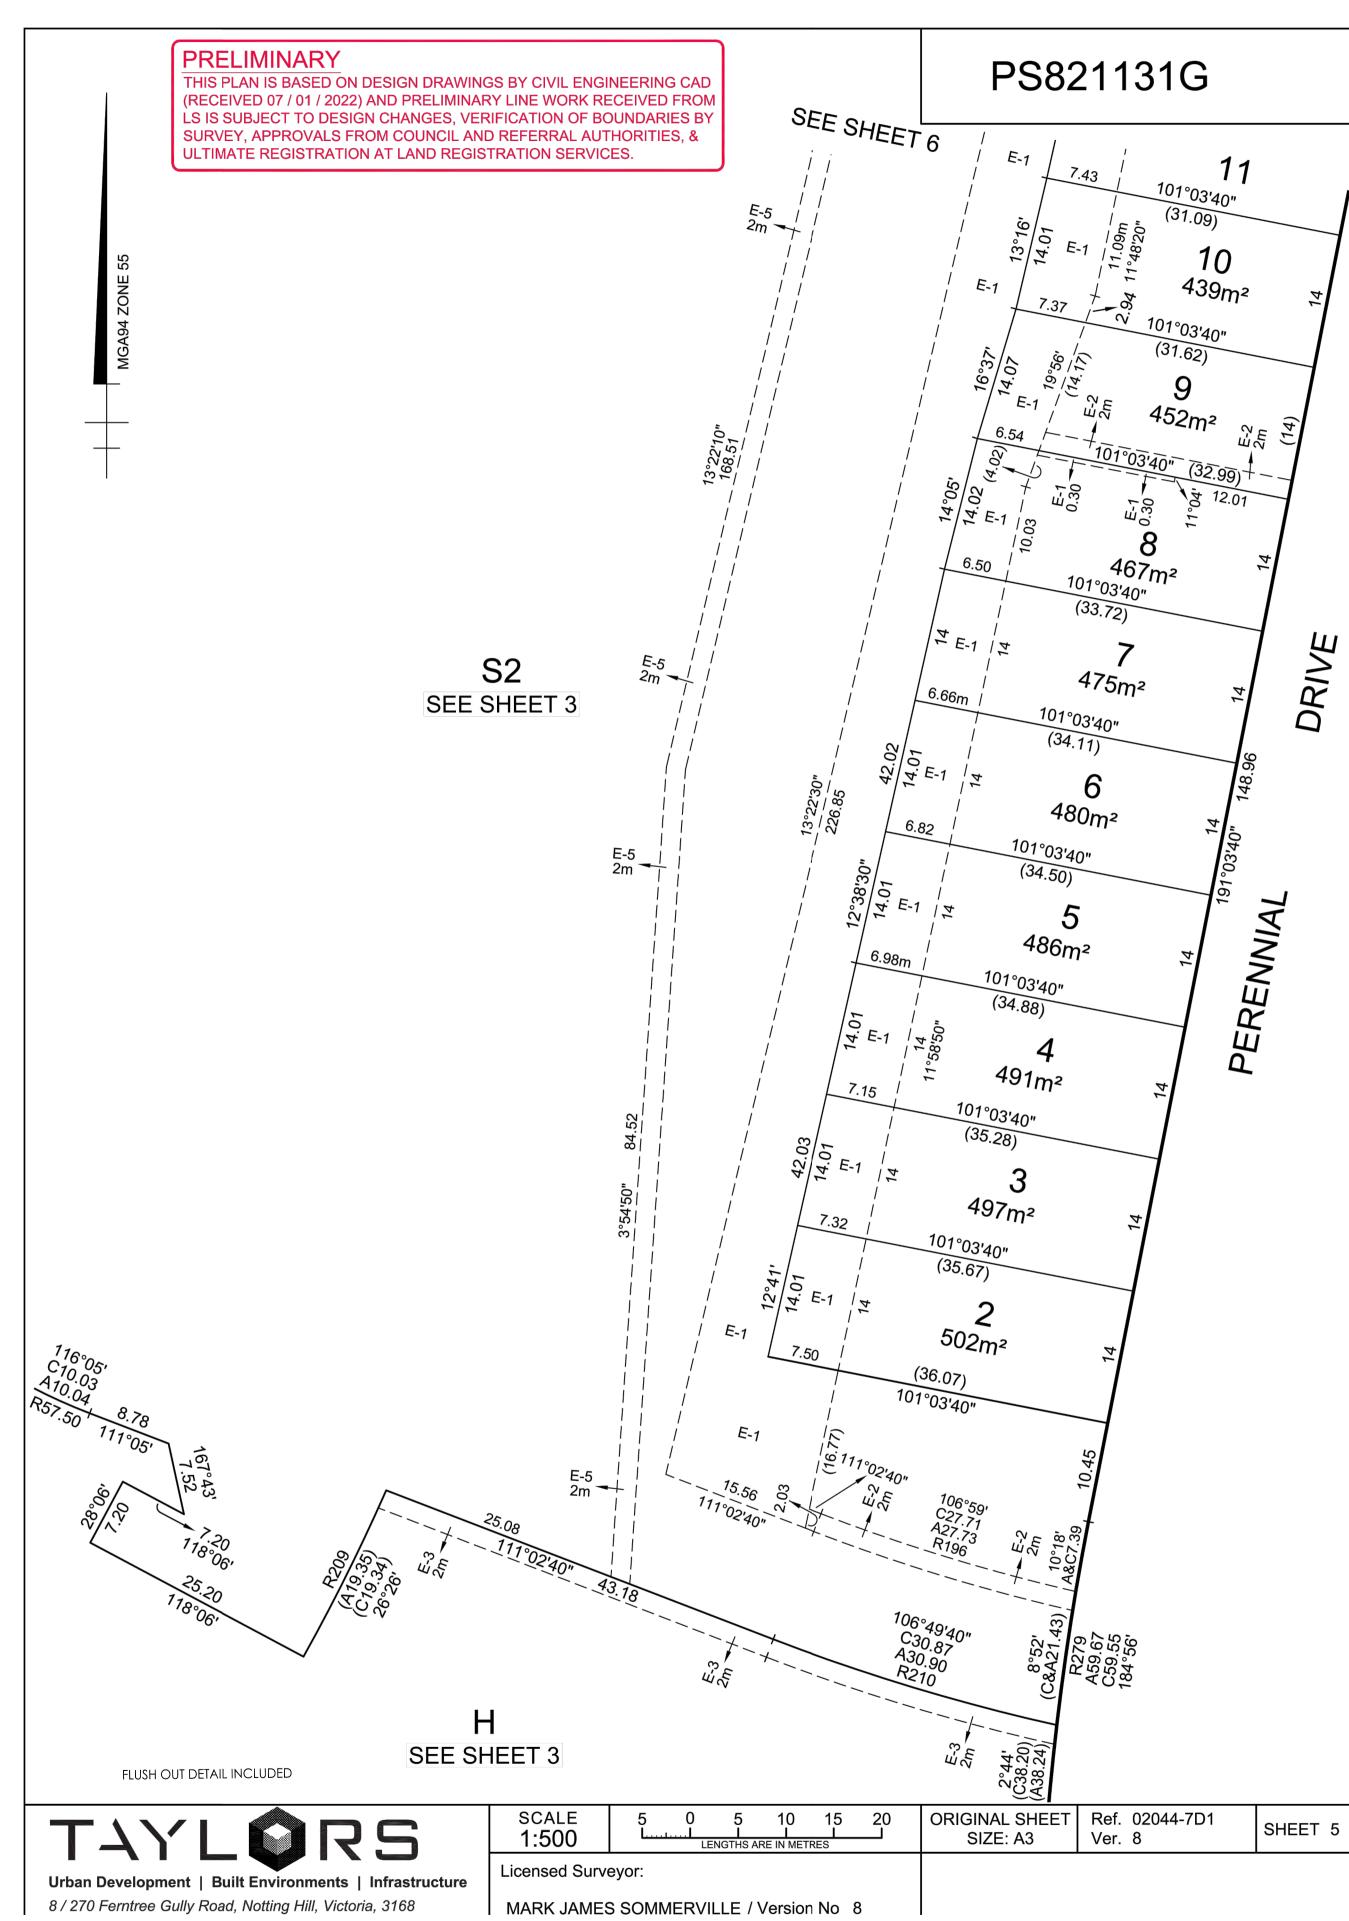





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Drawing Title
SUB-DIVISION PLANS (SHEET 2 OF 4) YOURLAND ISSUED FOR CONSTRUCTION 15006 CJA 00 DWG 9201



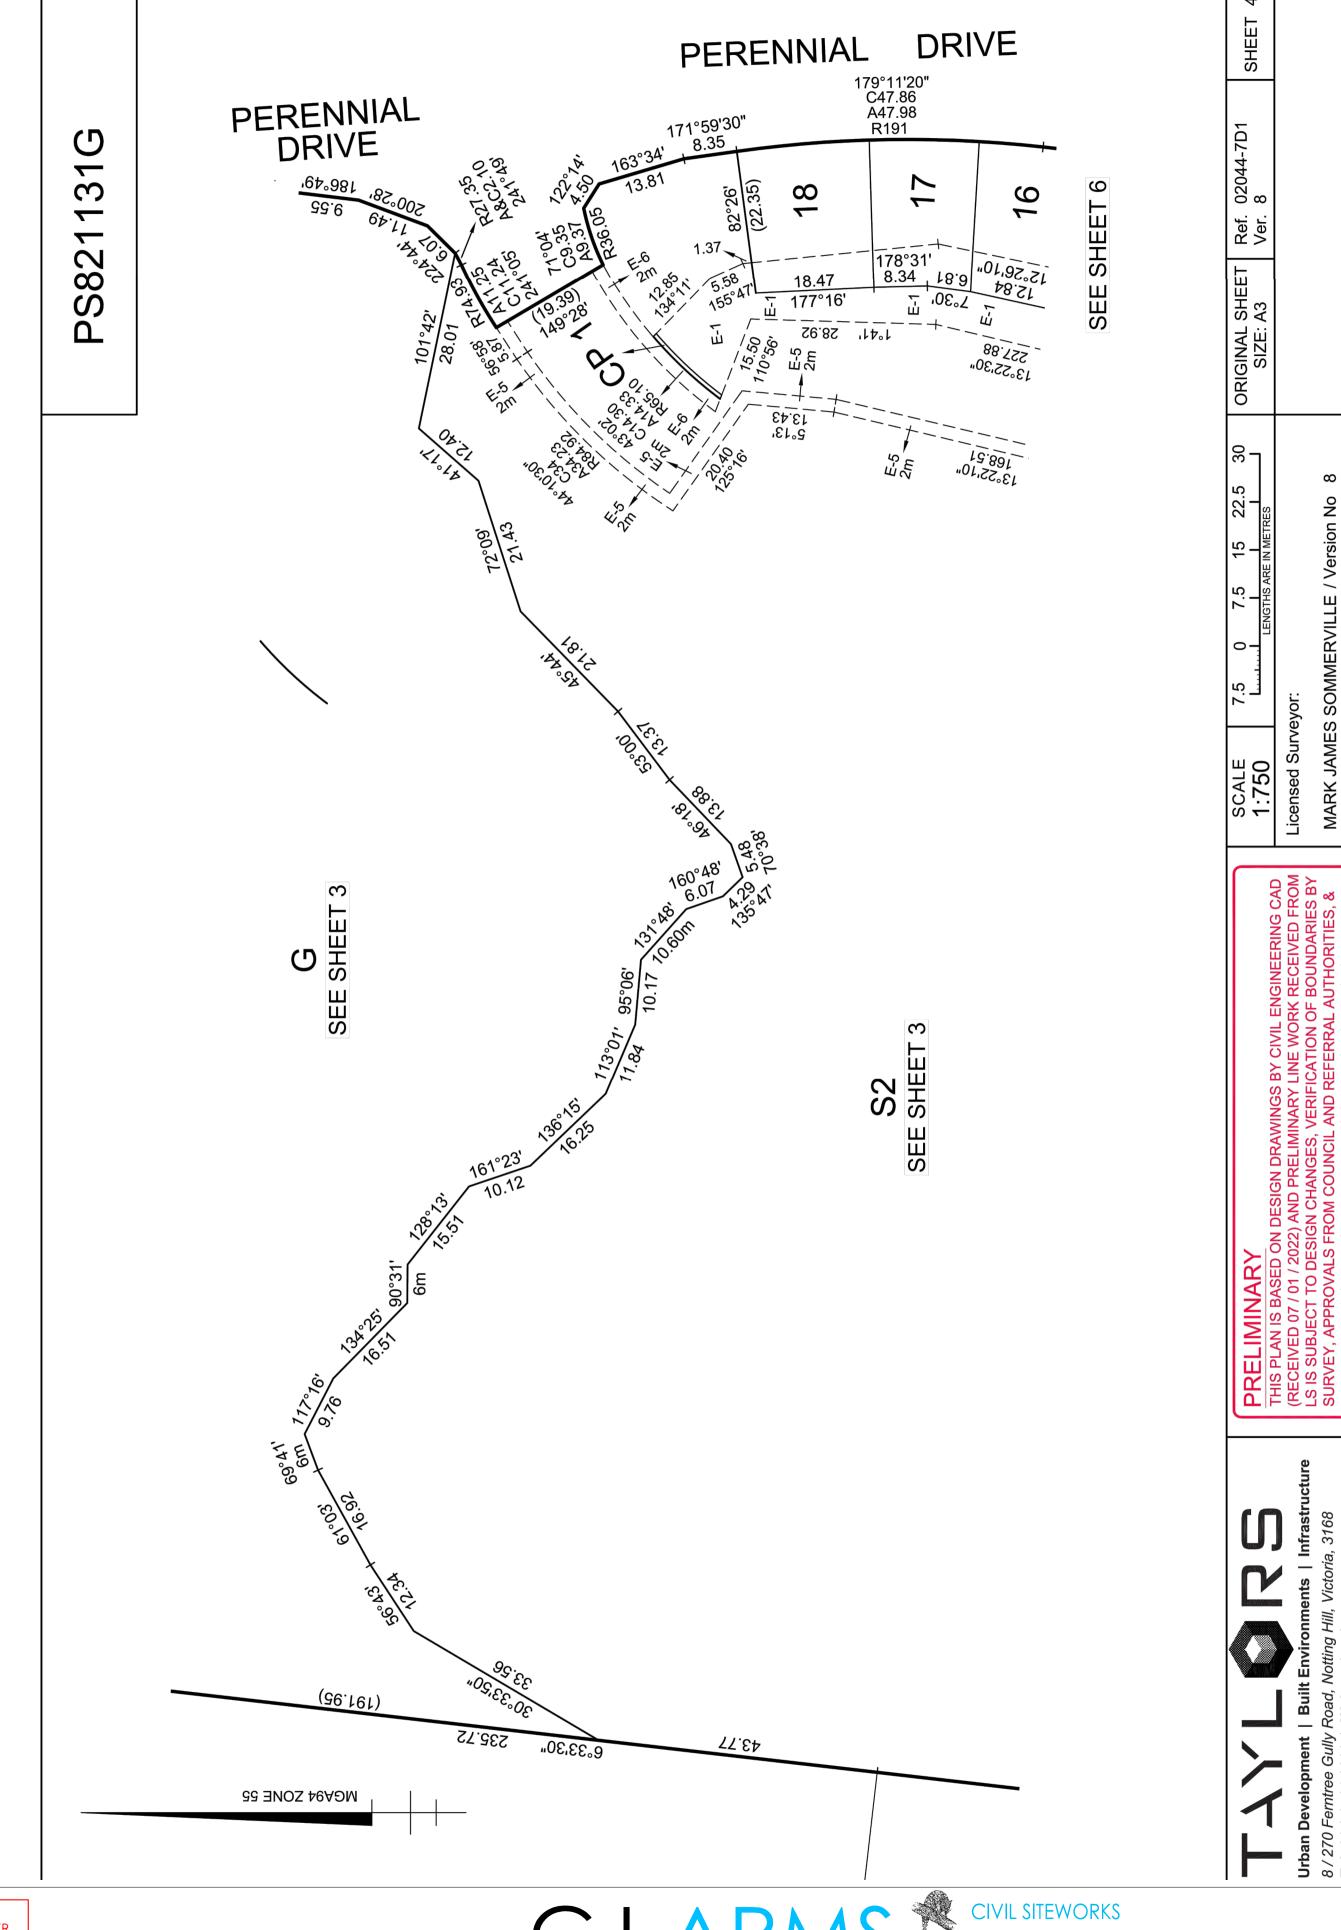
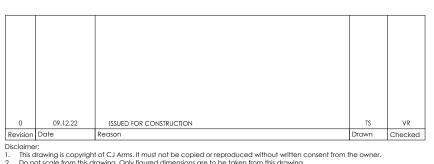
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**CIVIL SITEWORKS** 

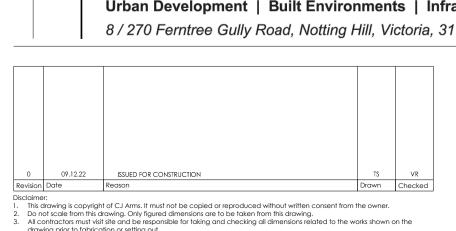SIZE: A3

ORIGINAL SHEET | Ref. 02044-7D1

Ver. 8

T: (03) 9285 2800 | E:info@cjarms.com | W:www.cjarms.com SUB-DIVISION PLANS RIVER VALLEY - STAGE 7D1 (SHEET 3 OF 4) YOURLAND ISSUED FOR CONSTRUCTION 15006 CJA DWG 9202

SHEET 6

PS821131G

18 175°06' A20.76 175°06' A20.76 174°16' A20.76

88°13'

374m<sup>2</sup>

16 326m²

Q

PERENNIAL

96°23'10"

362m²

96°23'10"

383m²

96°23'10"

(28.09)

12

463<sub>m²</sub>

96°23'10" (29.63)

101°03'40"

436m²

101°03'40"

13

6.49

6.65

6.82

7.03

ISSUED FOR CONSTRUCTION

SEE SHEET 5

1:500

Licensed Surveyor:

**PRELIMINARY** 

THIS PLAN IS BASED ON DESIGN DRAWINGS BY CIVIL ENGINEERING CAD

(RECEIVED 07 / 01 / 2022) AND PRELIMINARY LINE WORK RECEIVED FROM

LS IS SUBJECT TO DESIGN CHANGES, VERIFICATION OF BOUNDARIES BY

SURVEY, APPROVALS FROM COUNCIL AND REFERRAL AUTHORITIES, &

JLTIMATE REGISTRATION AT LAND REGISTRATION SERVICES.

S2

SEE SHEET 3

# PS821131G

### CREATION OF RESTRICTION A

The registered proprietors of the burdened land covenant with the registered proprietors of the benefited land as set out in the restriction with the intent that the burden of the restriction runs with and binds the burdened land and the benefit of the restriction is annexed to and runs with the benefited land.

BURDENED LAND: See Table 1 BENEFITED LAND: See Table 1

#### RESTRICTION:

- The burdened land cannot be used except in accordance with the provisions recorded in MCP.
- The registered proprietor or proprietors for the time being of any burdened lot to which this restriction applies must not at any time on the said lot or any part or parts thereof build or cause to be built or allow to remain a dwelling or any other improvements, or carry out or cause to be carried out or allow to be carried out, any building or construction works on the lot unless:
  - a. Copies of site plans, floor plans, elevations, landscape plans, and schedule of materials and colours selections with samples (together the "Plans") have been submitted to the River Valley Design Assessment Panel at River Valley Estate Pty Ltd 21 Balmain Street Richmond VIC 3121, or such other entity as may be nominated by the Vendor from time to time for approval (such approval which may be withheld or provided with conditions in the River Valley Design Assessment Panel's absolute discretion);
  - b. The Plans comply with the River Valley Design Guidelines; and
  - c. The River Valley Design Assessment Panel or such other entity as may be nominated by the Vendor from time to time has given its written approval to the Plans prior to the commencement of works.

Expiry date: 31/12/2032

## CREATION OF RESTRICTION B

The registered proprietors of the burdened land covenant with the registered proprietors of the benefited land as set out in the restriction with the intent that the burden of the restriction runs with and binds the burdened land and the benefit of the restriction is annexed to and runs with the benefited land.

BURDENED LAND: See Table 1 BENEFITED LAND: See Table 1

#### RESTRICTION:

The registered proprietor or proprietors for the time being of any burdened lot on this plan must not construct or allow to be constructed or remain on the lot any building or garage outside the building envelope shown hatched in the diagrams shown on MCP ...... (excluding allowable projecting building elements that project outside the building envelope as contained in Part 5 Regulation 74(3), 79(3) & 79(4) of the Building Regulations 2018).

BURDENED LOT No.	BENEFITING LOTS ON THIS PLAN
2	3
3	2, 4
4	3, 5
5	4, 6
6	5, 7
7	6, 8
8	7, 9
9	8, 10
10	9, 11

TABLE 1 continued

BURDENED LOT No.	BENEFITING LOTS ON THIS PLAN
11	10, 12
12	11, 13
13	12, 14
14	13, 15
15	14, 16
16	15, 17
17	16, 18
18	17

#### **PRELIMINARY**

9.12.22 ISSUED FOR CONSTRUCTION ate Reason

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8 / 270 Ferntree Gully Road, Notting Hill, Victoria, 3168

SCALE	O LL L L L L LENGTHS ARE IN METRES	ORIGINAL SHEET SIZE: A3	Ref. 02044-7D1 Ver. 8	SHEET 7
Licensed Surveyor:				

**Tel:** 61 3 9501 2800 | **Web:** taylorsds.com.au

The works described on this drawing must be undertaken by competent Contractors with an appropriate level of experience who have prepared appropriate Safe Work Method Statements (SWMS) relating to these works. The contractor is responsible for the management of all risks associated with the construction activities stated on this

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# ISSUED FOR CONSTRUCTION

# PS821131G

# CREATION OF RESTRICTION C

The registered proprietors of the burdened land covenant with the registered proprietors of the benefited land as set out in the restriction with the intent that the burden of the restriction runs with and binds the burdened land and the benefit of the restriction is annexed to and runs with the benefited land.

BURDENED LAND: Lot 2 to 18 (both inclusive) BENEFITED LAND: Lot 2 to 18 (both inclusive)

#### **RESTRICTION:**

The registered proprietor or proprietors for the time being of any burdened lot on this plan must not undertake or permit to undertake, any excavation, construction of buildings or works, tree planting, landscaping or any other physical alterations to the structure of the rock down slope within that part of the burdened lot marked E-1, without prior written consent from Owners' Corporation PS821131G.

# PRELIMINARY

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Licensed Surveyor:

LENGTHS ARE IN METRES

SIZE: A3

ORIGINAL SHEET | Ref. 02044-7D1

SHEET 8

Yourland CJ ARMS





RIVER VALLEY - STAGE 7D1

SUB-DIVISION PLANS SHEET 4 OF 4

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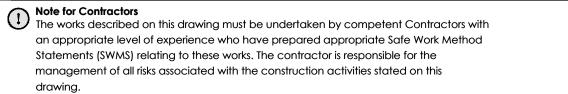


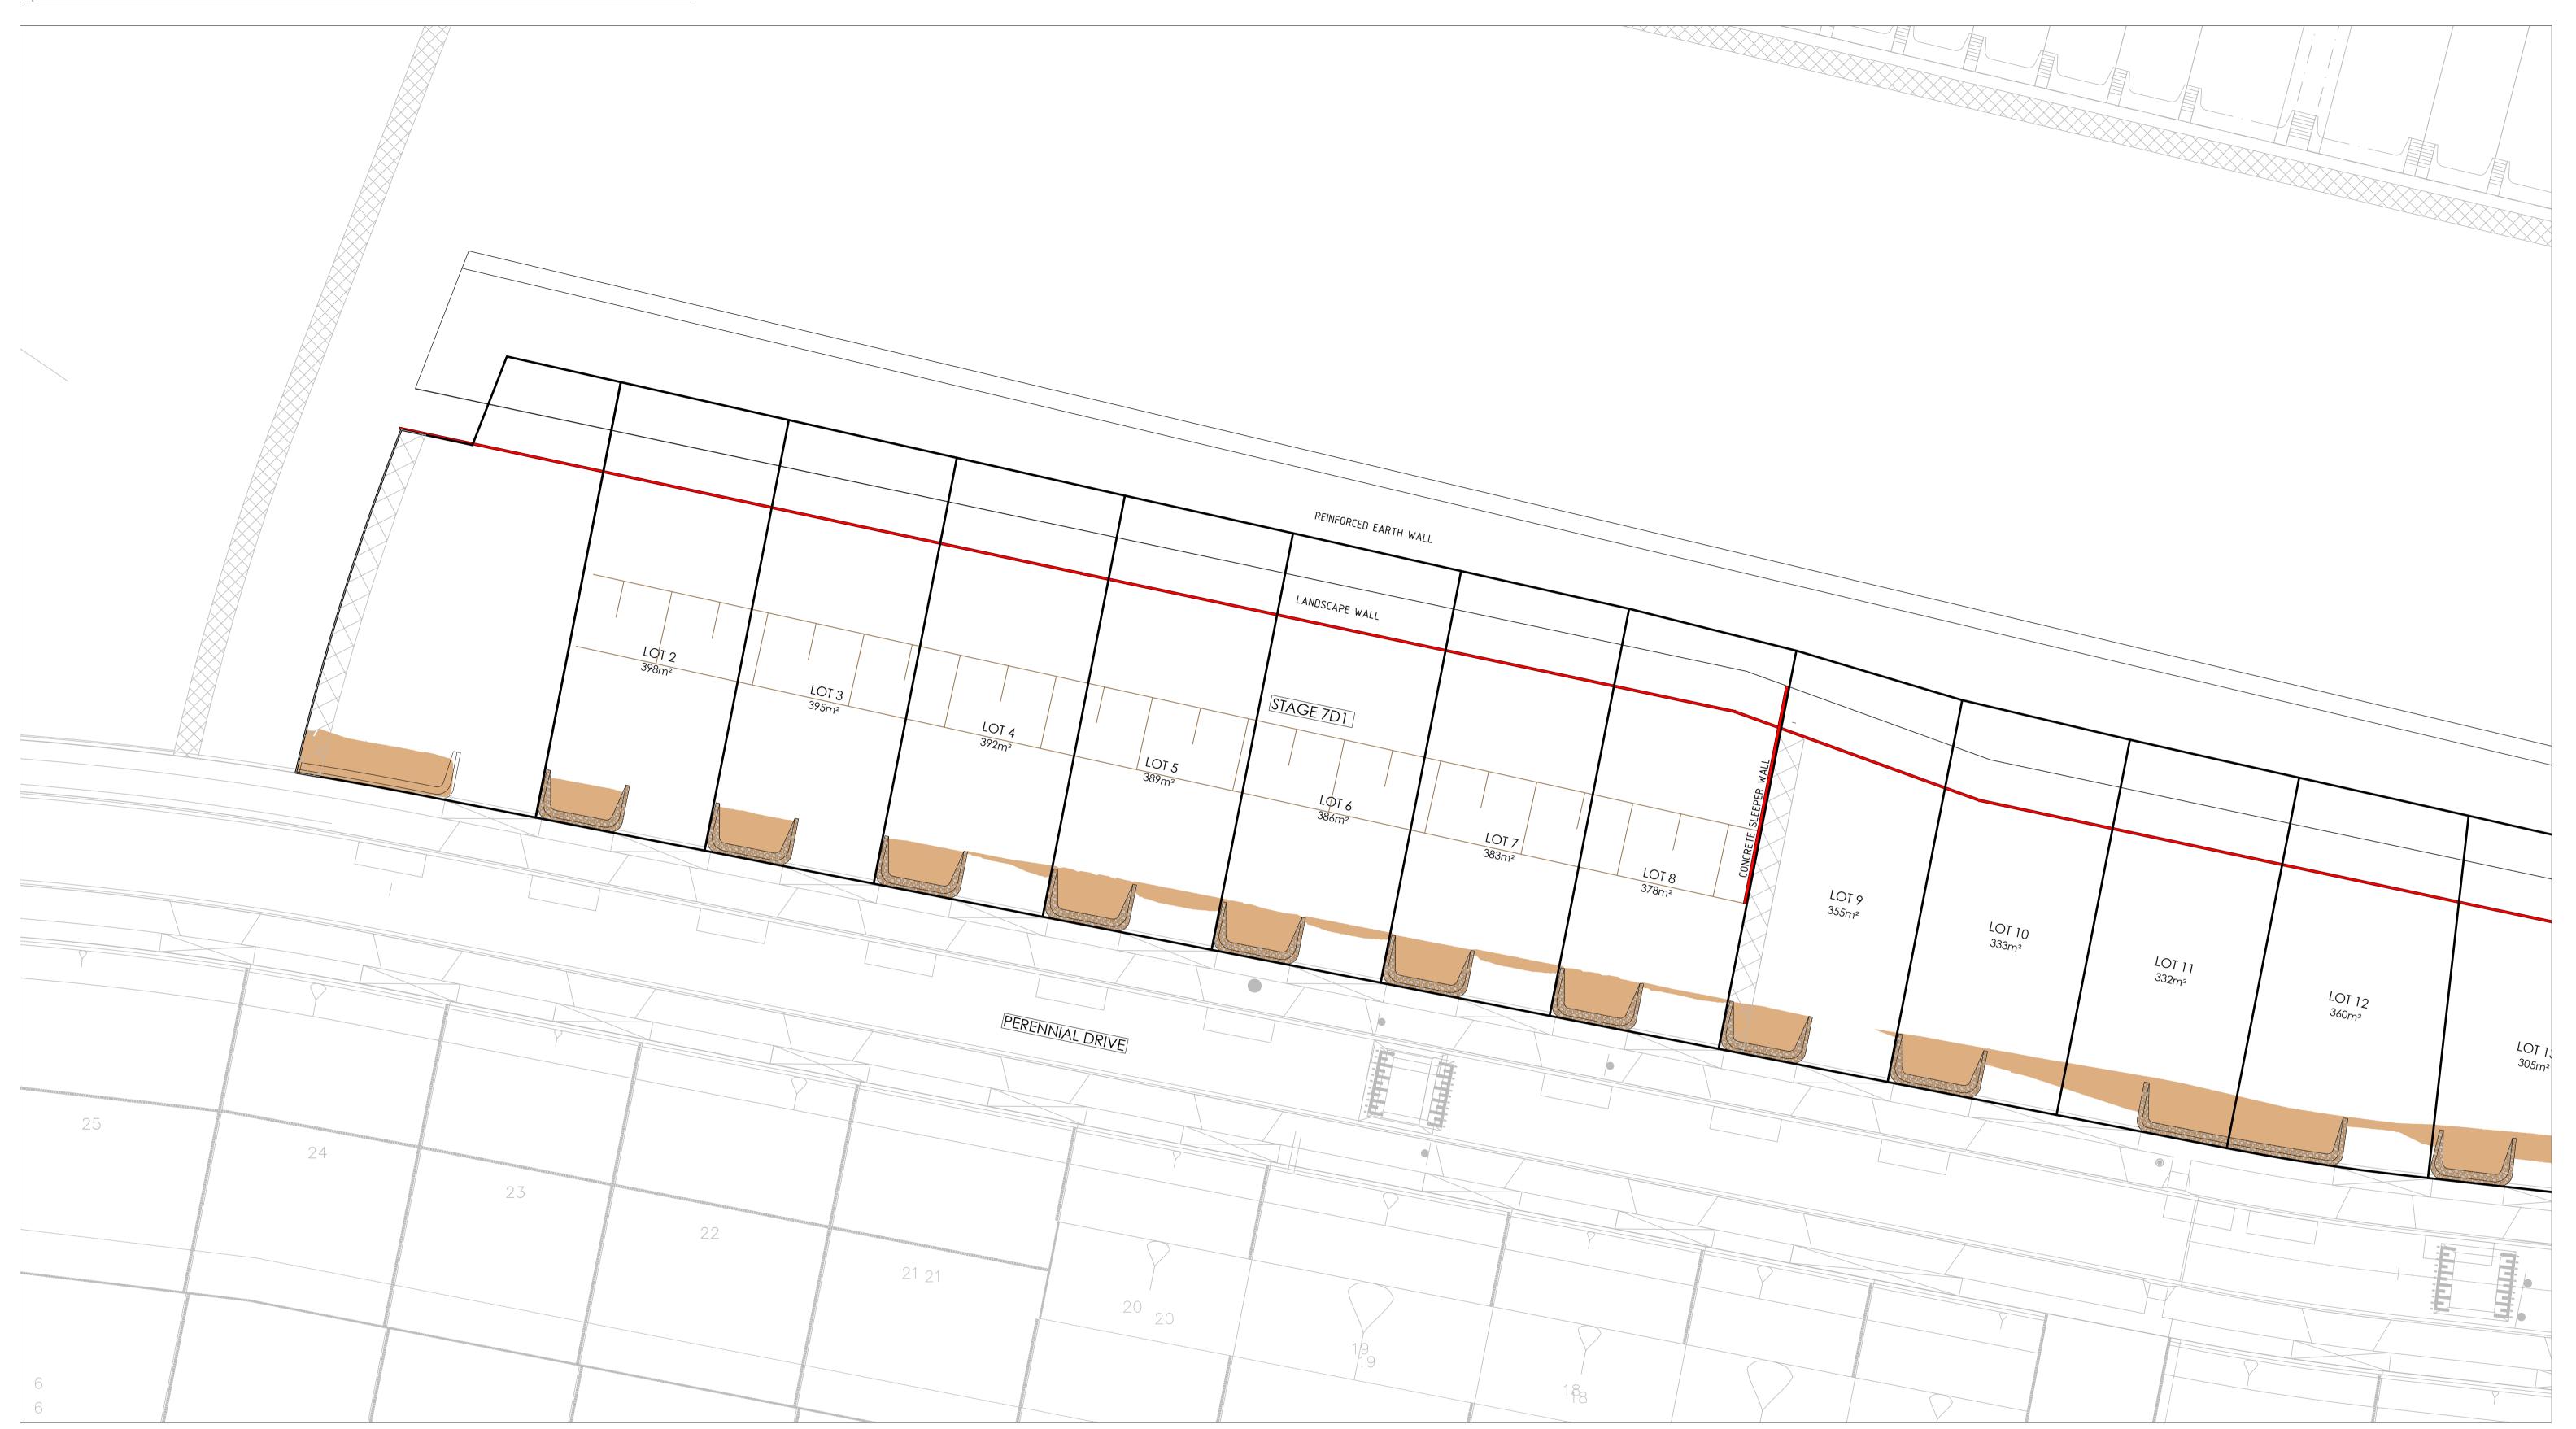

0 09.12.22 ISSUED FOR CONSTRUCTION
Revision Date Reason
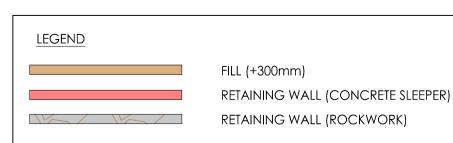
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- THIS PLAN DOES NOT DETAIL ANY OTHER FILL MATERIAL THAT MAY HAVE BEEN PLACED WITHIN THE SUBDIVISION PRIOR TO THE CIVIL WORKS BEING UNDERTAKEN.
- IRRESPECTIVE OF THE DEPTH OF FILL DETAILED ON THIS PLAN, FOUNDATIONS MUST BE DESIGNED AND CONSTRUCTED IN ACCORDANCE WITH BUILDING REGULATIONS AND WILL TAKE INTO ACCOUNT THE SOIL CLASSIFICATION AND SOIL REPORT PREPARED FOR
- EACH INDIVIDUAL LOT. THE EXTENT AND DEPTH OF FILL SHOWN ON THIS PLAN WILL BE CONFIRMED ON-SITE BY A
  GEOTECHNICAL INVESTIGATION BY A REGISTERED AND EXPERIENCED GEOTECHNCIAL ENGINEER
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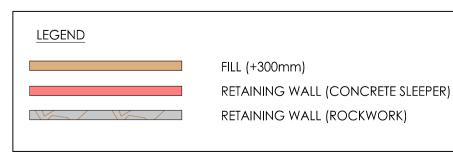




Project RIVER VALLEY - STAGE 7D1 Drawing Title
FILL LAYOUT PLAN (SHEET 1 OF 2) Client YOURLAND ISSUED FOR CONSTRUCTION 15006 CJA 7D1 00 DWG

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- ENGINEER
  - Note for Contractors

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FILL LAYOUT PLAN (SHEET 2 OF 2) Client YOURLAND ISSUED FOR CONSTRUCTION 1:250 @ A1 09.12.22 00 15006 CJA 7D1 DWG

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