# RIVER VALLEY - STAGE 7C

RIVER VALLEY BLVD, SUNSHINE NORTH, VIC

# CIVIL SITEWORKS


# ROADS & DRAINAGE PACKAGE





## LOCATION PLAN (N.T.S)

	DRAWING SCHEDULE
SHEET NUMBER	SHEET TITLE
15019-CJA-7C-00-DR-C-0000	COVER SHEET & DRAWING SCHEDULE
15019-CJA-7C-00-DR-C-0001	CIVIL NOTES SHEET
15019-CJA-7C-00-DR-C-0100	EXISTING CONDITIONS PLAN
15019-CJA-7C-00-DR-C-1000	OVERALL LAYOUT PLAN
15019-CJA-7C-00-DR-C-1100	DETAILED LAYOUT PLAN (SHEET 1 OF 2)
15019-CJA-7C-00-DR-C-1101	DETAILED LAYOUT PLAN (SHEET 2 OF 2)
15019-CJA-7C-00-DR-C-2001	TYPICAL SECTIONS - ROAD RESERVE (SHEET 1 of 2)
15019-CJA-7C-00-DR-C-2002	TYPICAL SECTIONS - ROAD RESERVE (SHEET 2 of 2)
15019-CJA-7C-00-DR-C-2100	TYPICAL SECTIONS - SITE SECTIONS (SHEET 1 OF 2)
15019-CJA-7C-00-DR-C-2101	TYPICAL SECTIONS - SITE SECTIONS (SHEET 2 OF 2)
15019-CJA-7C-00-DR-C-4000	LONG SECTION & SET OUT - ROCK RETAINING WALL
15019-CJA-7C-00-DR-C-4001	LONG SECTION & SET OUT - LANDSCAPE RETAINING WALL
15019-CJA-7C-00-DR-C-4002	LONG SECTION & SET OUT - CONC SLEEPER WALL A& B
15019-CJA-7C-00-DR-C-4003	LONG SECTION & SET OUT - CONC SLEEPER WALL C
15019-CJA-7C-00-DR-C-5000	LONG SECTION - RIVER VALLEY BLVD
15019-CJA-7C-00-DR-C-5001	LONG SECTION - PERENNIAL DRIVE
15019-CJA-7V-00-DR-C-5002	LONG SECTION - SHARED FOOTPATH
15019-CJA-7C-00-DR-C-5100	CROSS SECTIONS - RIVER VALLEY BLVD (SHEET 1 OF 9)
15019-CJA-7C-00-DR-C-5101	CROSS SECTIONS - RIVER VALLEY BLVD (SHEET 2 OF 9)
15019-CJA-7C-00-DR-C-5102	CROSS SECTIONS - RIVER VALLEY BLVD (SHEET 3 OF 9)
15019-CJA-7C-00-DR-C-5103	CROSS SECTIONS - RIVER VALLEY BLVD (SHEET 4 OF 9)
15019-CJA-7C-00-DR-C-5104	CROSS SECTIONS - RIVER VALLEY BLVD (SHEET 5 OF 9)
15019-CJA-7C-00-DR-C-5105	CROSS SECTIONS - RIVER VALLEY BLVD (SHEET 6 OF 9)
15016-CJA-7C-00-DR-C-5106	CROSS SECTIONS - RIVER VALLEY BLVD (SHEET 7 OF 9)
15019-CJA-7C-00-DR-C-5107	CROSS SECTIONS - RIVER VALLEY BLVD (SHEET 8 OF 9)
15019-CJA-7C-00-DR-C-5108	CROSS SECTIONS - RIVER VALLEY BLVD (SHEET 9 OF 9)
15019-CJA-7C-00-DR-C-5150	CROSS SECTIONS - PERENNIAL DRIVE (SHEET 1 OF 8)
15019-CJA-7C-00-DR-C-5151	CROSS SECTIONS - PERENNIAL DRIVE (SHEET 2 OF 8)
15017-CJA-7C-00-DR-C-5151	CROSS SECTIONS - PERENNIAL DRIVE (SHEET 3 OF 8)
15019-CJA-7C-00-DR-C-5153	CROSS SECTIONS - PERENNIAL DRIVE (SHEET 4 OF 8)
15019-CJA-7 C-00-DR-C-5153 15019-CJA-7 C-00-DR-C-5154	CROSS SECTIONS - PERENNIAL DRIVE (SHEET 5 OF 8)
15019-CJA-7C-00-DR-C-5155	CROSS SECTIONS - PERENNIAL DRIVE (SHEET 6 OF 8)
15019-CJA-7C-00-DR-C-5156	CROSS SECTIONS - PERENNIAL DRIVE (SHEET 7 OF 8)
15019-CJA-7C-00-DR-C-5158 15019-CJA-7C-00-DR-C-5157	CROSS SECTIONS - PERENNIAL DRIVE (SHEET 8 OF 8)
15019-CJA-7C-00-DR-C-5197 15019-CJA-7C-00-DR-C-5200	DETAILS & SET OUT - TEMP TURNING HEAD 1
15019-CJA-7 C-00-DR-C-5201	DETAILS & SET OUT - TEMP TURNING HEAD 2
15019-CJA-7C-00-DR-C-5202	CONSTRUCTION SET OUT - ROUNDABOUT
15019-CJA-7C-00-DR-C-6100	STORMWATER - LONG SECTION (SHEET 1 OF 3)
15019-CJA-7C-00-DR-C-6101	STORMWATER - LONG SECTION (SHEET 2 OF 3)
	STORMWATER - LONG SECTION (SHEET 3 OF 3)
15019-CJA-7C-00-DR-C-6102	· · · · · · · · · · · · · · · · · · ·
15019-CJA-7C-00-DR-C-6103	STORMWATER PIPE BEDDING DETAILS  STORMWATER - OUTFALL SAG PIT DETAIL
15019-CJA-7C-00-DR-C-6200	
15019-CJA-7C-00-DR-C-6210	STORMWATER - OUTFALL CONNECTION DETAIL (SHEET 1 OF 2)  STORMWATER - OUTFALL CONNECTION DETAIL (SHEET 2 OF 2)
15019-CJA-7C-00-DR-C-6211	·
15019-CJA-7C-00-DR-C-8000	CONSTRUCTION DETAILS - PAVEMENT & KERBS
15019-CJA-7C-XX-00-DR-8005	CONSTRUCTION DETAILS - FENCING
15019-CJA-7C-00-DR-C-8010	CONSTRUCTION DETAILS - RAINGARDENS - (SHEET 1 OF 2)
15019-CJA-7C-00-DR-C-8011	CONSTRUCTION DETAILS - RAINGARDENS - (SHEET 2 OF 2)
15019-CJA-7C-00-DR-C-8020	CONSTRUCTION DETAILS - RETAINING WALLS - (SHEET 1 OF 3)
15019-CJA-7C-00-DR-C-8021	CONSTRUCTION DETAILS - RETAINING WALLS - (SHEET 2 OF 3)
15019-CJA-7C-00-DR-C-8022	CONSTRUCTION DETAILS - RETAINING WALLS - (SHEET 3 OF 3)
15019-CJA-7C-00-DR-C-8100	CONSTRUCTION SETOUT - HV KIOSK
15019-CJA-7C-00-DR-C-8500	SIGNAGE AND LINEMARKING PLAN
15019-CJA-7C-00-DR-C-9200	SUB-DIVISION PLANS (SHEET 1 OF 4)
15019-CJA-7C-00-DR-C-9201	SUB-DIVISION PLANS (SHEET 2 OF 4)
15019-CJA-7C-00-DR-C-9202	SUB-DIVISION PLANS (SHEET 3 OF 4)
15019-CJA-7C-00-DR-C-9203	SUB-DIVISION PLANS (SHEET 4 OF 4)
15019-CJA-7C-00-DR-C-9900	FILL LAYOUT PLAN
15019-CJA-7C-00-DR-C-9995	SERVICES AND STREETSCAPE CO-ORDINATION
15019-CJA-7C-00-DR-C-9999	INTERIM CONDITIONAL APPROVAL LAYOUT PLAN

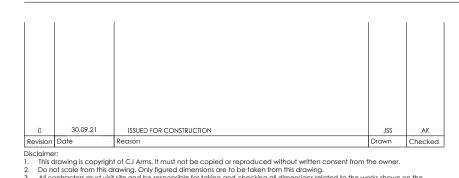

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COVER SHEET & DRAWING SCHEDULE YOURLAND ISSUED FOR CONSTRUCTION

### GENERAL BRIMBANK CITY COUNCIL NOTES

- 1. ALL WORKS TO BE CARRIED OUT IN ACCORDANCE WITH CITY OF BRIMBANK STANDARD SPECIFICATION, ENGINEERING GUIDELINES AND SPECIFICATIONS FOR THE DESIGN & CONSTRUCTION OF ROADS & DRAINAGE WORKS, STANDARD DRAWINGS AND TO THE SATISFACTION OF THE SURVEILLANCE COORDINATOR OR THEIR REPRESENTATIVE.
- 2. ALL TREES AND SHRUBS TO BE RETAINED UNLESS PRIOR APPROVAL HAS BEEN OBTAINED FROM THE RELEVANT AUTHORITY OR REMOVAL IS DIRECTED BY THE AUTHORISED ENGINEER.
- WHERE WORKS ARE IN THE VICINITY OF EXISTING SERVICES, THESE SERVICES ARE TO BE LOCATED PRIOR TO THE COMMENCEMENT OF WORKS
- 4. ALL VEHICLE CROSSINGS, DRAINAGE PITS, PRAM RAMPS, BOLLARDS etc SHALL BE CONSTRUCTED AS PER COUNCILS STANDARD DRAWINGS UNLESS OTHERWISE
- COUNCIL'S SURVEILLANCE COORDINATOR MUST BE NOTIFIED IN WRITING, NO LESS THAN SEVEN (7) DAYS PRIOR TO THE COMMENCEMENTS OF WORKS.
- 6. SUBMIT APPLICATION FOR TEMPORARY ACCESS TO SITE FOR APPROVAL BY COUNCIL'S SURVEILLANCE COORDINATOR BEFORE ANY COMMENCEMENT OF ANY WORKS COMMENCING.
- 7. CONTRACTORS ARE RESPONSIBLE WITH RESPECT TO SAFETY OF WORK ON SITE AND APPROPRIATE LEGISLATION.
- 8. FOOTPATHS ARE TO BE OFFSET 25mm FROM THE PROPERTY LINE AND
- CONSTRUCTED AS PER BRIMBANK STANDARD DRAWING \$350.
- VICROAD'S 'ROADWORK SIGNAGE CODE OF PRACTICE' WHICH COMPLIES WITH AUSTRALIAN STANDARDS 1742.3-1996 IS TO BE ADHERED TO DURING CONSTRUCTION WORKS (OR ANY SUBSEQUENT LATER REVISION)
- 10. WHERE DRAINAGE PIPES ARE LOCATED WITHIN NATURE STRIPS, THE TRENCH SHALL BE BACKFILLED WITH COMPACTED 20MM CLASS 3 CRUSHED ROCK UP TO A LEVEL WHERE THE 45DEG. INFLUENCE LINE FROM THE B.O.K. INTERSECTS WITH THE NEAREST
- 11. ALL CONCRETE DRAIN PIPES TO BE CLASS 4 SPIGOT & SOCKET WITH RUBBER RING
- UNLESS OTHERWISE SPECIFIED. 12. CCTV AND LASER PROFILING OF COMPLETED DRAINS SHALL BE UNDERTAKEN BY THE CONTRACTOR AS PER WSA 05-2008 VER2.2 AND SUBMIT TO COUNCIL PRIOR TO PRACTICAL COMPLETION OR STATEMENT OF COMPLIANCE WHICHEVER IS EARLIER
- 13. SERVICE CONDUITS ARE TO BE PROVIDED UNDER FOOTPATHS EXTENDING INTO ALLOTMENTS - LOCATION TO BE MARKED ON THE FOOTPATH AND KERB.
- 14. AG DRAINS TO BE PROVIDED BEHIND ALL KERBS AT INTERFACE OF EXISTING AND NEW PAVEMENT AND SHOULD HAVE SUITABLE OUTLET. REFER TO COUNCIL'S STANDARD DRAWING S110 FOR BACKFILL MATERIAL ETC. SOME WORKS MAY REQUIRE SPECIAL CONSIDERATION EG. VICROADS STANDARDS.
- 15. CONDUITS ARE TO BE CLEARLY MARKED ON THE KERB AND FOOTPATH FOR EASY IDENTIFICATION
- 16. ALL SERVICING TRENCHES UNDER ROAD CARRIAGEWAYS, FOOTPATHS, VEHICLE CROSSINGS AND OTHER STRUCTURES ARE TO BE BACKFILLED WITH 20mm CLASS 3 CRUSHED ROCK IN ACCORDANCE WITH SECTION 706 OF COUNCIL'S STANDARD SPECIFICATION FOR ROADS AND DRAINAGE WORKS IN LAND DEVELOPMENT.
- 17. ALL SERVICES MUST BE CONSTRUCTED PRIOR TO THE CONSTRUCTION OF THE KERB AND CHANNEL
- 18. TMP TO BE SUBMITTED TO COUNCIL'S SURVEILLANCE AND/OR TRAFFIC & TRANSPORT SECTION 7 DAYS PRIOR TO COMMENCEMENT OF WORKS FOR ACCEPTANCE.
- 19. STREET LIGHTING SHALL BE LED 18W FOR STANDARD FITTING AND LED 16W TOORAK/TOORAK ALPHA FOR DECORATIVE NON-STANDARD FITTING.
- 20. THE DRAWINGS, "MUST NOT BE SCALED/MEASURED' FROM HARD OR DIGITAL
- 21. MINIMUM EARTHWORKS FILLING REQUIREMENTS FOR ALL ROAD WORKS: a. ROAD FILLING WORKS SHALL BE IN ACCORDANCE WITH SECTION 204 OF COUNCIL'S STANDARD SPECIFICATION FOR ROADS AND DRAINAGE WORKS IN
- LAND DEVELOPMENT. b. TYPE A FILL IS REQUIRED FOR THE LAST 200mm LAYER UNDER ROAD PAVEMENTS, FOOTPATHS, VEHICLE CROSSINGS, NATURE STRIPS AND OTHER ROAD STRUCTURES.
- c. TYPE A MATERIAL IS SPECIFIED IN SECTION 204 OF COUNCIL'S STANDARD SPECIFICATION FOR ROADS AND DRAINAGE WORKS IN LAND DEVELOPMENTS TO BE 3% CBR, MAXIMUM SWELL OF 2.5%, MAXIMUM PERMEABILITY OF 5 X 10-7 CM/SEC AND MAXIMUM BOULDER SIZE IS 75mm ROCK WITH NO OTHER GRADING REQUIREMENTS.
- d. NATURE STRIP WIDTHS SHALL BE FINISHED OFF WITH 200mm THICK TOP SOIL MATERIAL RECOVERED FROM STRIPPING PRIOR TO THE CONSTRUCTION OF EARTHWORKS OR OTHER IMPORTED TOPSOIL TO COMPLY WITH COUNCIL'S LANDSCAPE REQUIREMENTS - TO BE COMPLETED BY THE LANDSCAPING CONTRACTOR.
- 22. FILL MATERIAL TO BE IMPORTED TO SITE WILL BE SUBJECT TO THE FOLLOWING CONTROLS:
  - a. BORROW MATERIAL FOR FILLING WORKS IS TO BE SIGNED OFF BY A SUITABLY QUALIFIED INDEPENDENT ENVIRONMENTAL SCIENTIST TO BE CLEAN FILL TO MEET EPA DEFINITION. THE SCIENTIST MUST BE RECOGNISED BY THE EPA TO UNDERTAKE SUCH A JOB.
  - THE INDEPENDENT ENVIRONMENTAL SCIENTIST IS TO CERTIFY THAT THE SOURCE OF SOURCES TO BORROW MATERIAL TO MEET THE EPA DEFINITION OF CLEAN FILL SUITABLE FOR ROAD CONSTRUCTION. THE SCIENTIST IS TO OVERSEE ALL TESTINGS, FREQUENCY OF TESTINGS ETC. TO MEET EPA REQUIREMENTS FOR CLEAN FILL.
  - THE SCIENTIST IS TO ENSURE THAT ONLY THE CERTIFIED CLEAN FILL MATERIAL IS USED. TRANSPORTATION DOCKETS ARE TO BE ISSUED FOR EACH TRUCK LOAD. DATE AND TIME OF LOADING AND ARRIVAL ON SITE ARE TO BE
  - AT THE END OF BORROW FILLING, A REPORT IS TO BE SUBMITTED TO COUNCIL BY THE INDEPENDENT SCIENTIST DETAILING THE TESTINGS CARRIED OUT LEADING TO THE APPROVAL OF THE SOURCE OR SOURCES.
  - THE REPORT IS ALSO TO INCLUDE COPIES OF ALL THE TRANSPORTATION
  - DOCKETS AND SUMMARY OF THE REQUIRED BORROW VOLUME. IN THE REPORT, THE SCIENTIST IS TO SIGN OFF THE COMPLETED BORROW FILL WORKS FOR EPA REQUIREMENTS FOR CLEAN FILL WORKS.
  - b. BORROW MATERIAL FILLING WORKS IS TO BE SIGNED OFF BY A SUITABLY QUALIFIED INDEPENDENT (NATA REGISTERED COMPANY) GEOTECHNICAL ENGINEER TO BE TYPE B FILL TO MEET BCC SPECIFICATIONS FOR TYPE B FILL MATERIAL
  - THE GEOTECHNICAL ENGINEER IS TO APPROVE THE SOURCE OR SOURCES OF THE BORROW MATERIAL THAT MEETS TYPE B FILL (INCLUDING MINIMUM
  - THE GEOTECHNICAL ENGINEER IS TO CARRY OUT ALL THE TESTING AT THE SITE OR SOURCE(S) AS REQUIRED IN SECTION 204.
  - THE ENGINEER IS TO ENSURE THAT ONLY THE CERTIFIED TYPE B FILL MATERIAL IS USED. TRANSPORTATION DOCKETS ARE TO BE ISSUED FOR EACH TRUCK LOAD. DATE AND TIME OF LOADING AND ARRIVAL ON SITE ARE TO BE
  - AT THE COMPLETION OF THE FILLING WORKS, THE ENGINEER IS TO SUBMIT A SEPARATE REPORT TO COUNCIL TO VERIFY ALL BORROW MATERIAL FILLING WORKS MEET THE TYPE B SPECIFICATION.
  - IN THE REPORT, THE GEOTECHNICAL ENGINEER IS TO SIGN OFF THE COMPLETED BORROW FILL WORKS THAT MEET TYPE B SPECIFICATIONS.
  - C. PRIOR TO THE COMMENCEMENT OF THE BORROW MATERIAL FILLING, BOTH THE SCIENTIST AND THE GEOTECHNICAL ENGINEER ARE TO INFORM COUNCIL SURVEILLANCE OF THE APPROVED SOURCE OR SOURCES OF BORROW MATERIAL AND SUBMIT TESTING RESULTS VERIFYING THE ACCEPTANCE OF THE MATERIAL.

#### ADDITIONAL GENERAL NOTES

- 23. EARTHWORKS & SEDIMENTATION CONTROL
- a. ALL CONTROLS FOR EATHWORKS TO BE PROVIDED IN ACCORDANCE WITH THE ENDORSED
- SOIL AND FILL PLAN AND ENDORSED ECEMP. b. NO POLLUTED OR SEDIMENT LADEN RUNOFF IS TO BE DISCHARGED DIRECTLY OR
- INDIRECTLY INTO EXISTING DRAINAGE SYSTEM DURING OR AFTER THE WORKS. C. STOCKPILING OF MATERIAL IS TO BE PLACED AS DIRECTED BY THE SUPERINTENDENT. d. DISTURBED AREAS WITHIN DESIGNATED GRASSED FLOODWAY ZONES MUST BE TOPSOILED AND STABILISED IN ACCORDANCE WITH THE APPROVED LANDSCAPE PLANS - SCOPE TO BE
- COMPLETED BY LANDSCAPING CONTRACTOR. ALL LEVELS & SETOUT TO MGA55 AND AHD.
- 25. REQUIREMENTS PRIOR TO COMMENCEMENT OF CIVIL WORKS:
- a. A CONSTRUCTION ENVIRONMENTAL MANAGEMENT PLAN MUST BE SUBMITTED AND APPROVED BY BCC ENVIRONMENTAL TEAM AS PER PLANNING PERMIT CONDITION (PPC)
- b. PRIOR TO THE REMOVAL OF ANY NATIVE VEGETATION ASSOCIATED WITH THE OUTFALL DRAINAGE CONNECTION, CLEARANCE MUST BE OBTAINED FROM THE BCC ENVIRONMENTAL TEAM
- c. ASSET PROTECTION PERMIT MUST BE OBTAINED FROM BCC ENGINEERING DEPARTMENT 26. REQUIREMENTS DURING AND/OR AFTER CONSTRUCTION STAGES OF WORKS:
- a. CULTURAL HERITAGE INDUCTIONS SHALL BE COMPLETED IN ACCORDANCE WITH THE CHMP.
- b. PROVIDE ROAD SAFETY AUDIT (RSA) POST CONSTRUCTION. 27. AS PART OF THESE WORKS TONKIN AND TAYLORS EARTHWORKS SPECIFICATION WILL TAKE
- PRECEDENCE OVER BCC EARTHWORKS REQUIREMENTS. 28. PIPE BEDDING AND BACKFILL TO BE IN ACCORDANCE WITH BCC SPECIFICATION 701A.

### ADDITIONAL PLANNING PERMIT NOTES:

- 1. ABORIGINAL PROTECTION REQUIREMENTS MUST BE ADHERED TO AS PER PLANNING PERMIT
- CONDITIONS 12 AND 13. 2. ENVIRONMENTAL MANAGEMENT PLAN MUST BE SUBMITTED AND APPROVED AS PER
- CONDITION 5 AND 50.
- 3. PRIOR TO REMOVAL OF ANY VEGETATION, THE OFFSET OF NATIVE VEGETATION MUST BE SECURED FROM THE ENVIRONMENT TEAMS PER PLANNING PERMIT CONDITION 29 AND 30.

BRIMBANK CITY COUNCIL Engineering Services APPROVED PLANS AND SPECIFICATIONS Vikramt 01 Oct 2021



sclaimer:
This drawing is copyright of CJ Arms. It must not be copied or reproduced without written consent from the owner.
Do not scale from this drawing. Only figured dimensions are to be taken from this drawing.

All contractors must visit site and be responsible for taking and checking all dimensions related to the works shown on the drawing prior to fabrication or setting out.

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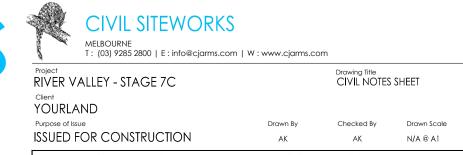
Dial before you dig. BEWARE OF UNDERGROUND SERVICES. The location of underground services are approximate only and their exact position should be proven on site. No guarantee is given that existing services are shown.

ISSUED FOR CONSTRUCTION









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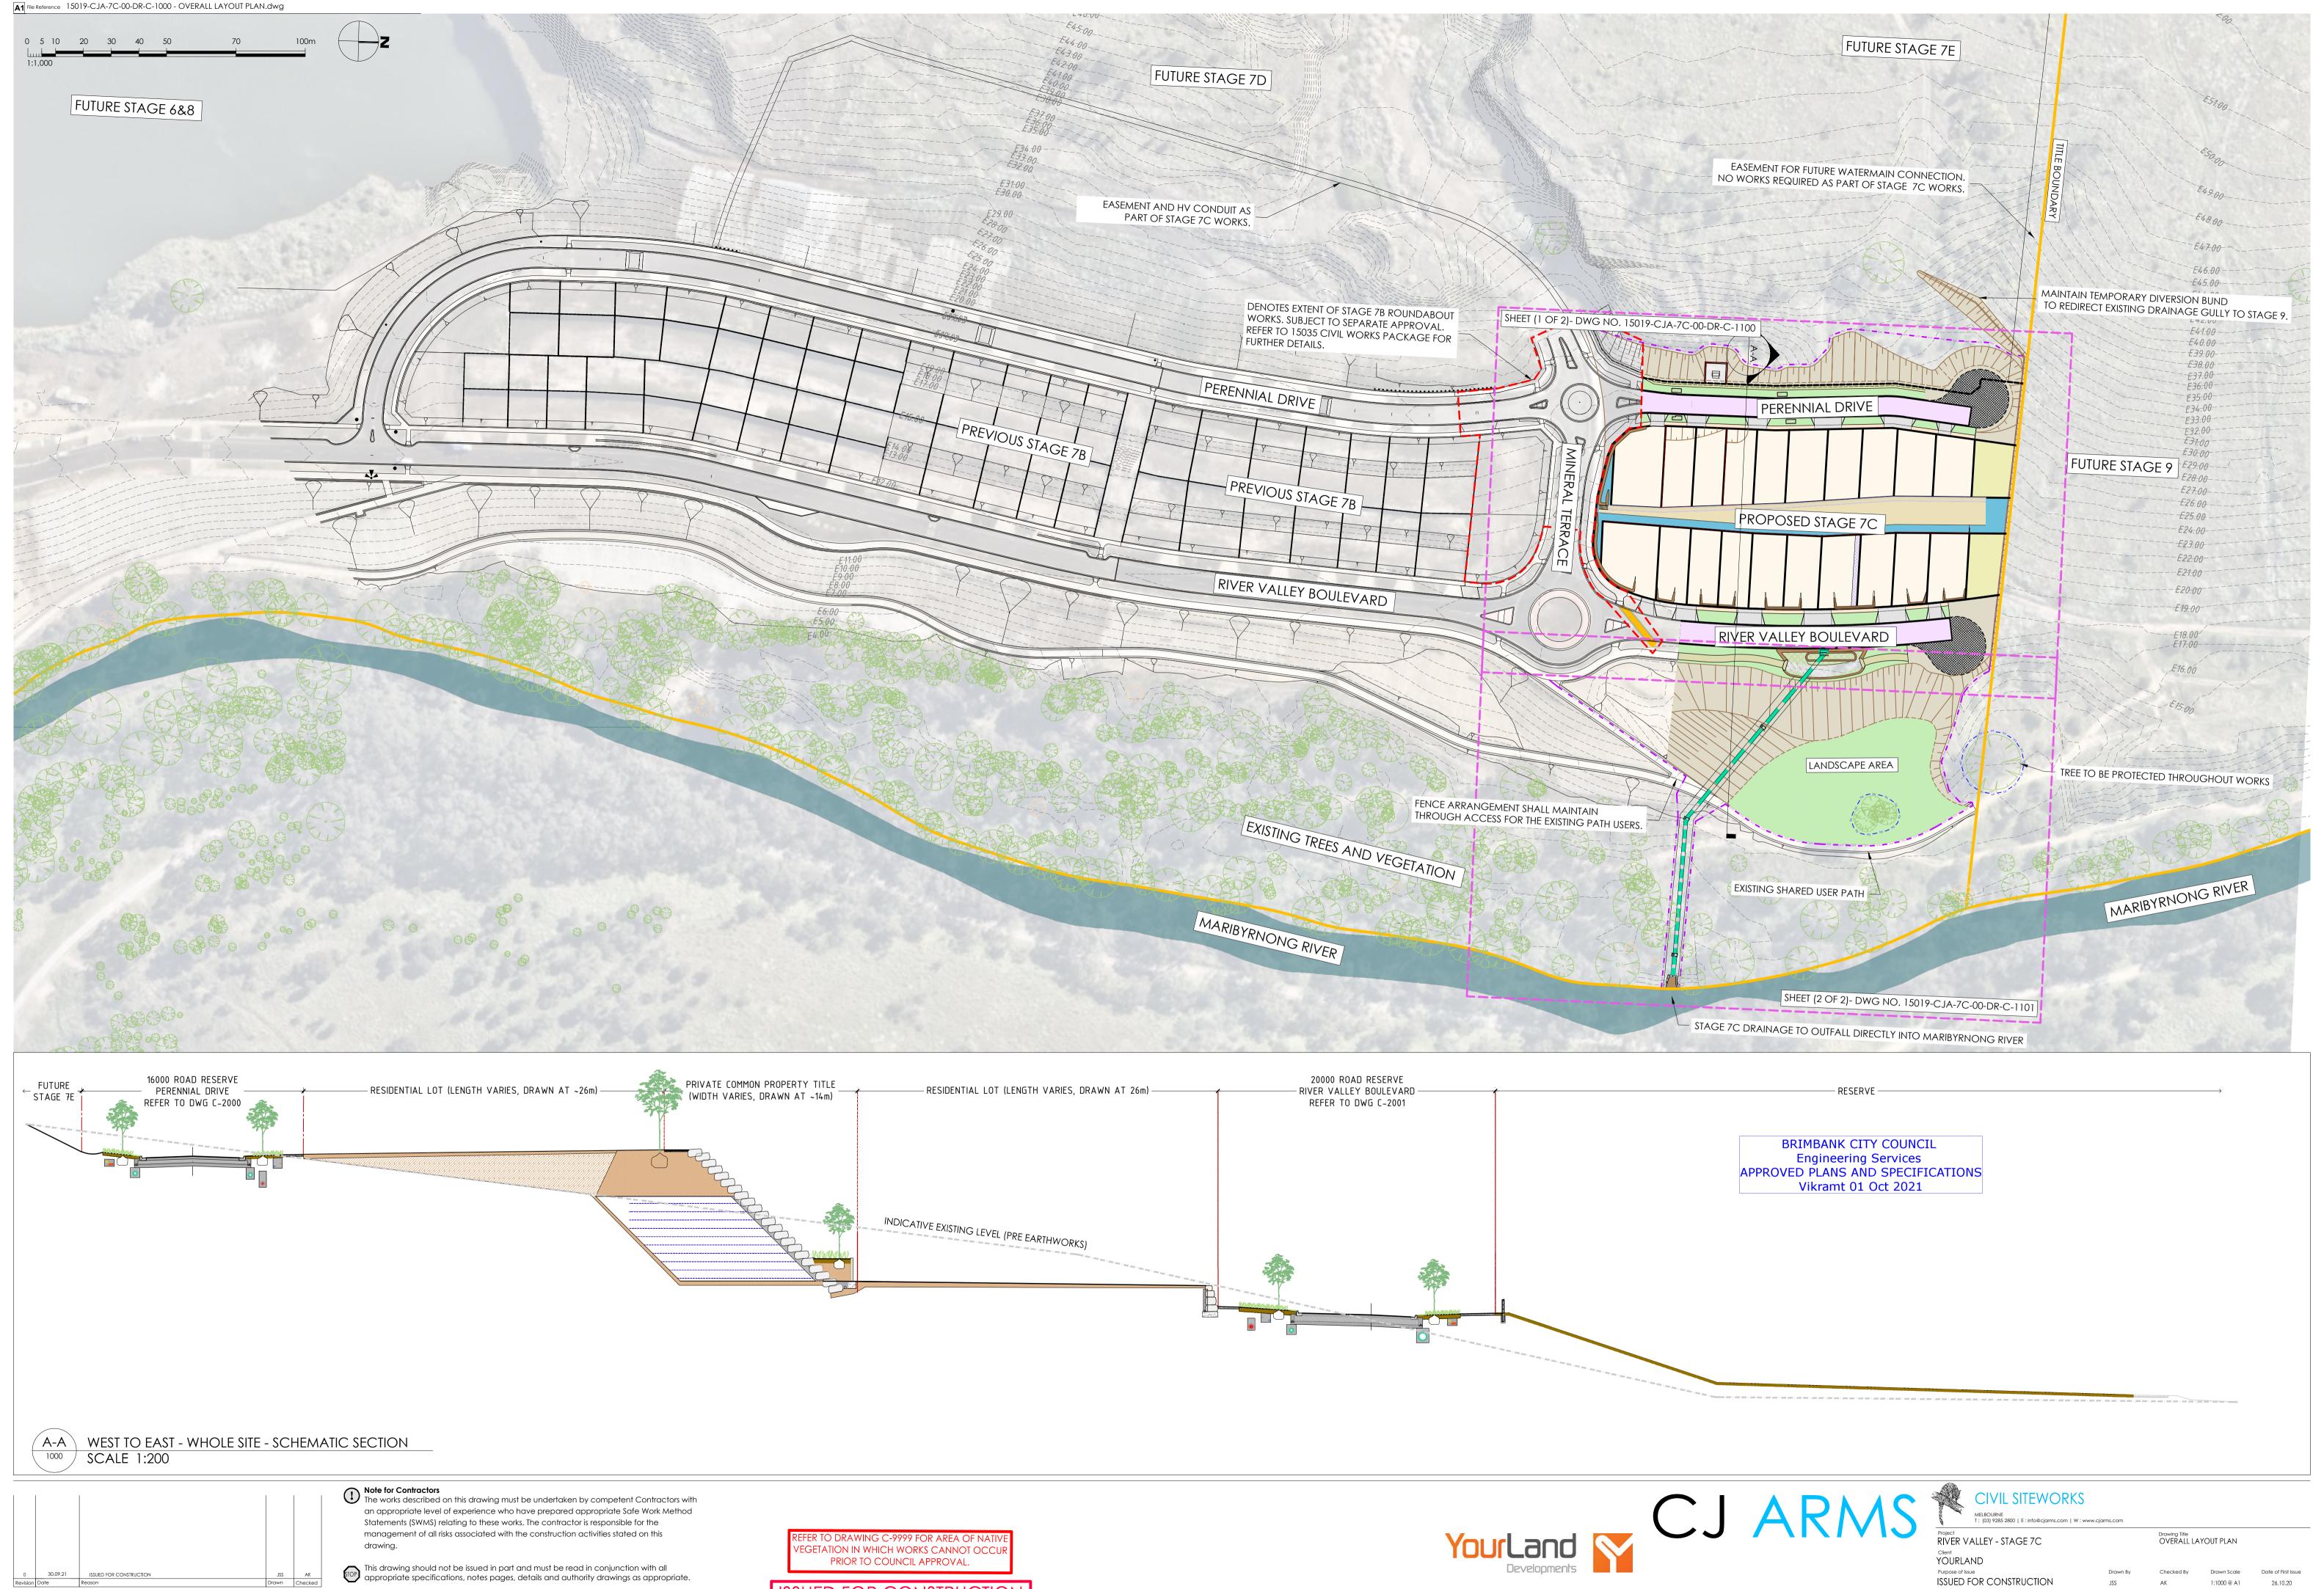
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15019 CJA 7C

26.10.20



Dial before you dig. BEWARE OF UNDERGROUND SERVICES. The location of underground services are approximate only and their exact position should be proven on site. No


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15019 CJA 7C


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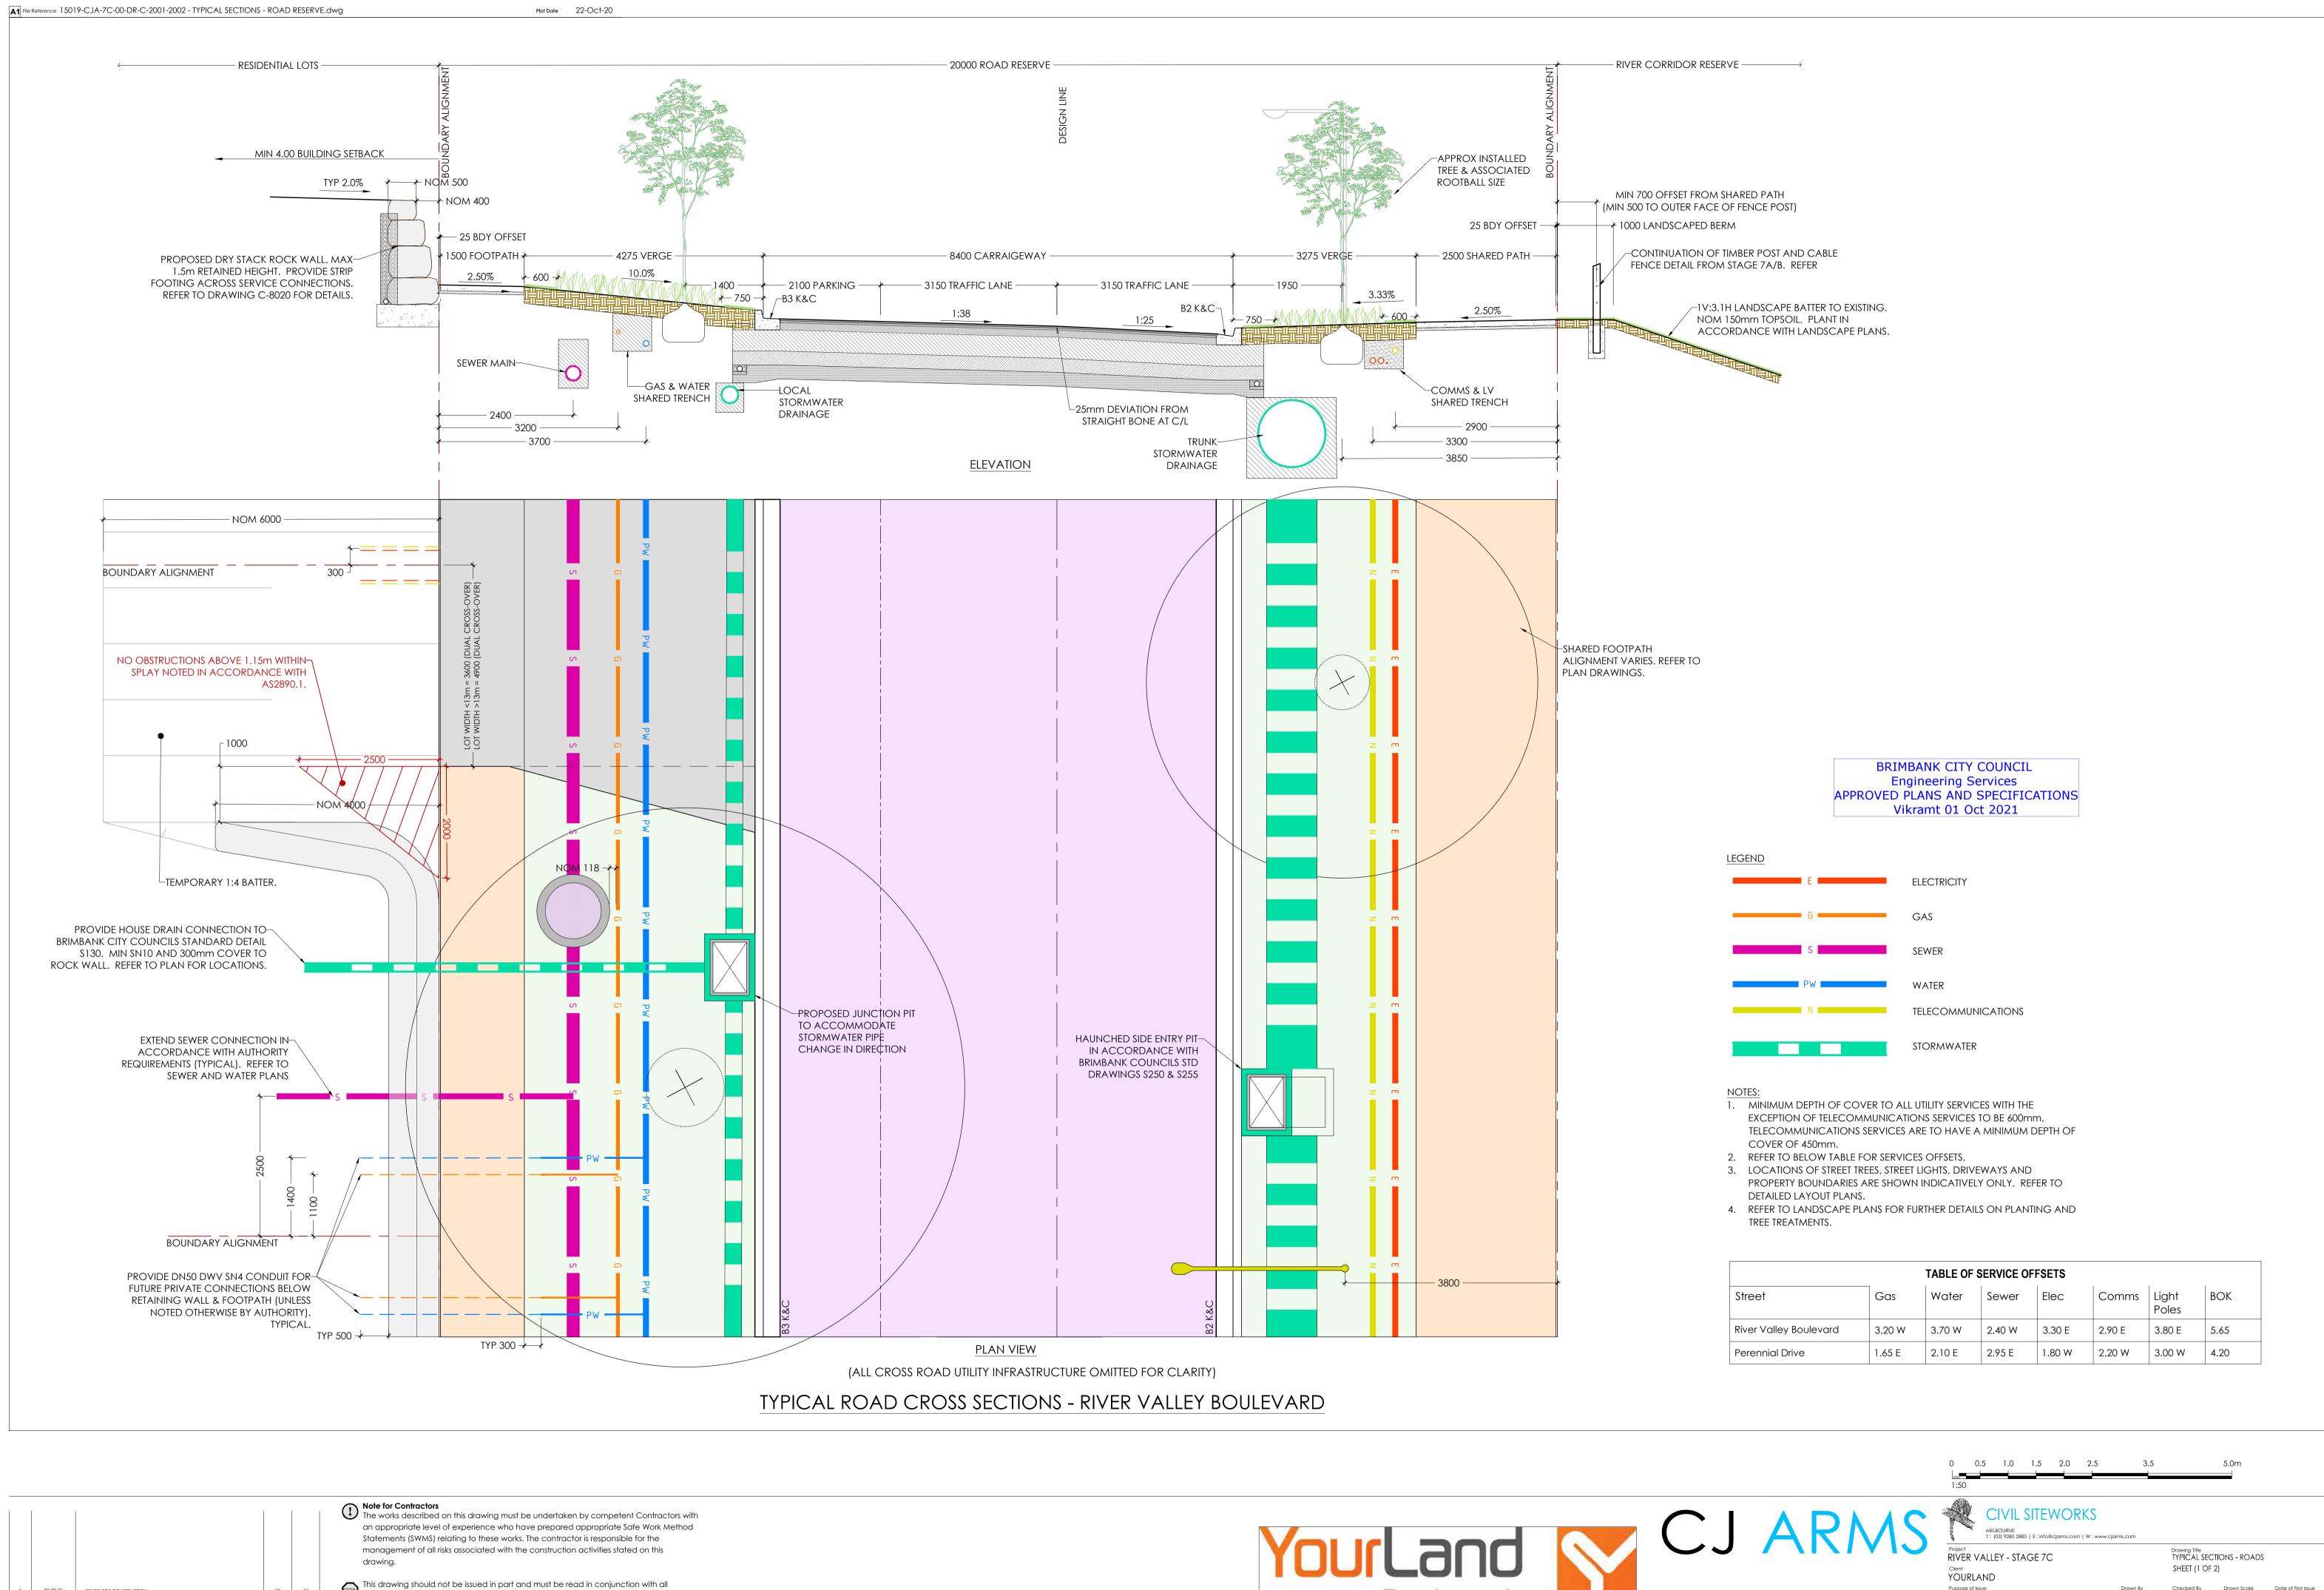
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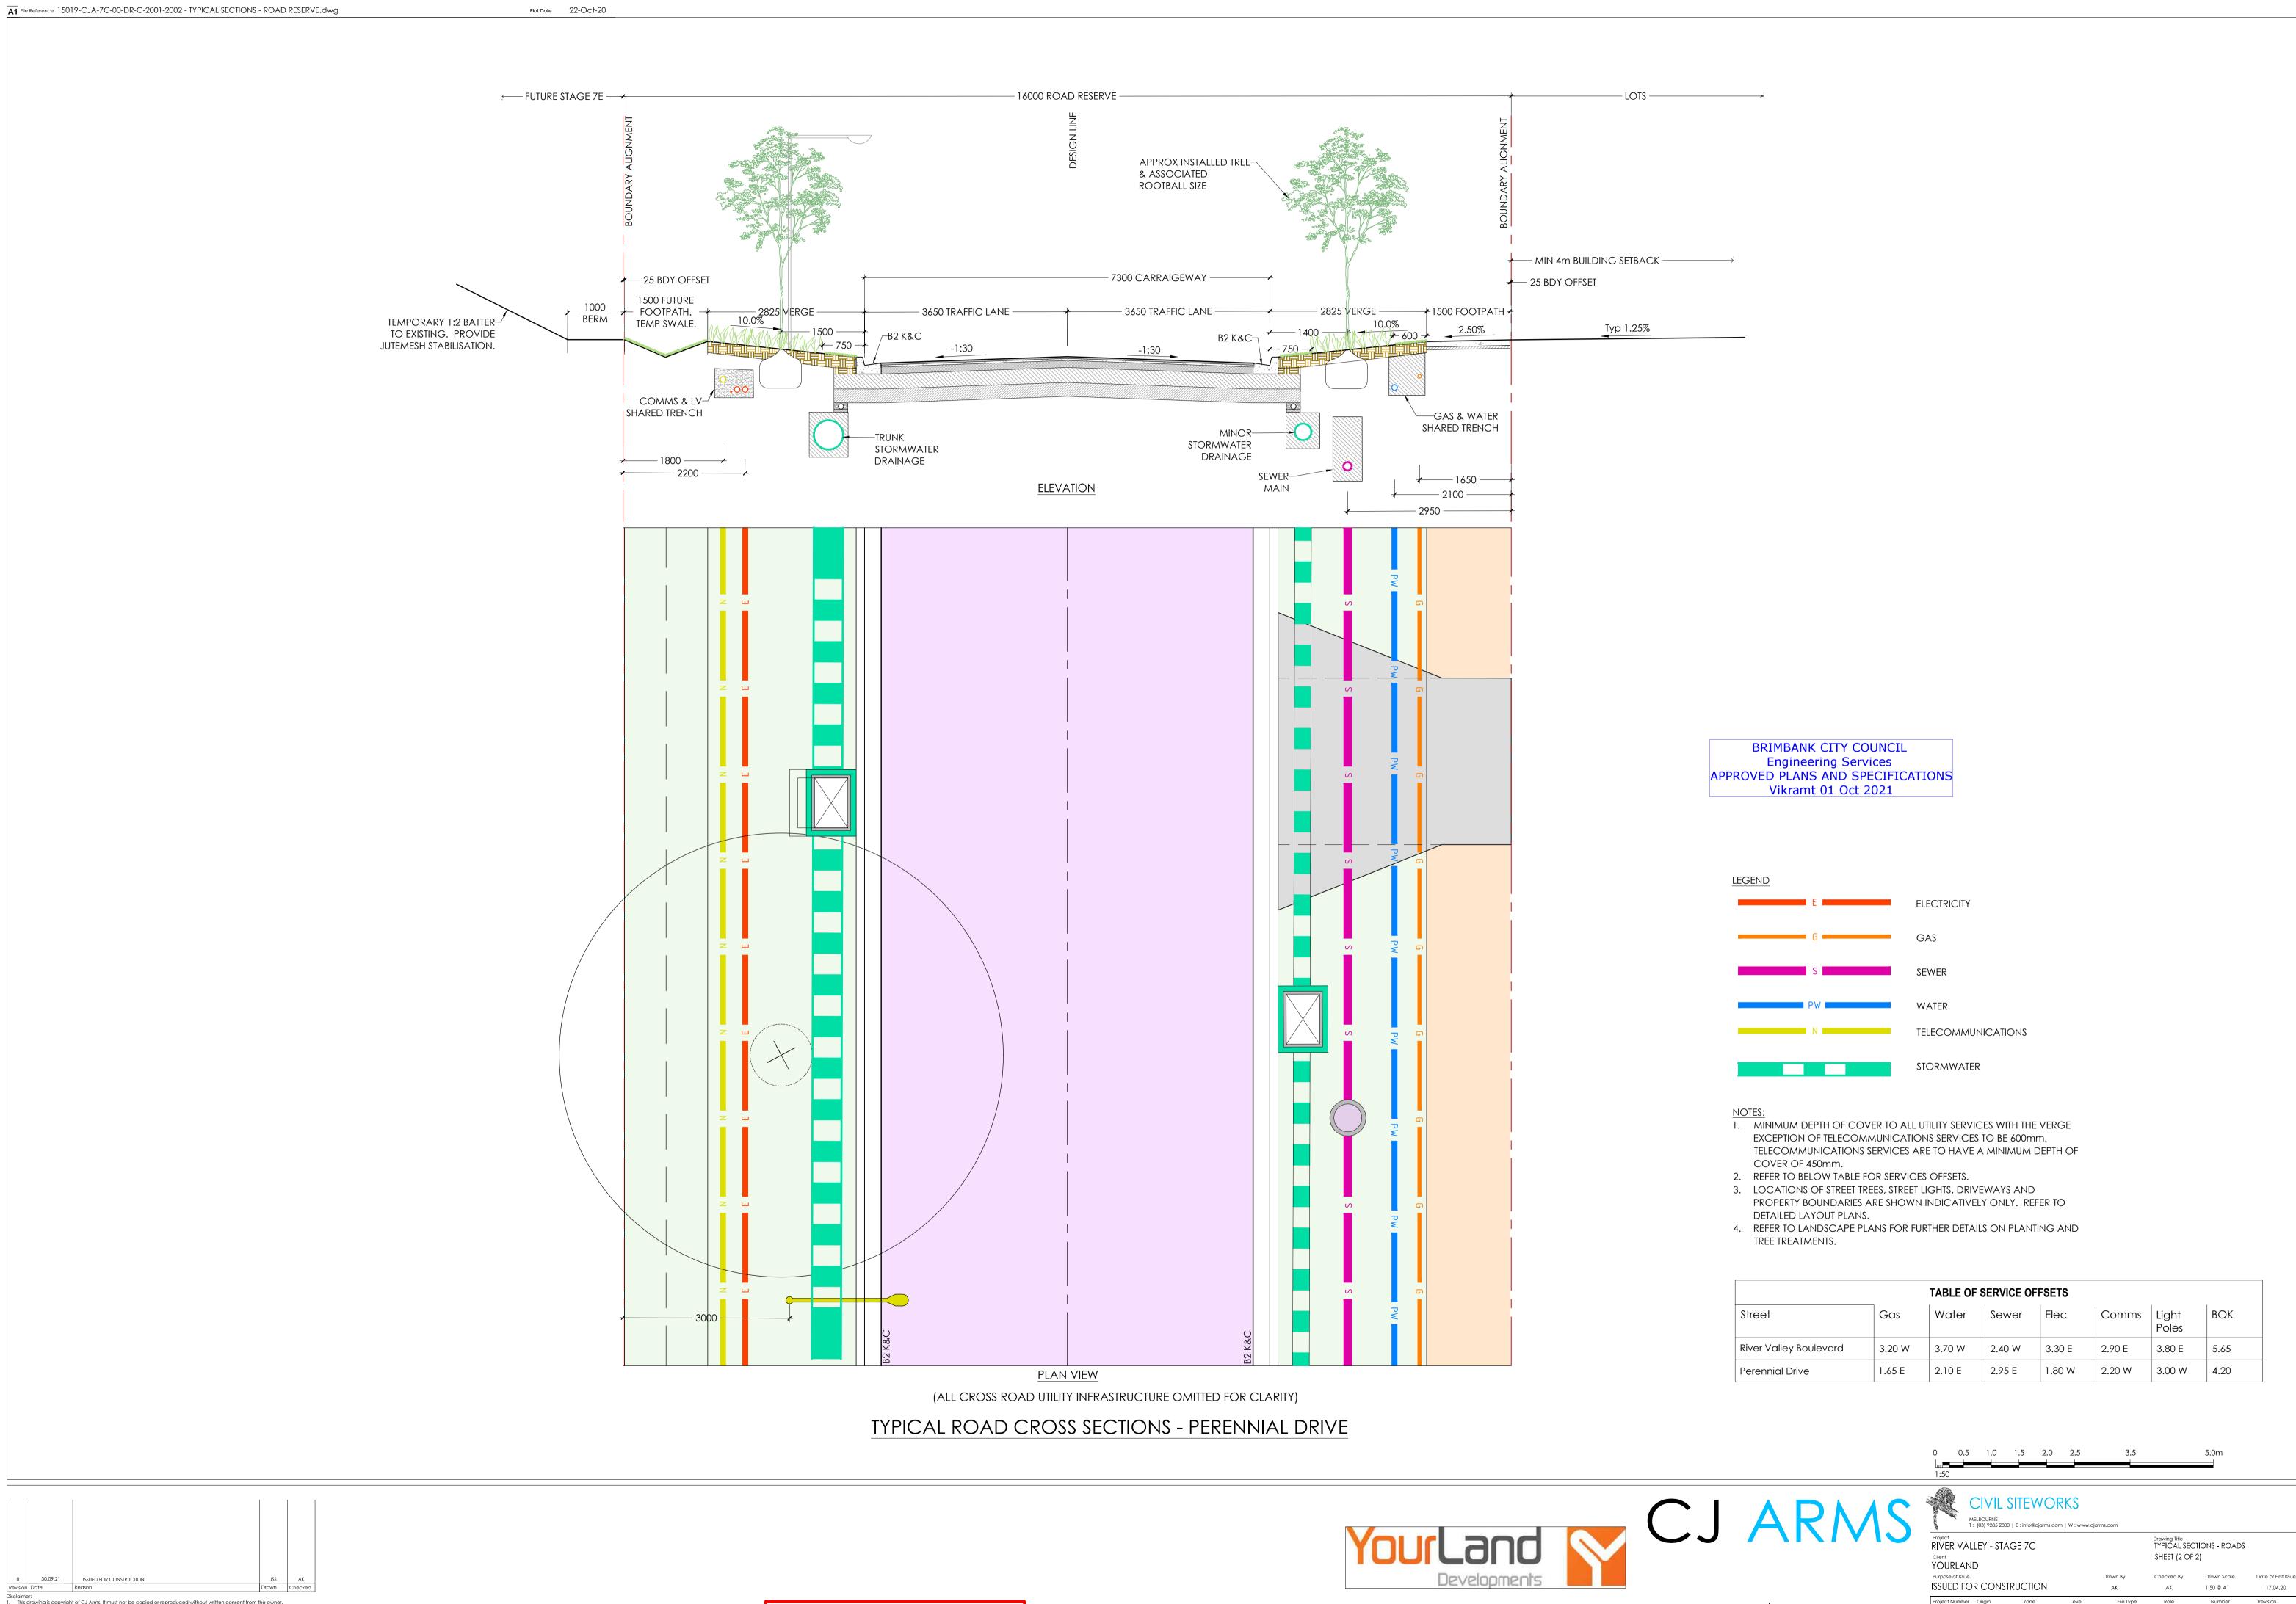


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17.04.20

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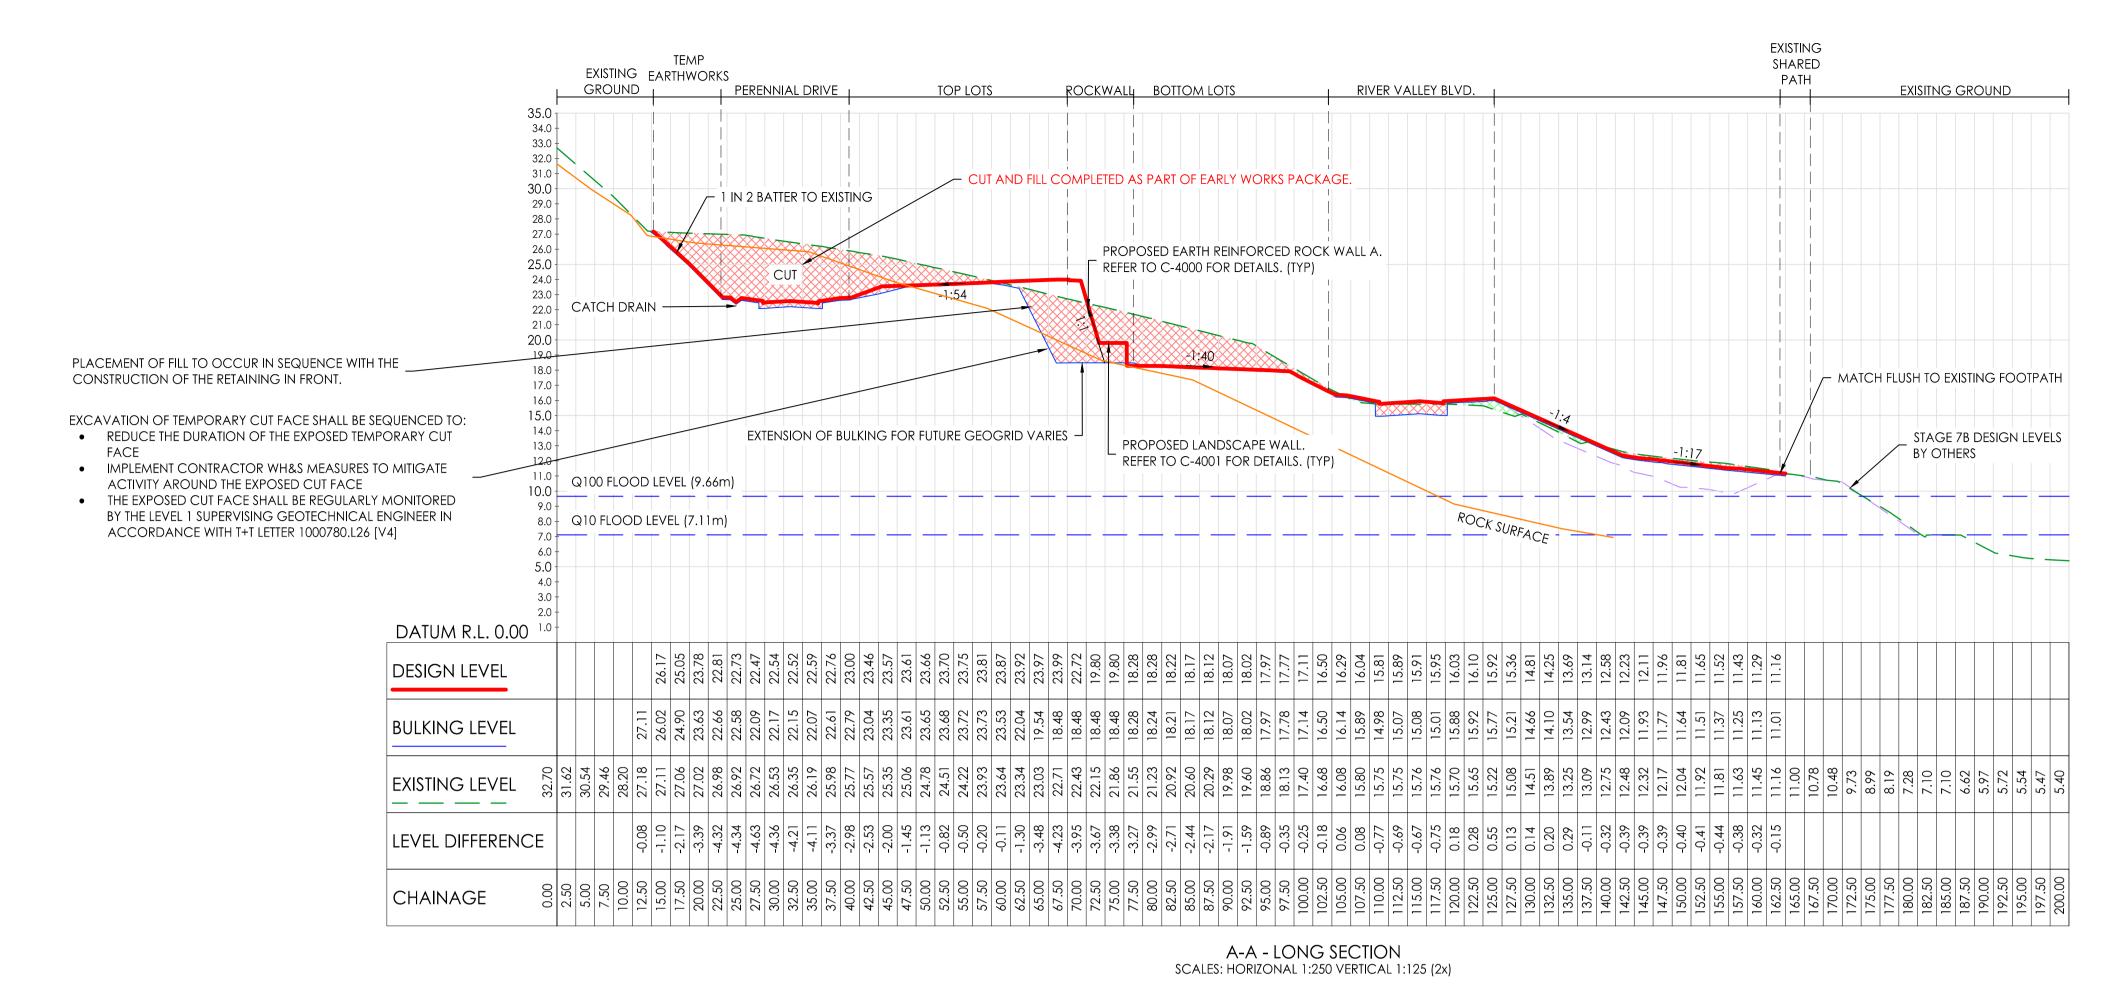



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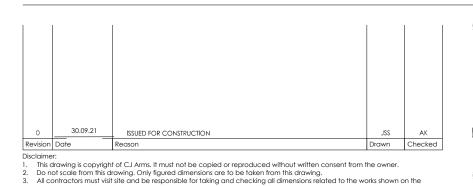

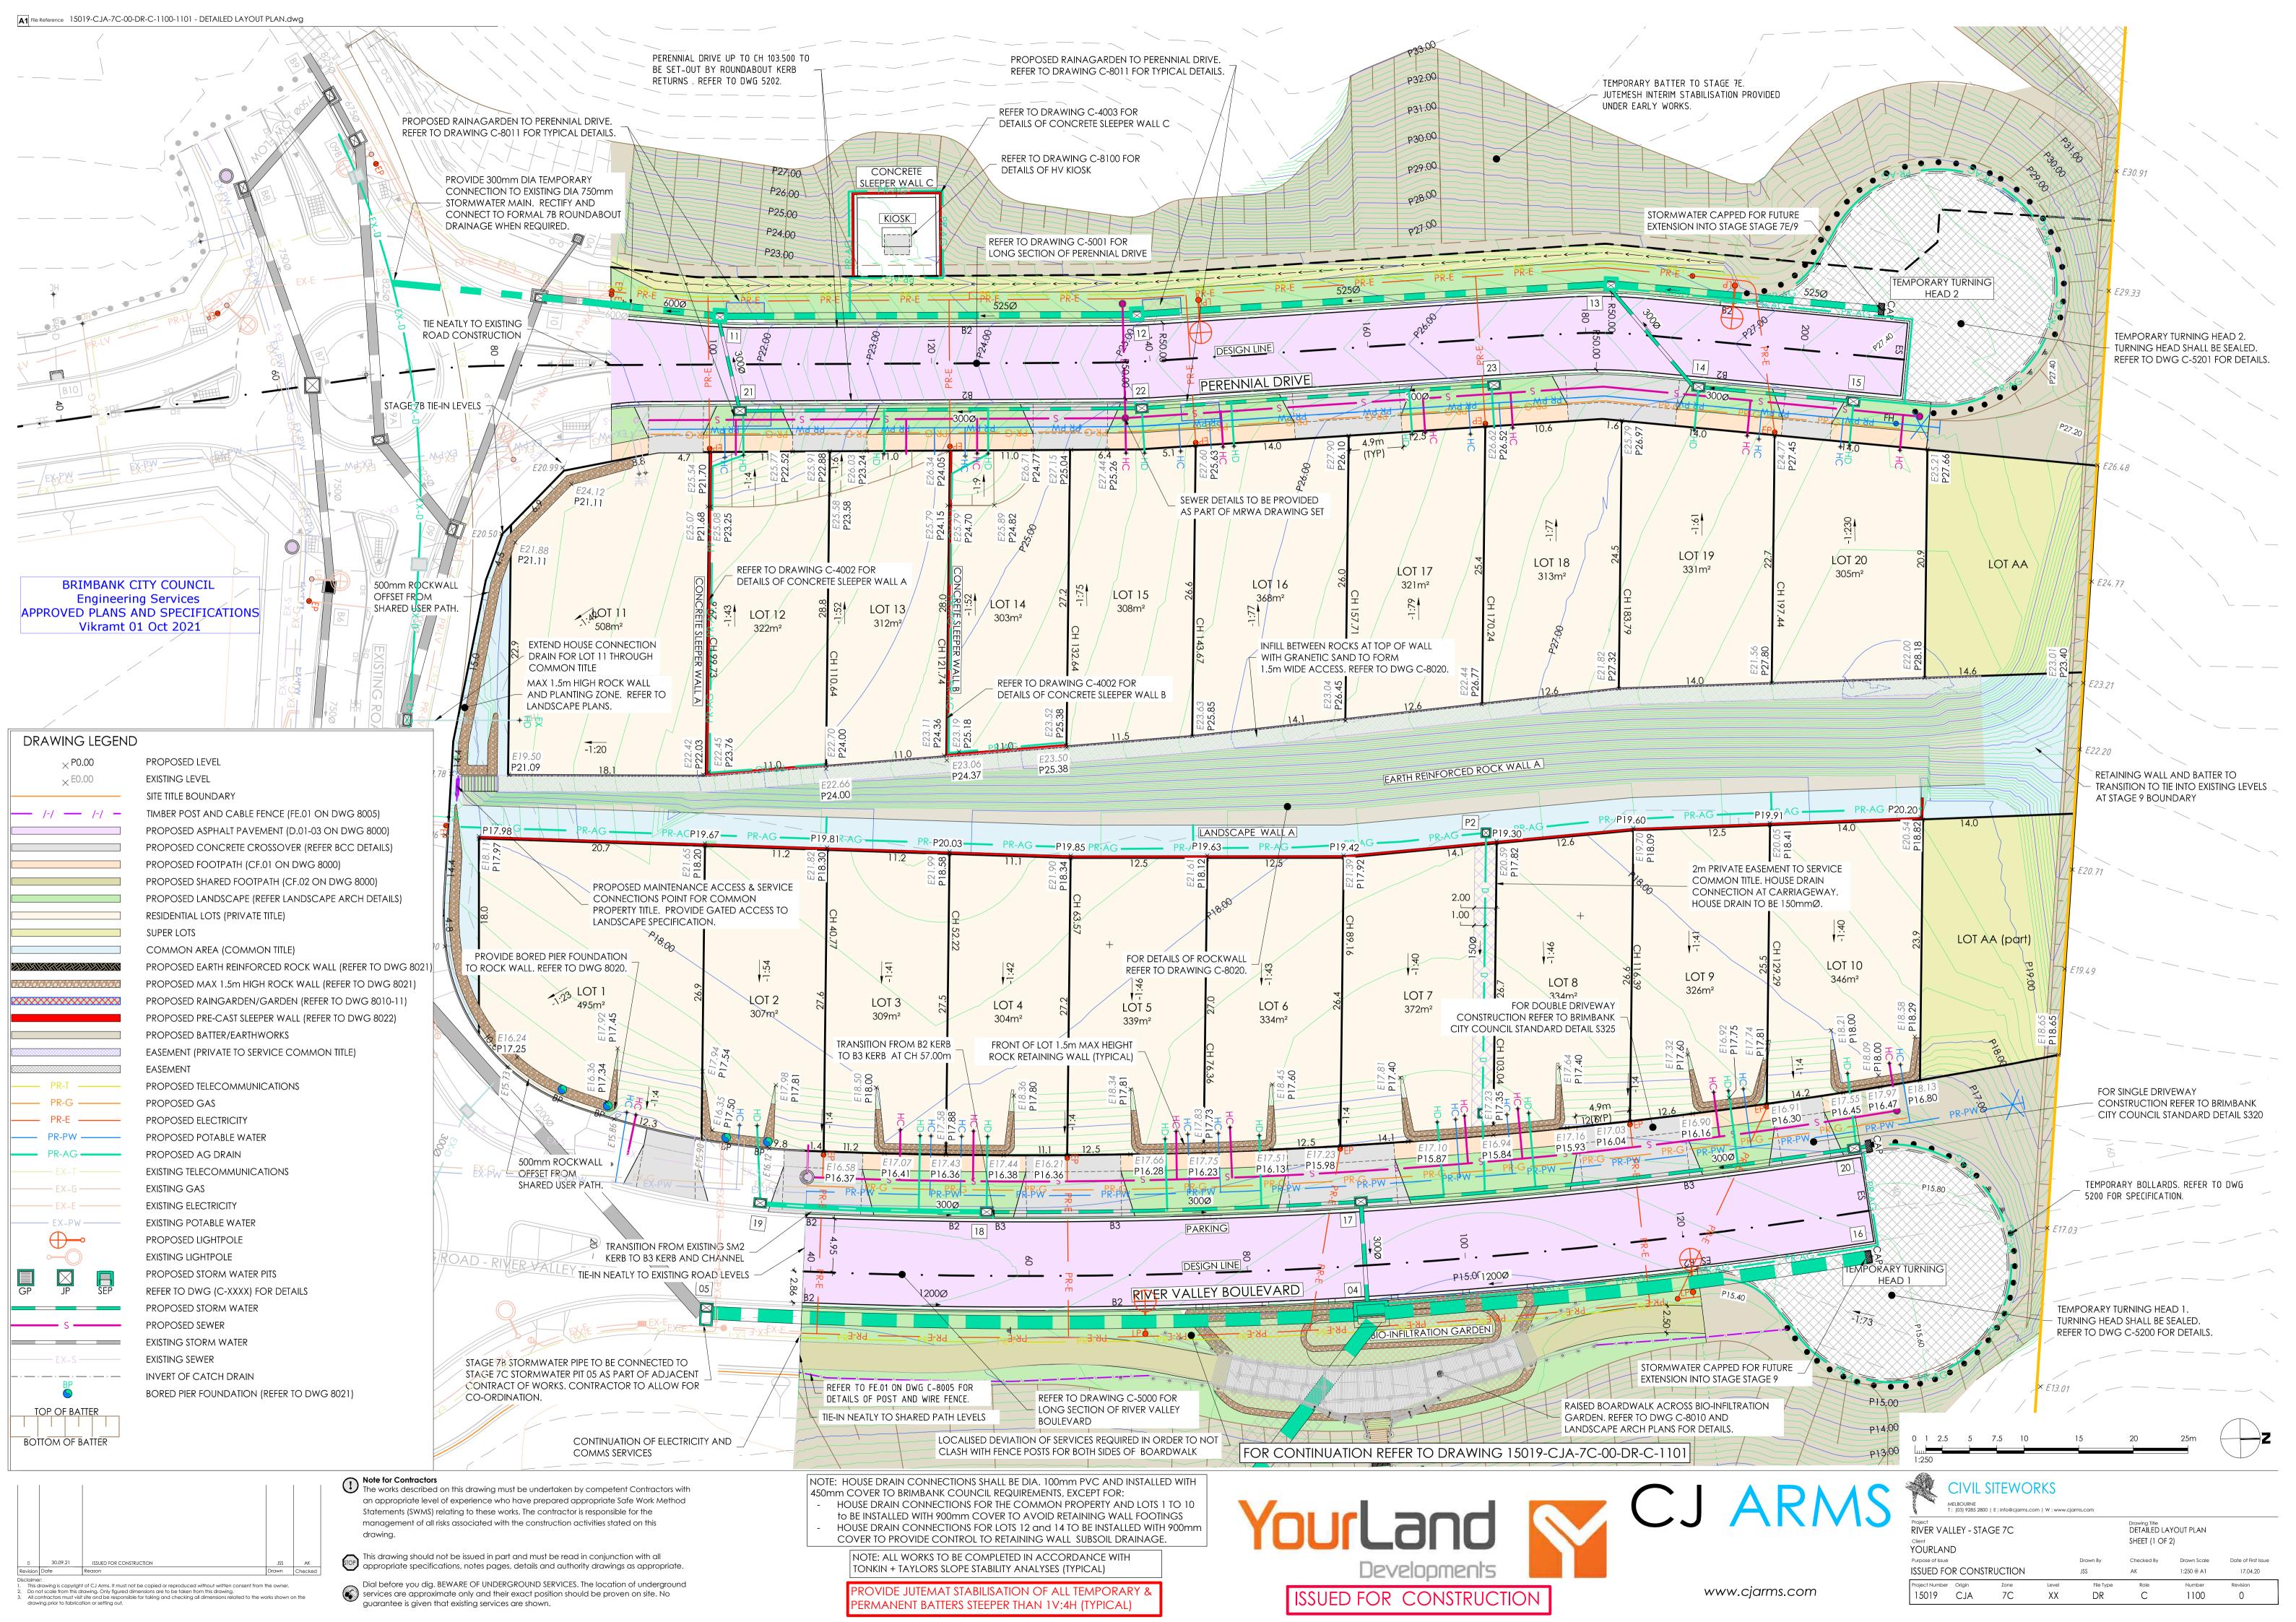
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> KEY PLAN **SCALE 1:1000**

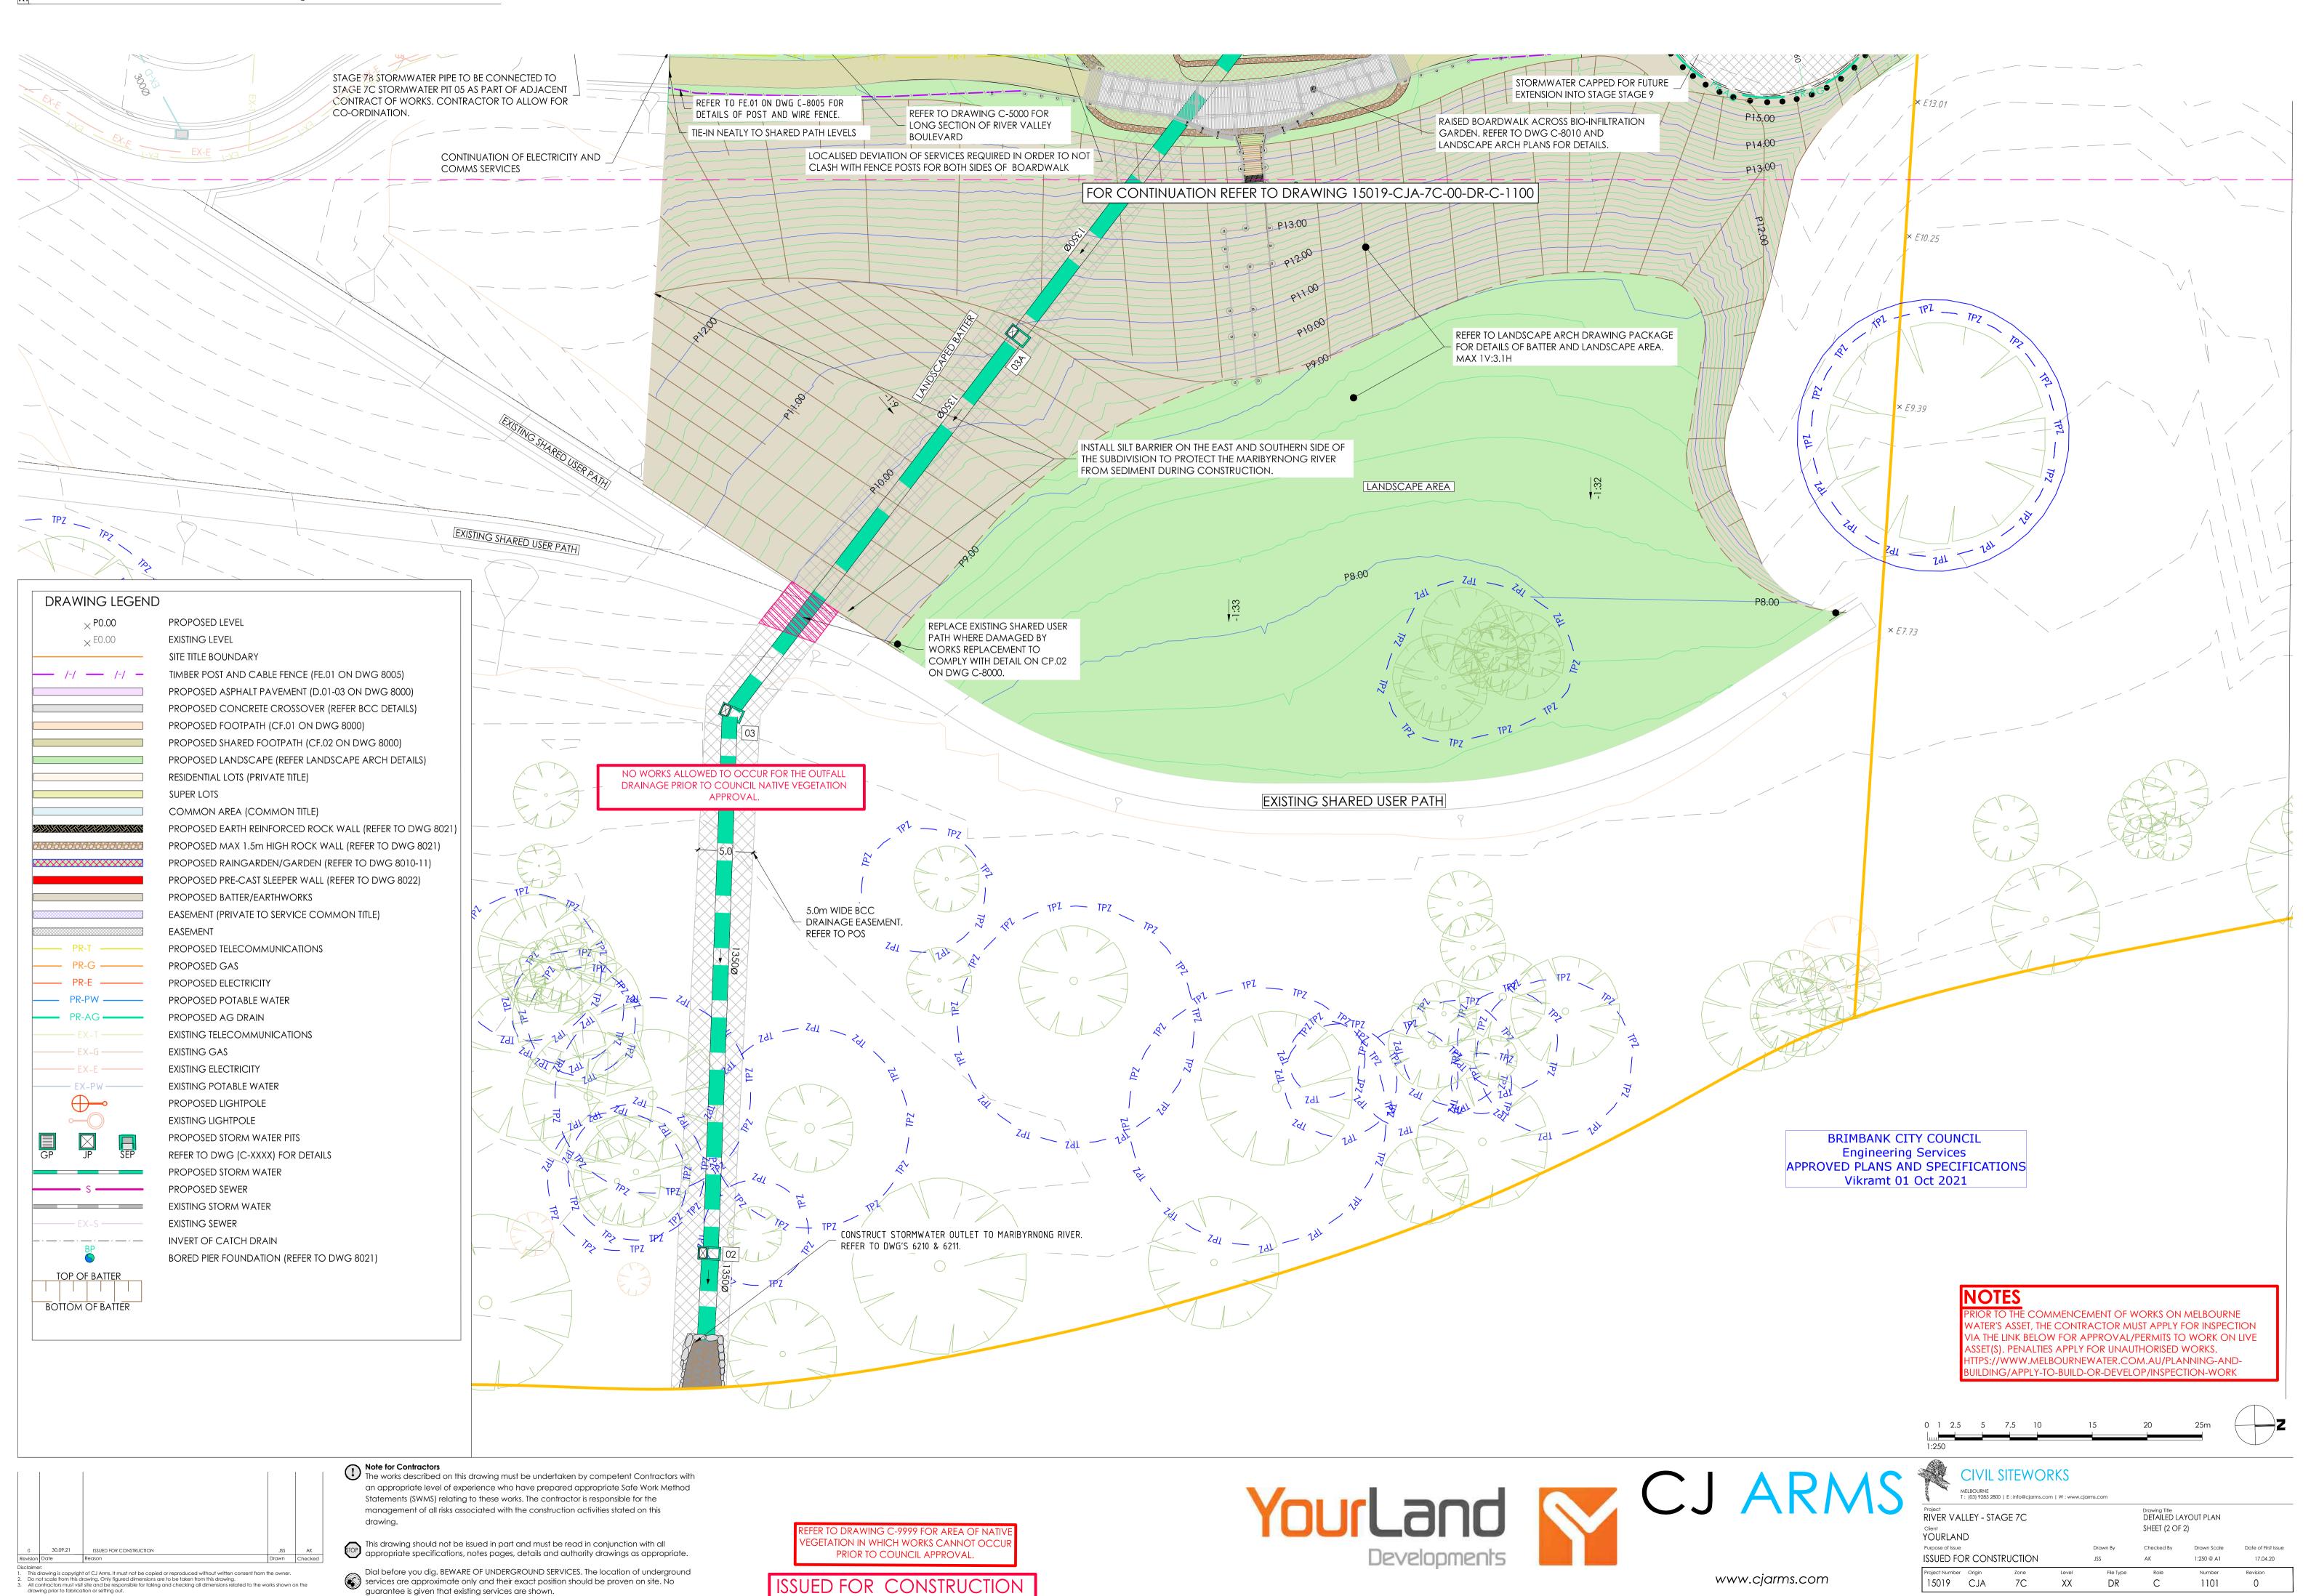BRIMBANK CITY COUNCIL Engineering Services APPROVED PLANS AND SPECIFICATIONS Vikramt 01 Oct 2021

B-B - LONG SECTION SCALES: HORIZONAL 1:250 VERTICAL 1:125 (2x)

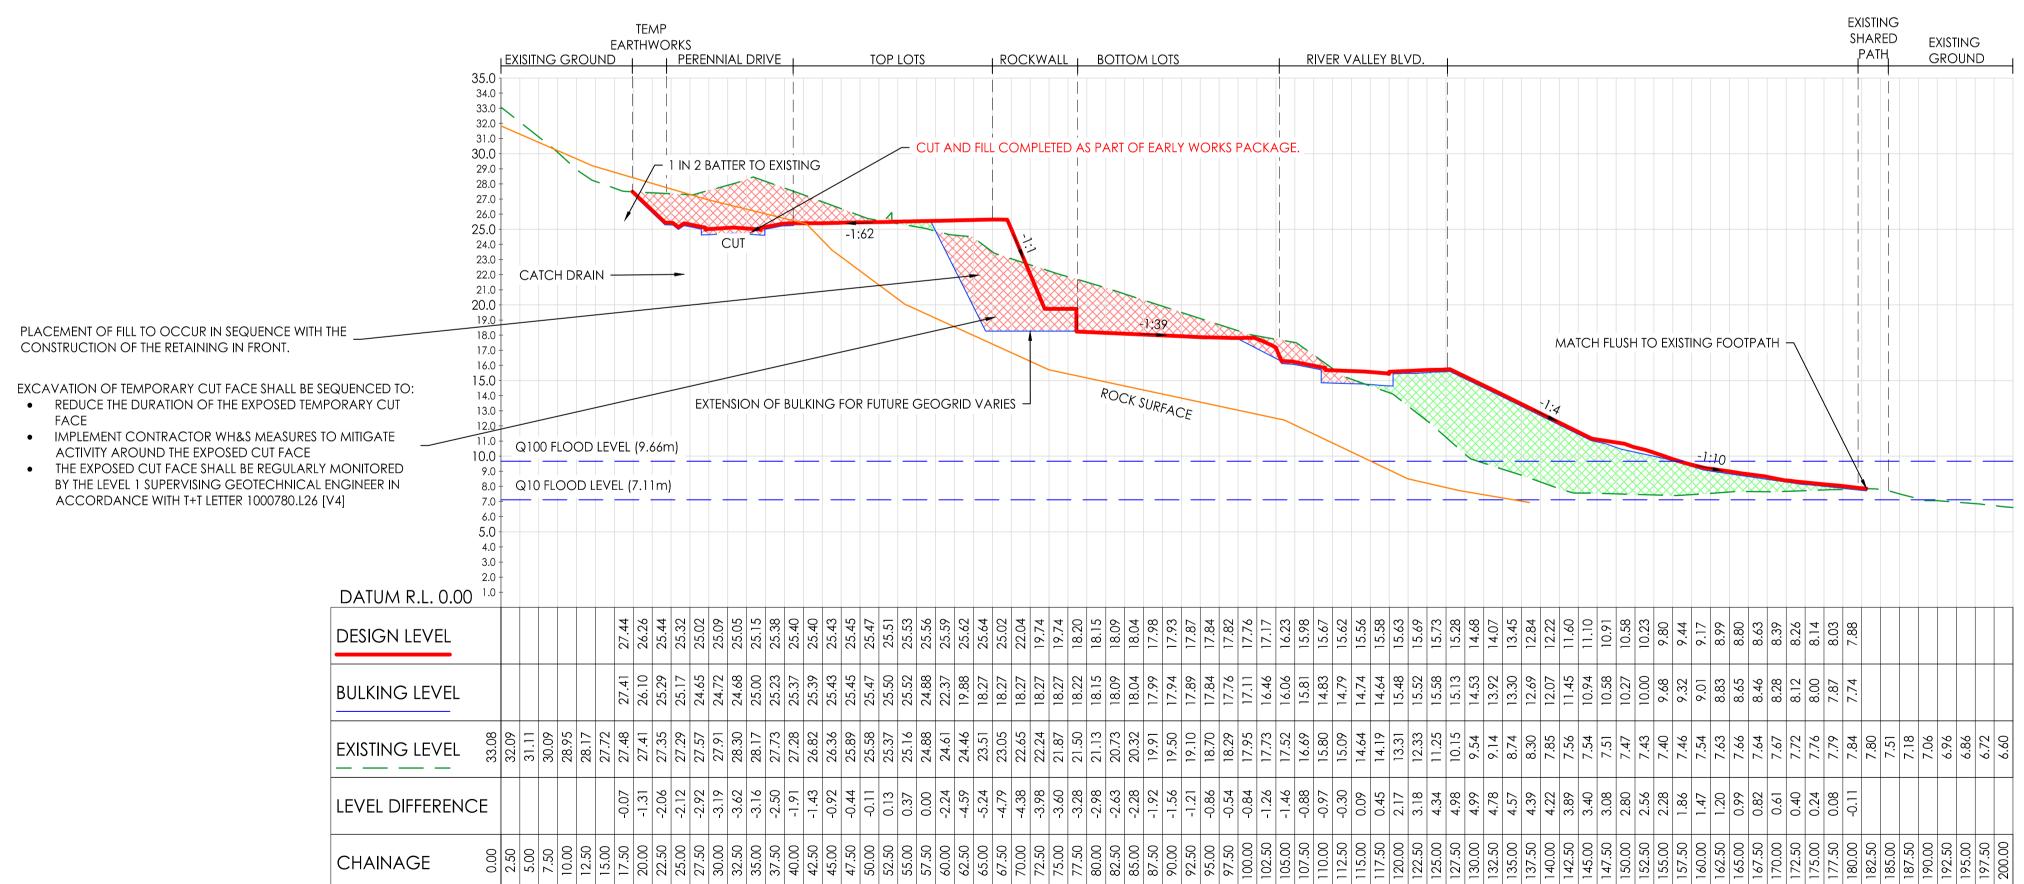

drawing prior to fabrication or setting out.

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JLK EARTHWORKS COMPLETED UNDER EARLY WORKS PACKAGE & APPROVAL. ER ENDORSED EARLY WORKS PACKAGE FOR FURTHER INFORMATION.

SECTIONS ARE PROVIDED FOR ILLUSTRATIVE PURPOSES ONLY AND ARE NOT E USED TO SET OUT THE WORKS.





RIVER VALLEY - STAGE 7C


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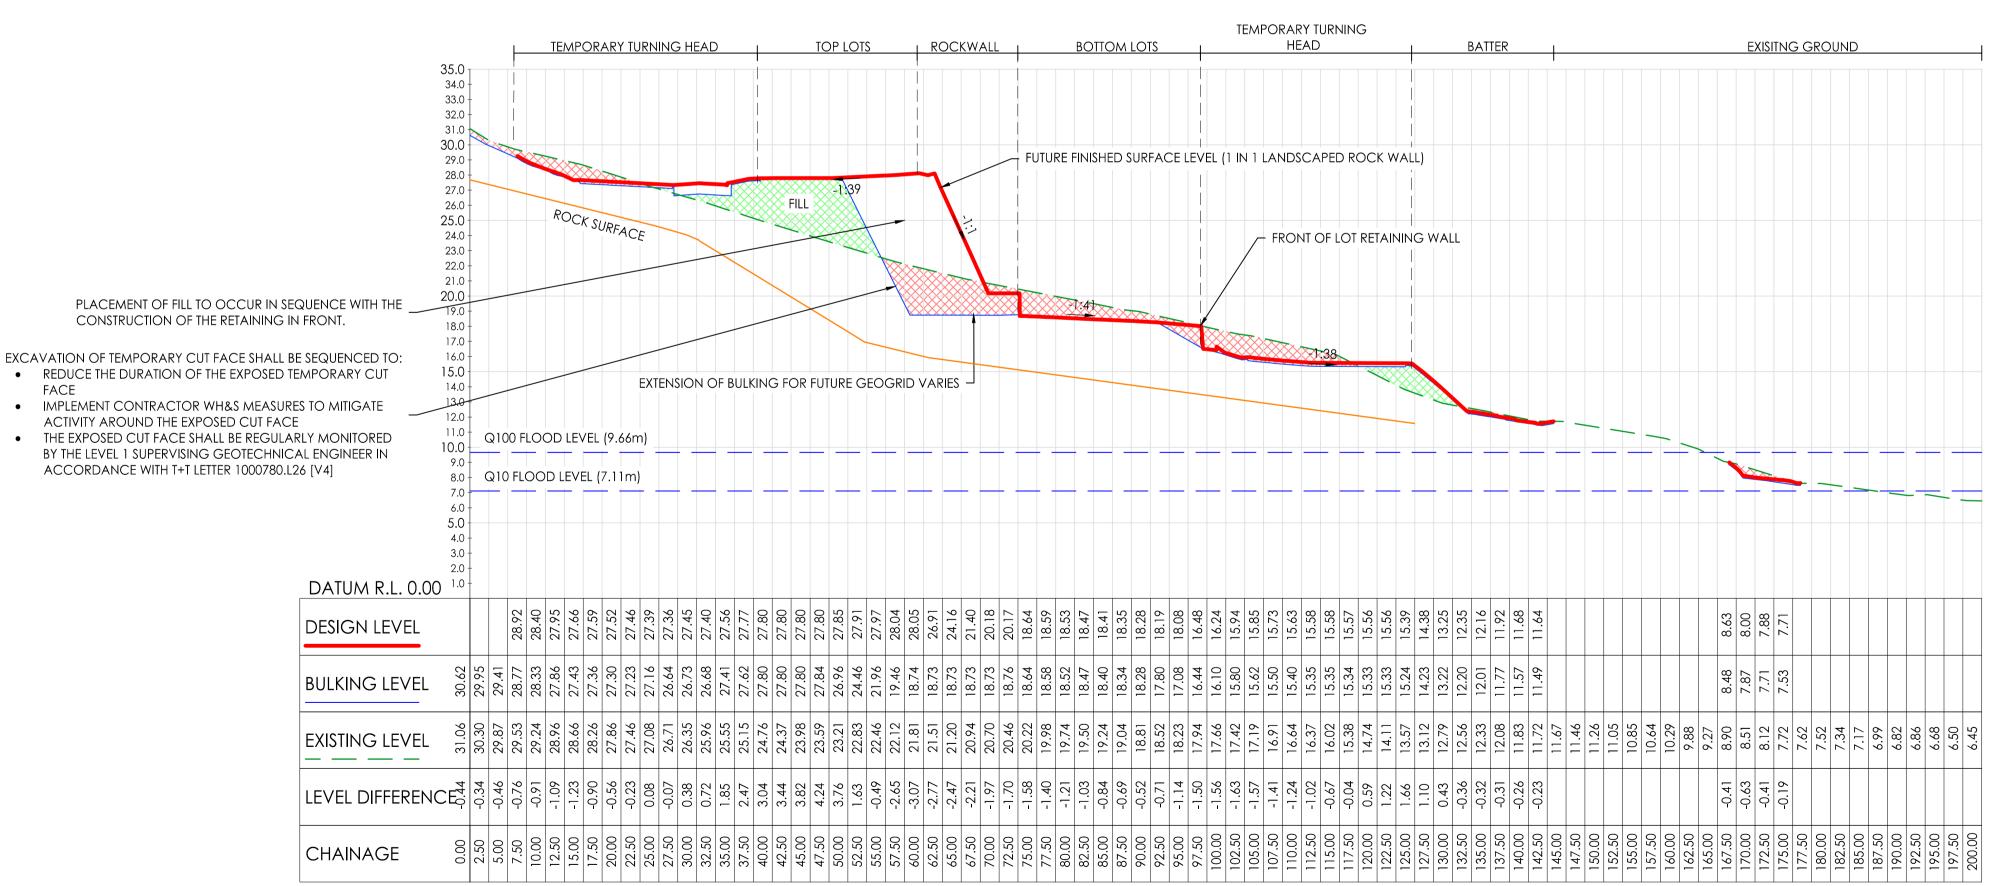
TYPICAL SECTIONS - SITE SECTIONS

17.04.20

SHEET (1 OF 2)

ISSUED FOR CONSTRUCTION



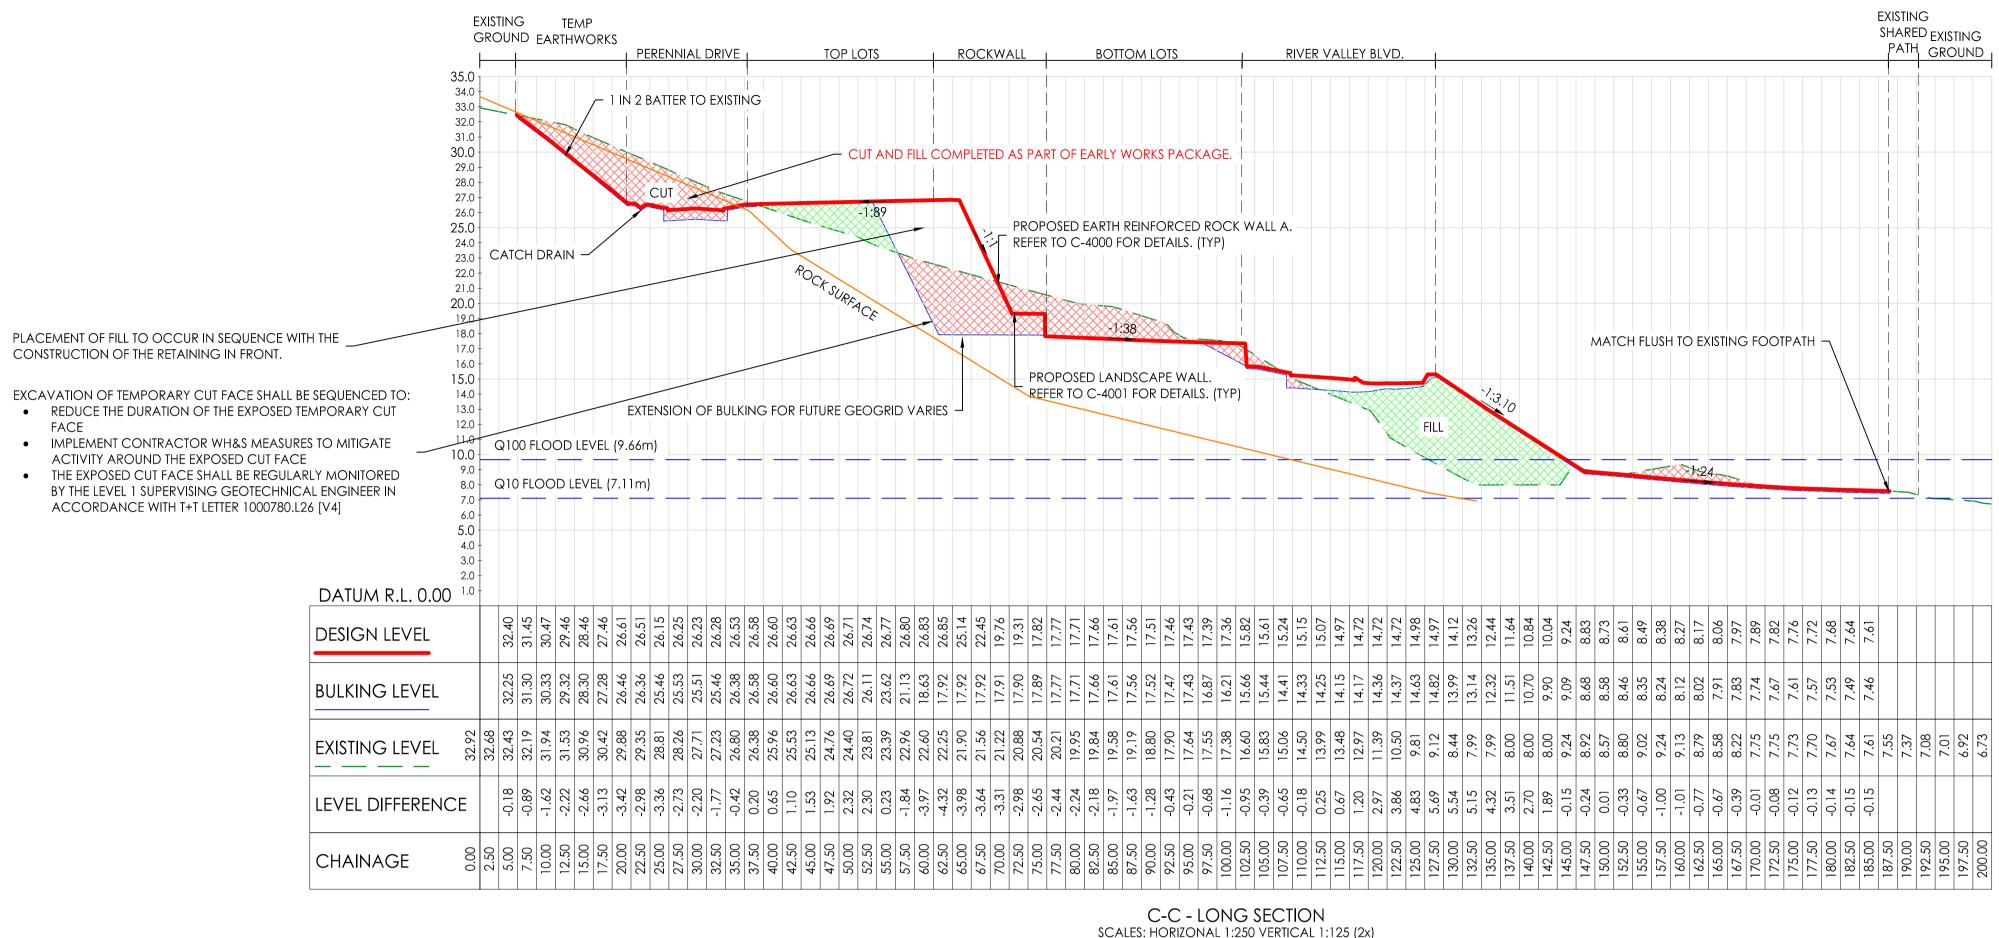


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> KEY PLAN SCALE 1:1000

**BRIMBANK CITY COUNCIL Engineering Services** APPROVED PLANS AND SPECIFICATIONS Vikramt 01 Oct 2021

D-D - LONG SECTION SCALES: HORIZONAL 1:250 VERTICAL 1:125 (2x)

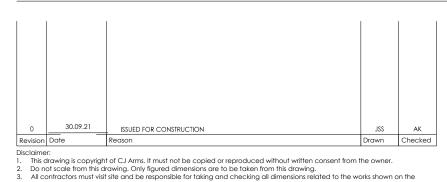

drawing prior to fabrication or setting out.

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ILK EARTHWORKS COMPLETED UNDER EARLY WORKS PACKAGE & APPROVAL. R ENDORSED EARLY WORKS PACKAGE FOR FURTHER INFORMATION.

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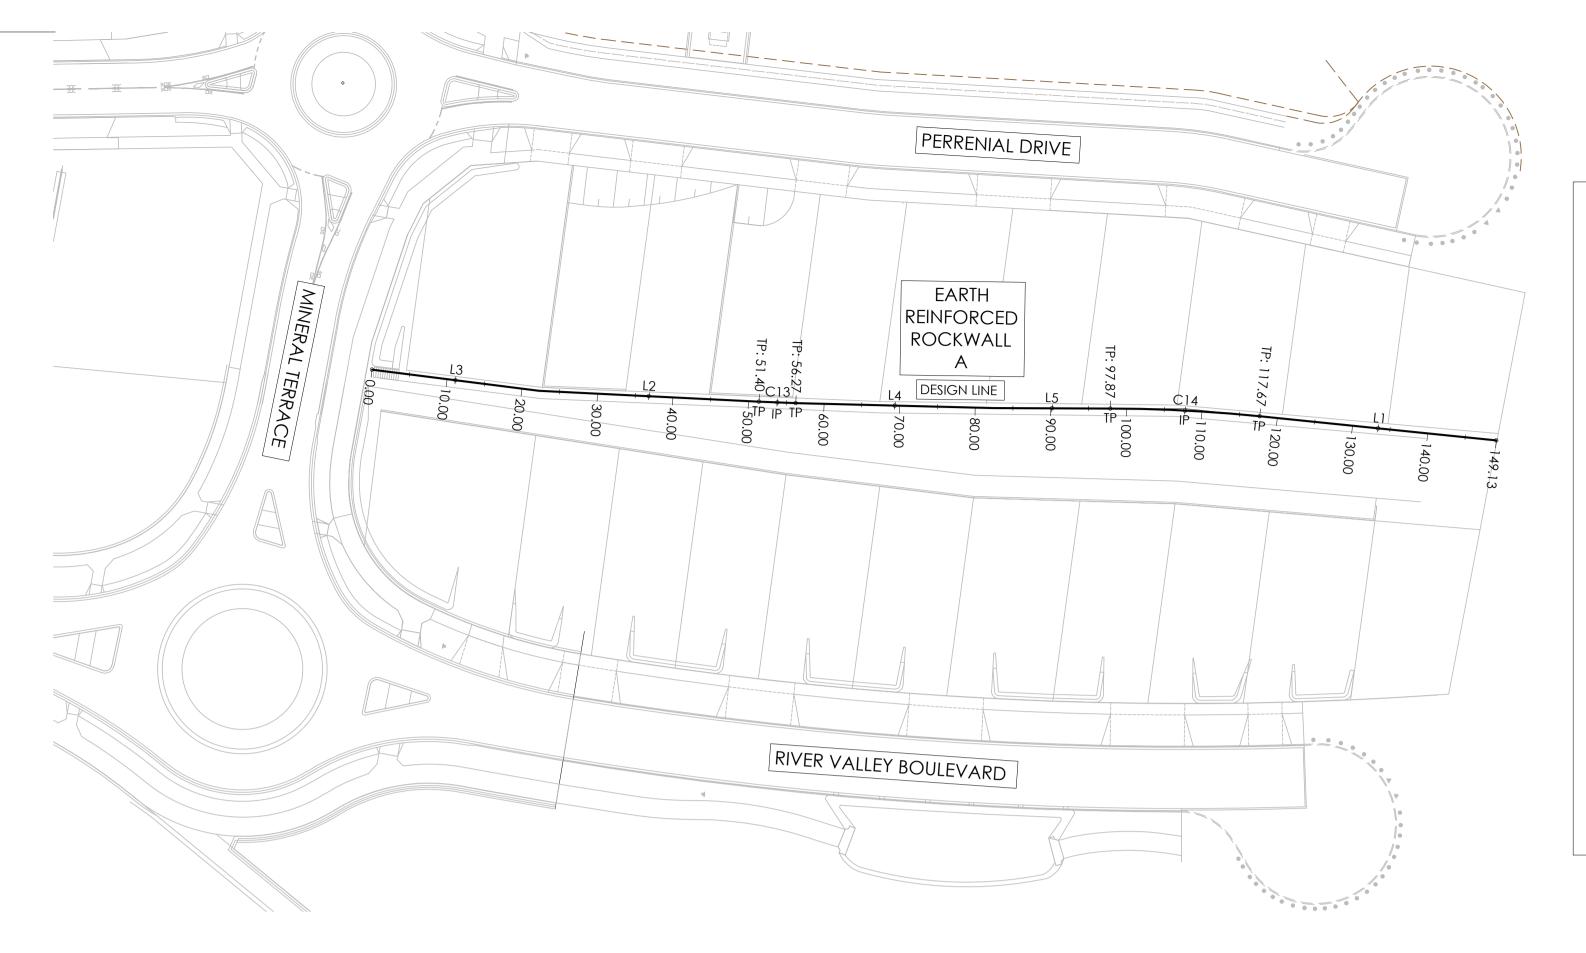


www.cjarms.com



Drawing Title
TYPICAL SECTIONS - SITE SECTIONS ISSUED FOR CONSTRUCTION 1:500 @ A1 17.04.20 15019 CJA 7C 2101 DR

	Set Out Table for DL - MAJOR ROCKWALL A - TOW										
TAG		CHAINAGE	EASTING NORTHING LENGTH		LENGTH	RADIUS	BEARING				
L3	START END	27.7/			000° 08′ 43″						
L2	START END			5819185.302 5819214.375	29.15		355° 47′ 49″				
C13	TP IP TP	IP 53.83 310385.041 5819216.807 4.88		200.0	355° 05' 55.44"						
L4	START END	56.27 82.47	310384.803 310382.247	5819219.233 5819245.303	26.20		354° 24′ 02″				
L5	START END	82.47 97.87	310382.247 310380.403	5819245.303 5819260.598	15.41		353° 07′ 31″				
C14	TP IP TP	97.87 107.78 117.67	310380.403 310379.217 310379.005	5819260.598 5819270.433 5819280.337	19.80	201.0	355° 56' 49.28"				
L1	START END	117.67 149.13	310379.005 310378.329	5819280.337 5819311.788	31.46		358° 46′ 08″				





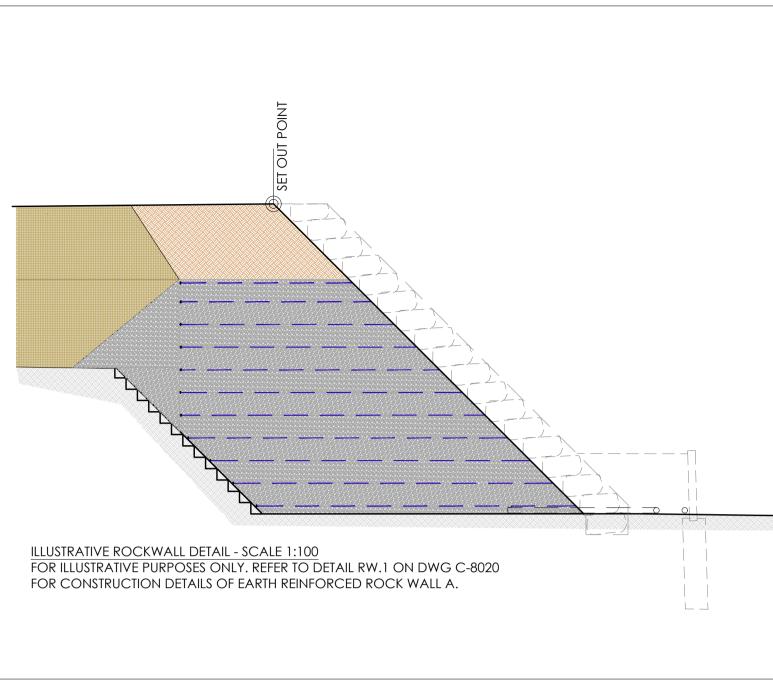


	TABLE.04 - GEOGRID SCHEDULE - INSTALL CHAINAGES											
	CHAINAGE											
RL (m)	5 to 20	20 to 40	40 to 60	60 to 75	75 to 90	90 to 105	105 to 120	120 to 135				
25.7								4.3				
25.1							4.3	4.9				
24.5						4.4	4.9	5.5				
23.9					3.9	5.0	5.5	6.1				
23.3				4.0	4.5	5.6	6.1	6.7				
22.7				4.6	5.1	6.2	6.7	7.3				
22.1				5.2	5.7	6.8	7.3	7.9				
21.5			4.5	5.8	6.3	7.4	7.9	8.5				
20.9			5.1	6.4	6.9	8.0	8.5	9.1				
20.3		4.5	5.7	7.0	7.5	8.6	9.1	9.7				
19.7		5.1	6.3	7.6	8.1	9.2	9.7	10.3				
19.1	4.0	5.7	6.9	8.2	8.7	9.8	10.3	10.9				
18.5	4.6	6.3	7.5	8.8	9.3	10.4	10.9	11.5				
17.9			8.1	9.4	9.9	11.0	11.5					
17.3				10.0	10.5							

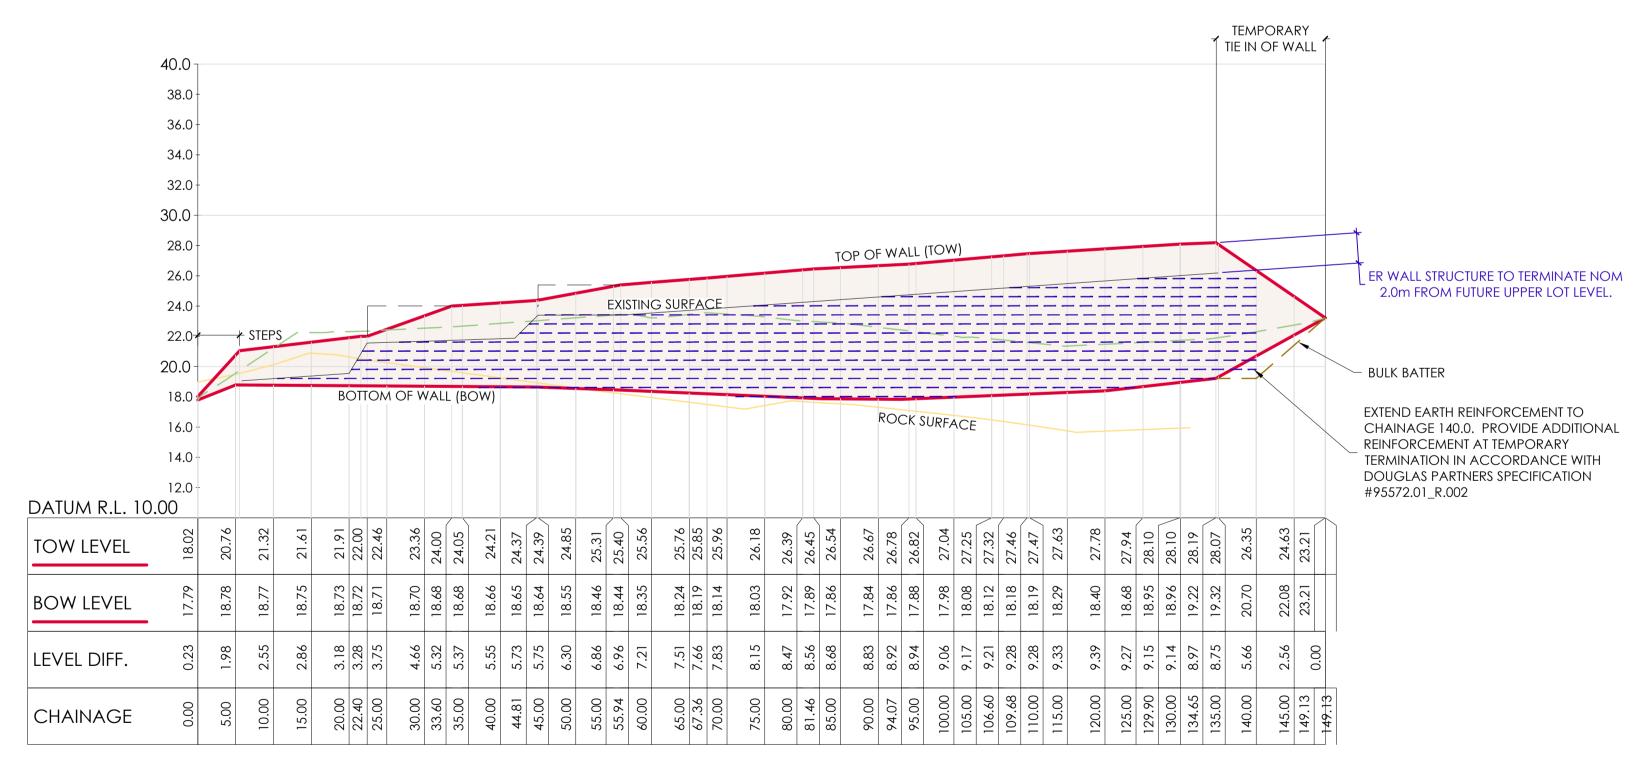

EARTH REINFORCED ROCKWALL A - LONG SECTION SCALES: HORIZONAL 1:500 VERTICAL 1:250 (2x)

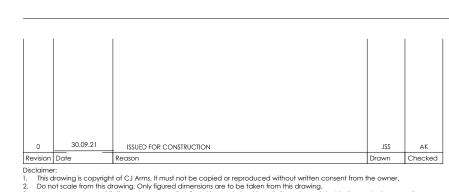

All contractors must visit site and be responsible for taking and checking all dimensions related to the works shown on the

drawing prior to fabrication or setting out.

drawing.

Note for Contractors

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- Dial before you dig. BEWARE OF UNDERGROUND SERVICES. The location of underground services are approximate only and their exact position should be proven on site. No guarantee is given that existing services are shown.

THE INFORMATION CONTAINED ON THIS PLAN IS A REPRESENTATION OF THE DESIGN PREPARED BY DOUGLAS PARTNERS. REFER TO: DOUGLAS PARTNERS REPORT #95572.01\_R001 FOR DESIGN AND CERTIFICATION OF THE

DOUGLAS PARTNERS REPORT #95572.01\_R002 FOR CONSTRUCTION SPECIFICATION. ANY DISCREPANCIES BETWEEN THE DESIGN DRAWINGS AND THE DOUGLAS PARTNERS EQUIREMENTS SHALL BE REFERRED TO THE SUPERINTENDENT.





Drawing Title
LONG SECTION - ROCK RETAINING WALL RIVER VALLEY - STAGE 7C YOURLAND ISSUED FOR CONSTRUCTION 1:250 @ A1


DR

15019 CJA 7C

17.04.20

4000

	Set Out Table for DL - LANDSCAPE WALL A - BOW - HA									
TAG		RADIUS	BEARING							
L12	START END	0.00 2.26	310390.338 310392.594	5819164.910 5819164.910	2.26		090° 00′ 00″			
L13	START END	2.26 56.48	310392.594 310394.377	5819164.910 5819219.104	54.22		001° 53′ 02″			
L10	START END	56.48 81.46	310394.377 310394.365	5819219.104 5819244.087	24.98		359° 58′ 24″			
Lll	START END	81.46 108.13	310394.365 310391.859	5819244.087 5819270.641	26.67		354° 36′ 34"			
L14	START END	108.13 134.67	310391.859 310390.850	5819270.641 5819297.161	26.54		357° 49′ 16″			
L15	START END	134.67 137.70	310390.850 310387.828	5819297.161 5819297.182	3.02		270° 23′ 48″			

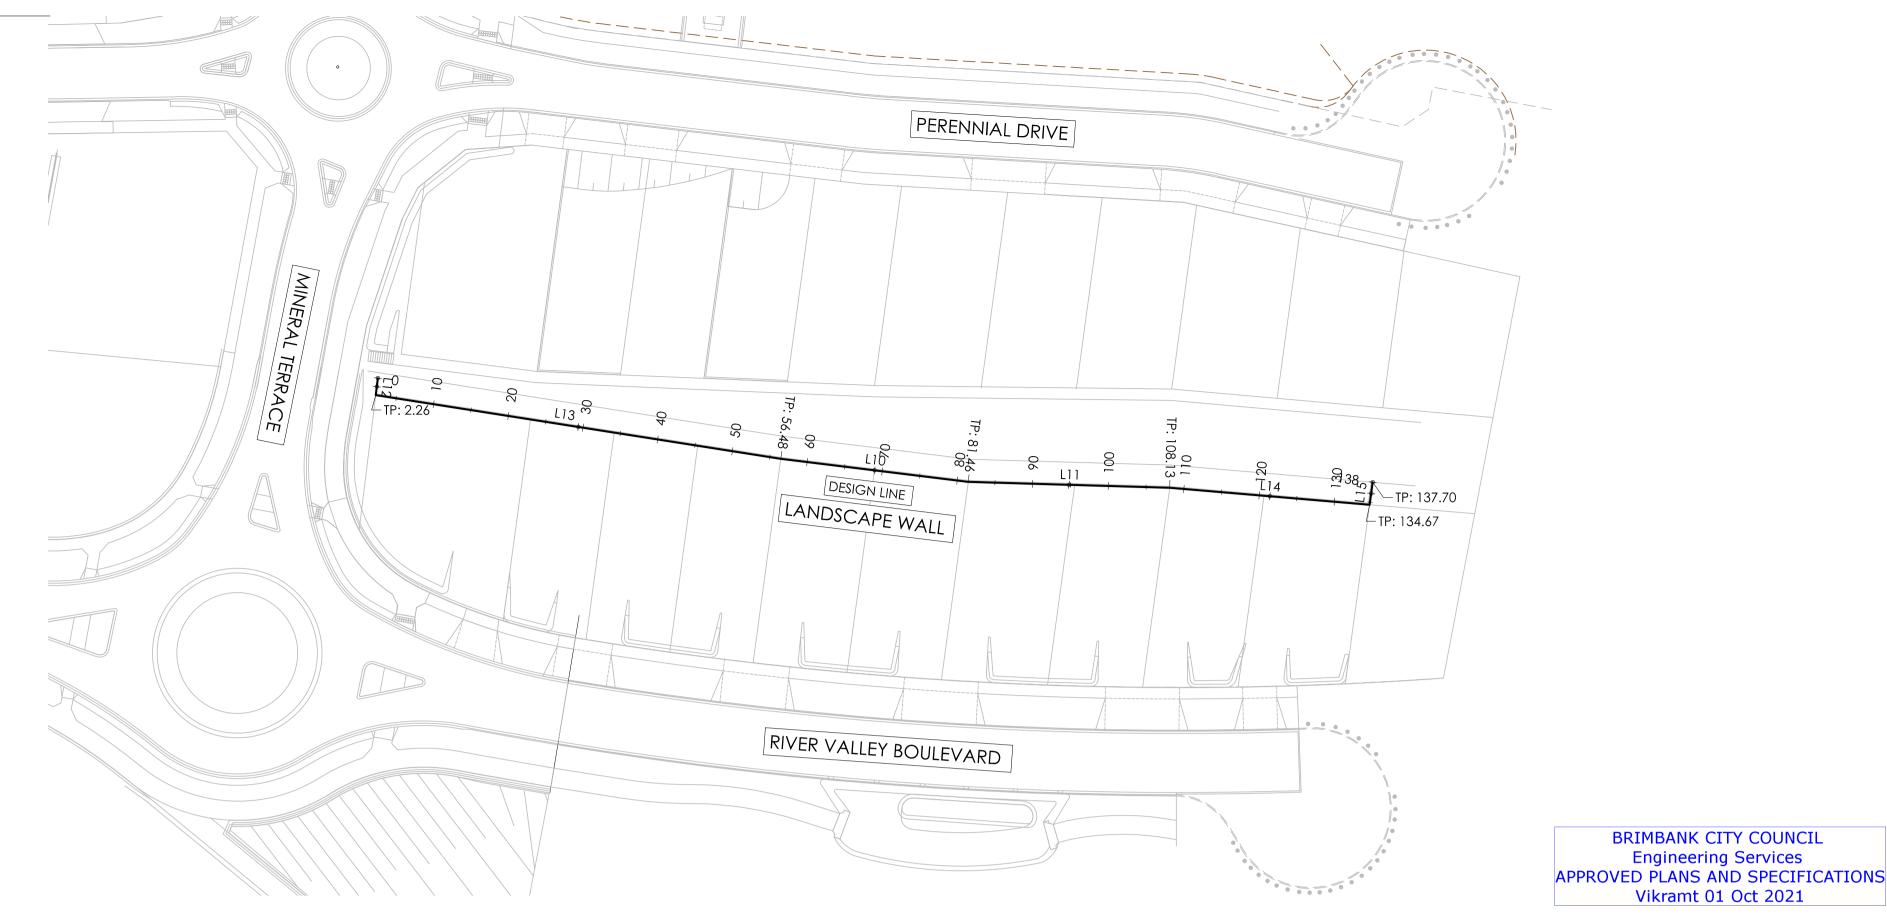

TP CH: 56.48 TP CH: 81.46 TP CH: 108.13 CH: 134.67 CH: 2.26 28.0 27.0 26.0 25.0 24.0 3 23 24 .43 EXISTING SURFACE ROCK SURFACE 13.0

PR LEVELS (TOP OF WALL) PR LEVELS (BOTTOM OF WALL) (BOW) (KEY FOR LONG SECTION)

DL - LANDSCAPE WALL A - BOW - HA - LONG SECTION

SCALES: HORIZONAL 1:250 VERTICAL 1:125 (2x)



isclaimer:

This drawing is copyright of CJ Arms. It must not be copied or reproduced without written consent from the owner.

Do not scale from this drawing. Only figured dimensions are to be taken from this drawing.

All contractors must visit site and be responsible for taking and checking all dimensions related to the works shown on the drawing prior to fabrication or setting out.

12.0

11.0

DATUM R.L. 10.00

(BOTTOM RWALL)<sup>∞</sup>

PR LEVELS

PR LEVELS (TOP RWALL)

LEVEL DIFF.

CHAINAGE

drawing.

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ETAINING WALL SECTIONS ARE PROVIDED BY CJ ARMS TO REPRESENT THE PROPOSED GROUND LEVEL AT THE TOP AND BOTTOM OF RETAINING WALLS.

HE CONTRACTOR IS TO DETERMINE OPTIMAL CONCRETE SLEEPER HEIGHT/POST SPACING AND ASSOCIATED FOUNDATIONS TO ACHIEVE THE PROPOSED GROUND LEVELS SHOWN BY CJA.

REFER TO DRAWING C-8022 FOR RETAINING WALL DETAILS.





BRIMBANK CITY COUNCIL **Engineering Services** 


Vikramt 01 Oct 2021

15019 CJA 7C


Drawing Title
LONG SECTION - LANDSCAPE RETAINING WALL RIVER VALLEY - STAGE 7C Client YOURLAND Purpose of Issue ISSUED FOR CONSTRUCTION 1:250 @ A1 31.03.21

DR

4001

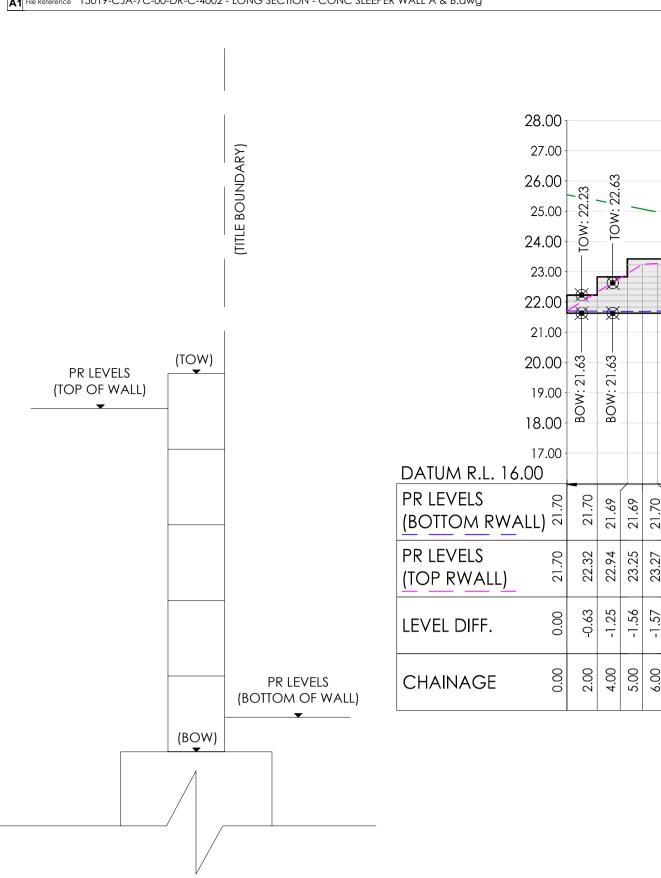


KEY FOR LONG SECTION

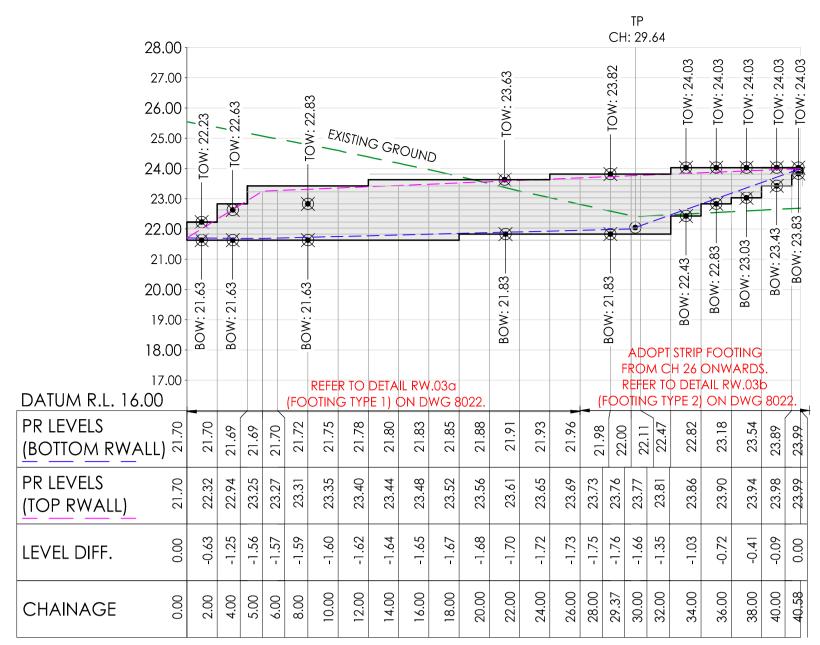

DL - CONC RWALL A - BOW - HA - LONG SECTION	
SCALES: HORIZONAL 1:250 VERTICAL 1:125 (2x)	

Set Out Table for DL - CONC RWALL A - BOW - HA								
TAG		CHAINAGE	EASTING	NORTHING	LENGTH	RADIUS	BEARING	
L19	START END	0.00 29.64	310357.215 310386.857	5819186.037 5819185.686	29.64		090° 40′ 41″	
L20	START	29.64 40.69	310386.857 310385 962	5819185.686 5819196.697	11.05		355° 21′ 07″	



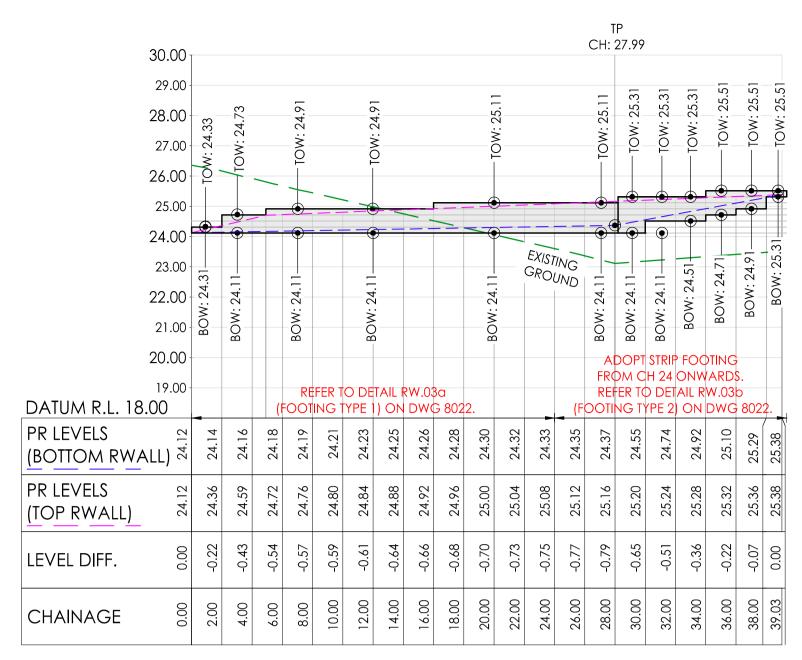


DL - CONC RWALL B - BOW - HA - LONG SECTION SCALES: HORIZONAL 1:250 VERTICAL 1:125 (2x)

BRIMBANK CITY COUNCIL **Engineering Services** APPROVED PLANS AND SPECIFICATIONS Vikramt 01 Oct 2021

Set Out Table for DL - CONC RWALL B - BOW - HA										
TAG		CHAINAGE	EASTING	NORTHING	LENGTH	RADIUS	BEARING			
L21	START END	0.00 27.99	310357.083 310385.067	5819208.039 5819207.708	27.99		090° 40′ 39"			
L22	START END	27.99 39.03	310385.067 310384.172	5819207.708 5819218.720	11.05		355° 21′ 07″			



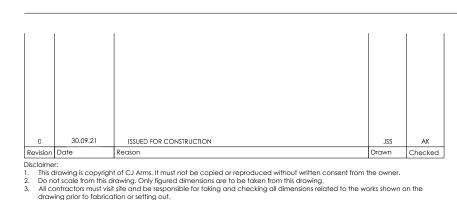

drawing.

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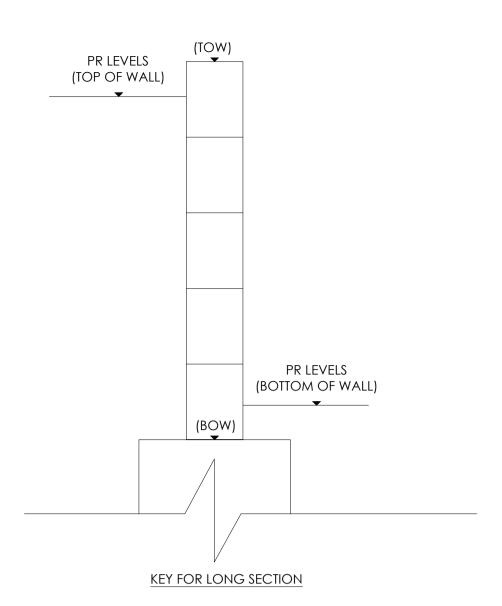







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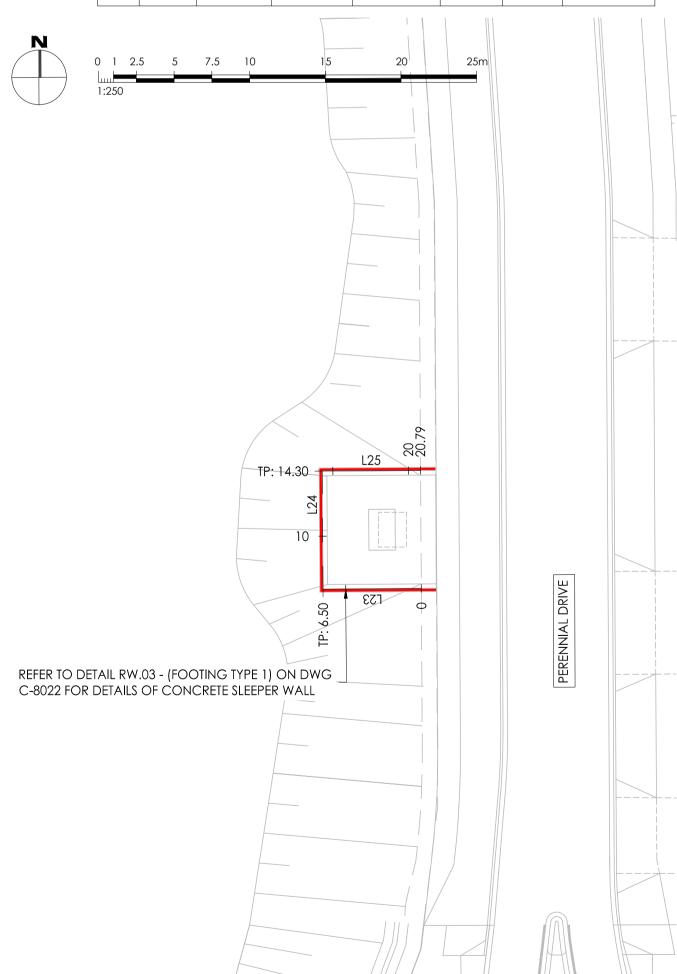
Drawn Scale ISSUED FOR CONSTRUCTION 1:250 @ A1 31.03.21 15019 CJA 7C DR 4002



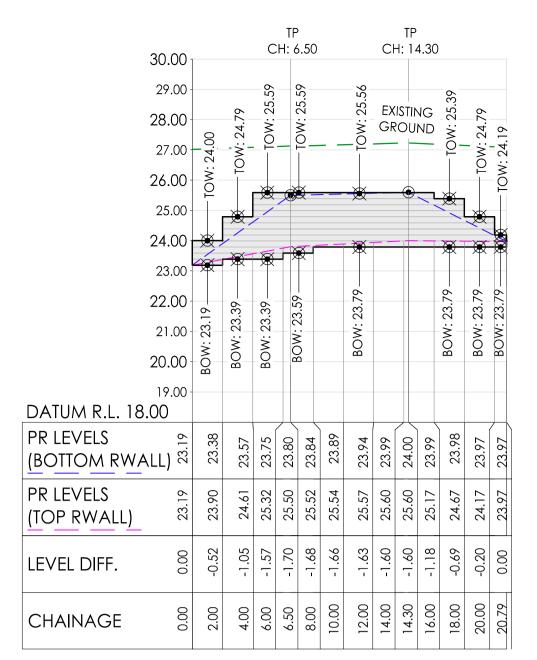

DL - CONC RWALL C - BOW - HA - LONG SECTION SCALES: HORIZONAL 1:250 VERTICAL 1:125 (2x)

Set Out Table for DL – CONC RWALL C – BOW – HA									
TAG		CHAINAGE	EASTING	NORTHING	LENGTH	RADIUS	BEARING		
L23	START END	0.00 6.50	310340.135 310333.634	5819199.288 5819199.249	6.50		269° 39′ 23″		
L24	START END	6.50 14.30	310333.634 310333.587	5819199.249 5819207.049	7.80		359° 39′ 15″		
L25	START END	14.30 20.79	310333.587 310340.078	5819207.049 5819207.088	6.49		089° 39′ 15″		



O 30.09.21 ISSUED FOR CONSTRUCTION

Revision Date Reason

Disclaimer:

Disclai

Note for Contractors

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refer to C-8022 for Construction details







15019 CJA 7C

CIVIL SITEWORKS

MELBOURNE
T: (03) 9285 2800 | E: info@cjarms.com | W: www.cjarms.com

Project
RIVER VALLEY - STAGE 7C

Client
YOURLAND
Purpose of Issue

ISSUED FOR CONSTRUCTION

Project Number Origin

Zone

Level File Type

Role

Number Revision

DR

4003



AL- RIVER VALLEY BLVD - CL - HA - LONG SECTION SCALES: HORIZONAL 1:500 VERTICAL 1:50 (10x)

0 30.09.21 ISSUED FOR CONSTRUCTION
Revision Date Reason

drawing.

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DENOTES ENGINEERED FILL TO T+T TYPE 2 SPECIFICATION (1000780.1000.S1.REV4) AND PREPARED UNDER LEVEL 1 SUPERVISION. (AS PART OF EARLY WORKS).


DENOTES EXTENT OF CUT ( AS PART OF EARLY WORKS)





MELBOURNE T: (03) 9285 2800 | E:info@cjarms.com | W:www.cjarms.com Project RIVER VALLEY - STAGE 7C YOURLAND

Drawing Title
LONG SECTION - RIVER VALLEY BLVD ISSUED FOR CONSTRUCTION 1:500H, 1:50V @ A1 17.04.20 15019 CJA 7C XX DR 5000

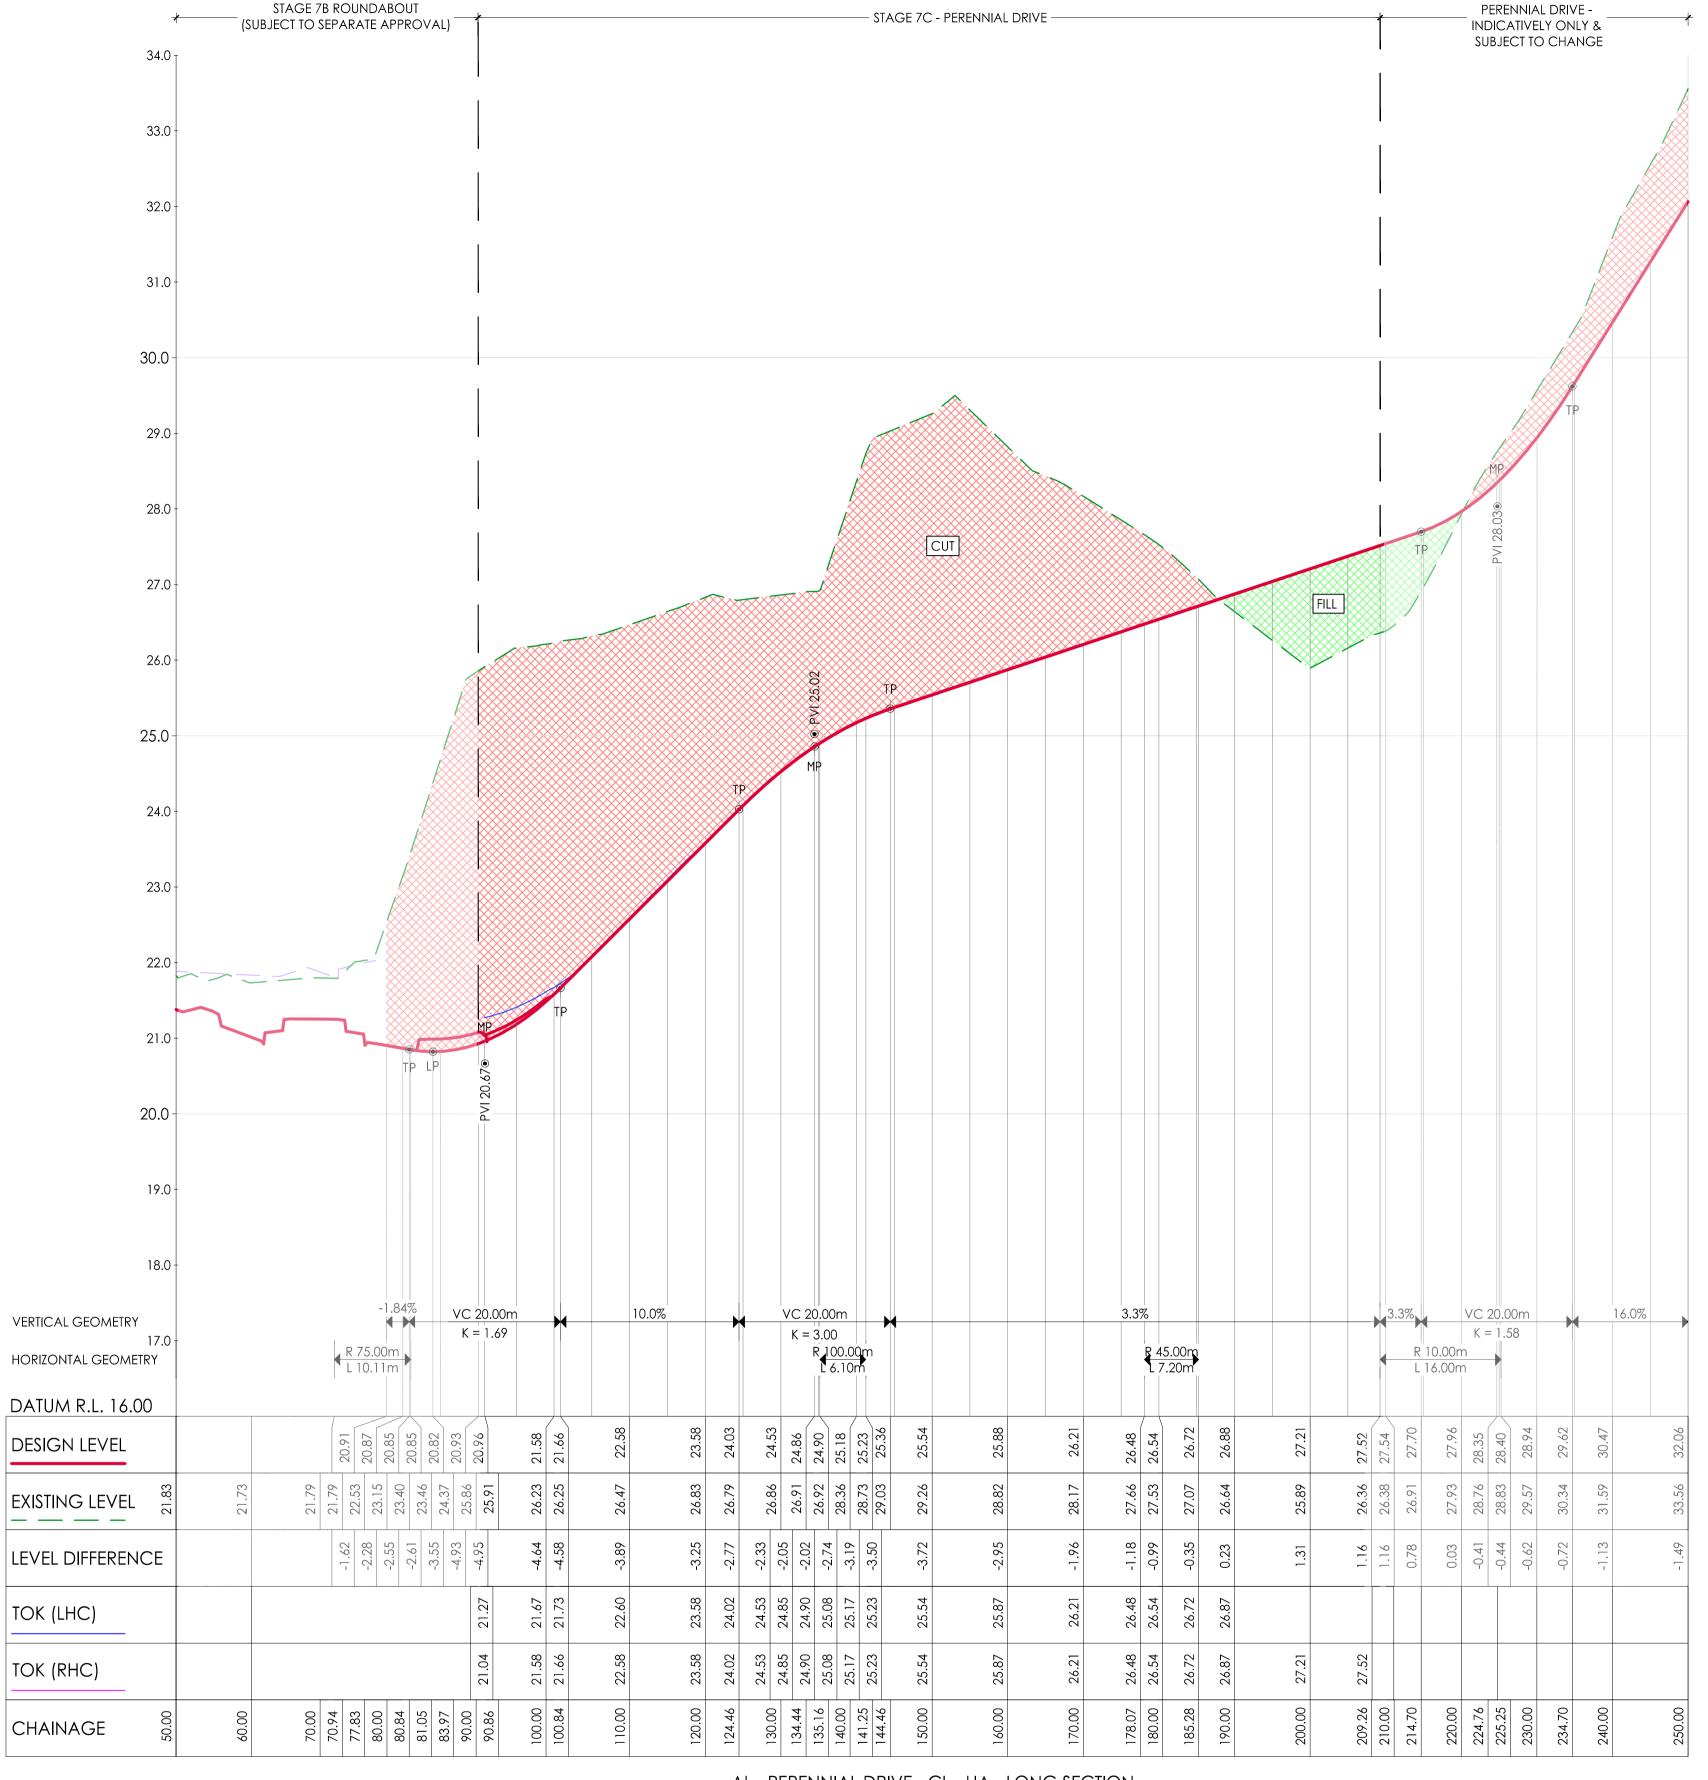


AL - PERENNIAL DRIVE - CL - HA - LONG SECTION SCALES: HORIZONAL 1:500 VERTICAL 1:50 (10x)

EXTENT OF CENTRELINE CONSTRUCTION BRIMBANK CITY COUNCIL **Engineering Services** APPROVED PLANS AND SPECIFICATIONS Vikramt 01 Oct 2021 EXTENT OF CENTRELINE CONSTRUCTION (CH 90.86) SCALE 1:500

INDICATIVE STAGE 7E LAYOUT SHOWN FOR ILLUSTRATIVE PURPOSED ONLY (SUBJECT TO CHANGE)

Set Out Table for AL - PERENNIAL DRIVE - CL - HA								
TAG		CHAINAGE	EASTING	NORTHING	LENGTH	RADIUS	BEARING	
Lll	START END	81.05 135.16	310349.295 310349.032	5819167.409 5819221.519	54.11		359° 43′ 17″	
C13	TP IP TP	135.16 138.21 141.25	310349.032 310349.017 310348.817	5819221.519 5819224.568 5819227.610	6.10	100.0	357° 58' 31.23'	
L1	START END	141.25 178.07	310348.817 310346.395	5819227.610 5819264.352	36.82		356° 13′ 45″	
C14	TP IP TP	178.07 181.68 185.28	310346.395 310346.158 310346.498	5819264.352 5819267.954 5819271.548	7.20	45.0	000° 48' 55.42'	
L2	START END	185.28 209.26	310346.498 310348.755	5819271.548 5819295.418	23.98		005° 24′ 06″	

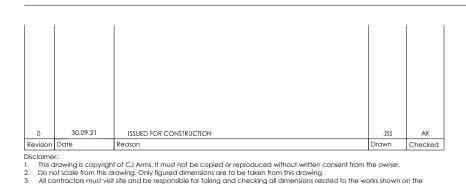

drawing.

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DENOTES EXTENT OF CUT ( AS PART OF EARLY WORKS)



FUTURE STAGE 7E -





15019 CJA 7C

Project RIVER VALLEY - STAGE 7C Drawing Title
LONG SECTION - PERENNIAL DRIVE Client YOURLAND ISSUED FOR CONSTRUCTION 1:500H 1:50V @ A1 17.04.20

DR


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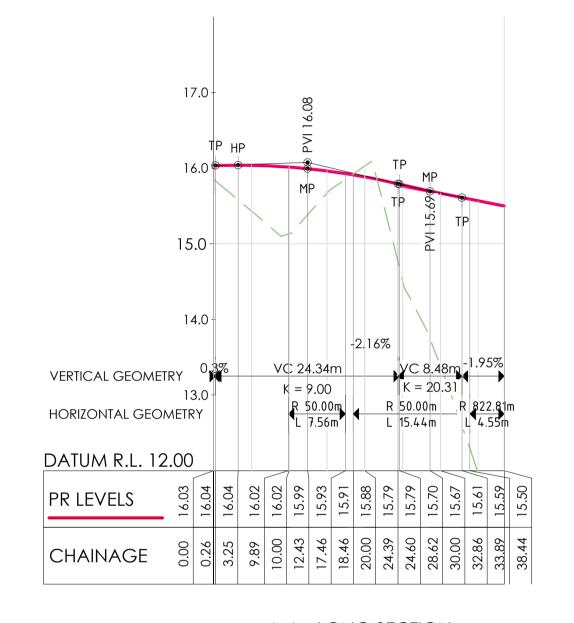
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ISSUED FOR CONSTRUCTION


	Set Out Table for A-A									
TAG		CHAINAGE	EASTING	NORTHING	LENGTH	RADIUS	BEARING			
L22	START END	0.00 9.89	310438.662 310438.999	5819194.350 5819204.236	9.89		001° 57′ 22″			
C34	TP IP TP	9.89 13.68 17.46	310438.999 310439.129 310438.686	5819204.236 5819208.023 5819211.787	7.56	50.0	357° 37' 20.69"			
L23	START END	17.46 18.46			1.00		353° 17′ 19″			
C35	5 IP 26.24 310437.660 5		5819212.780 5819220.507 5819228.146	15.44	50.0	002° 08' 01.16"				
C36	TP IP TP	33.89 36.17 38.44	310439.142 310439.575 310440.020	5819228.146 5819230.378 5819232.609	4.55	822.8	011° 08' 13.55"			


	13.68 17.46	310439.129 310438.686	5819208.023 5819211.787	7.56	50.0	357° 37' 20.69''
RT )	17.46 18.46	310438.686 310438.569		1.00		353° 17′ 19″
	18.46 26.24 33.89	310438.569 310437.660 310439.142		15.44	50.0	002° 08' 01.16"
	33.89 36.17 38.44	310439.575	5819228.146 5819230.378 5819232.609	4.55	822.8	011° 08' 13.55"



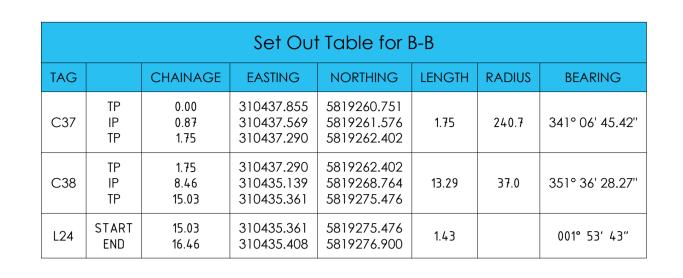

A-A - LONG SECTION SCALES: HORIZONAL 1:500 VERTICAL 1:50 (10x)

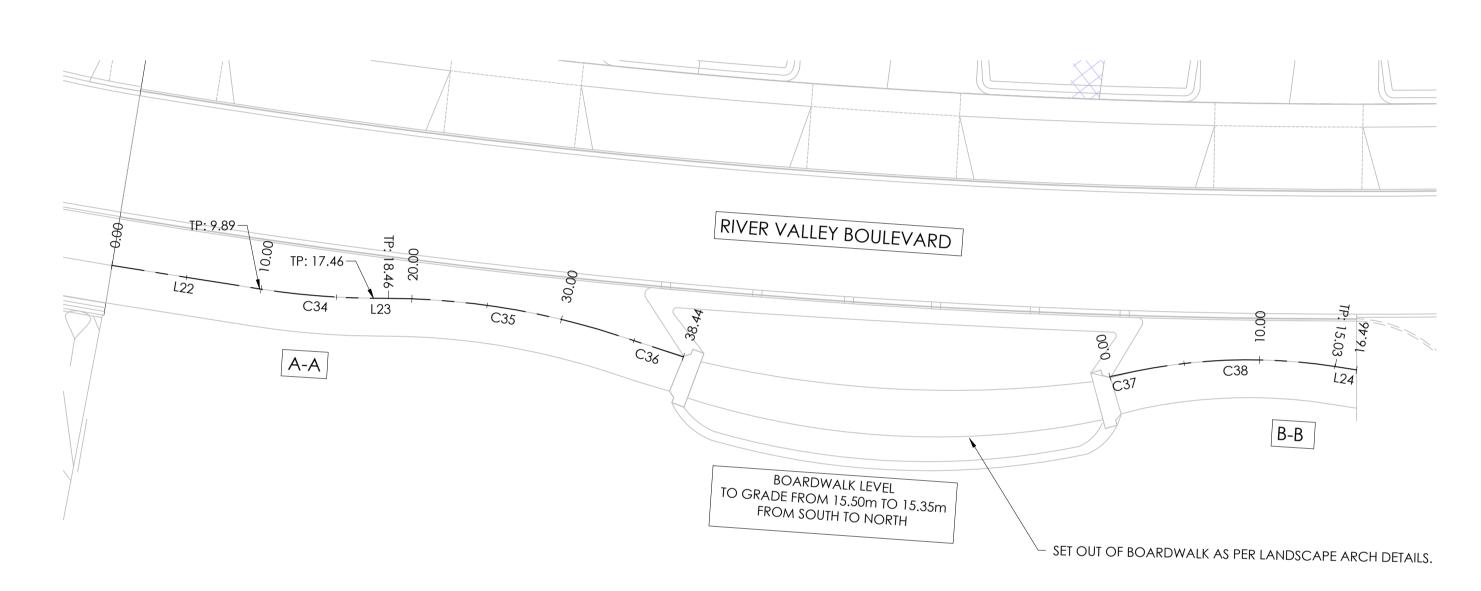

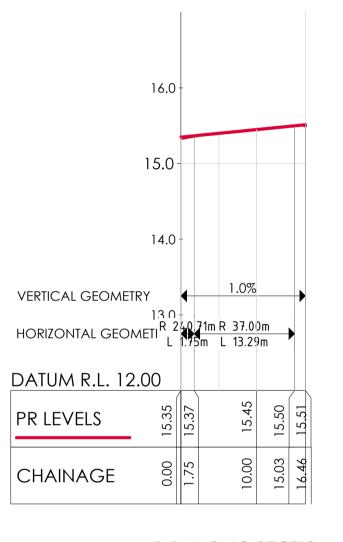

B-B - LONG SECTION SCALES: HORIZONAL 1:500 VERTICAL 1:50 (10x)



drawing prior to fabrication or setting out.

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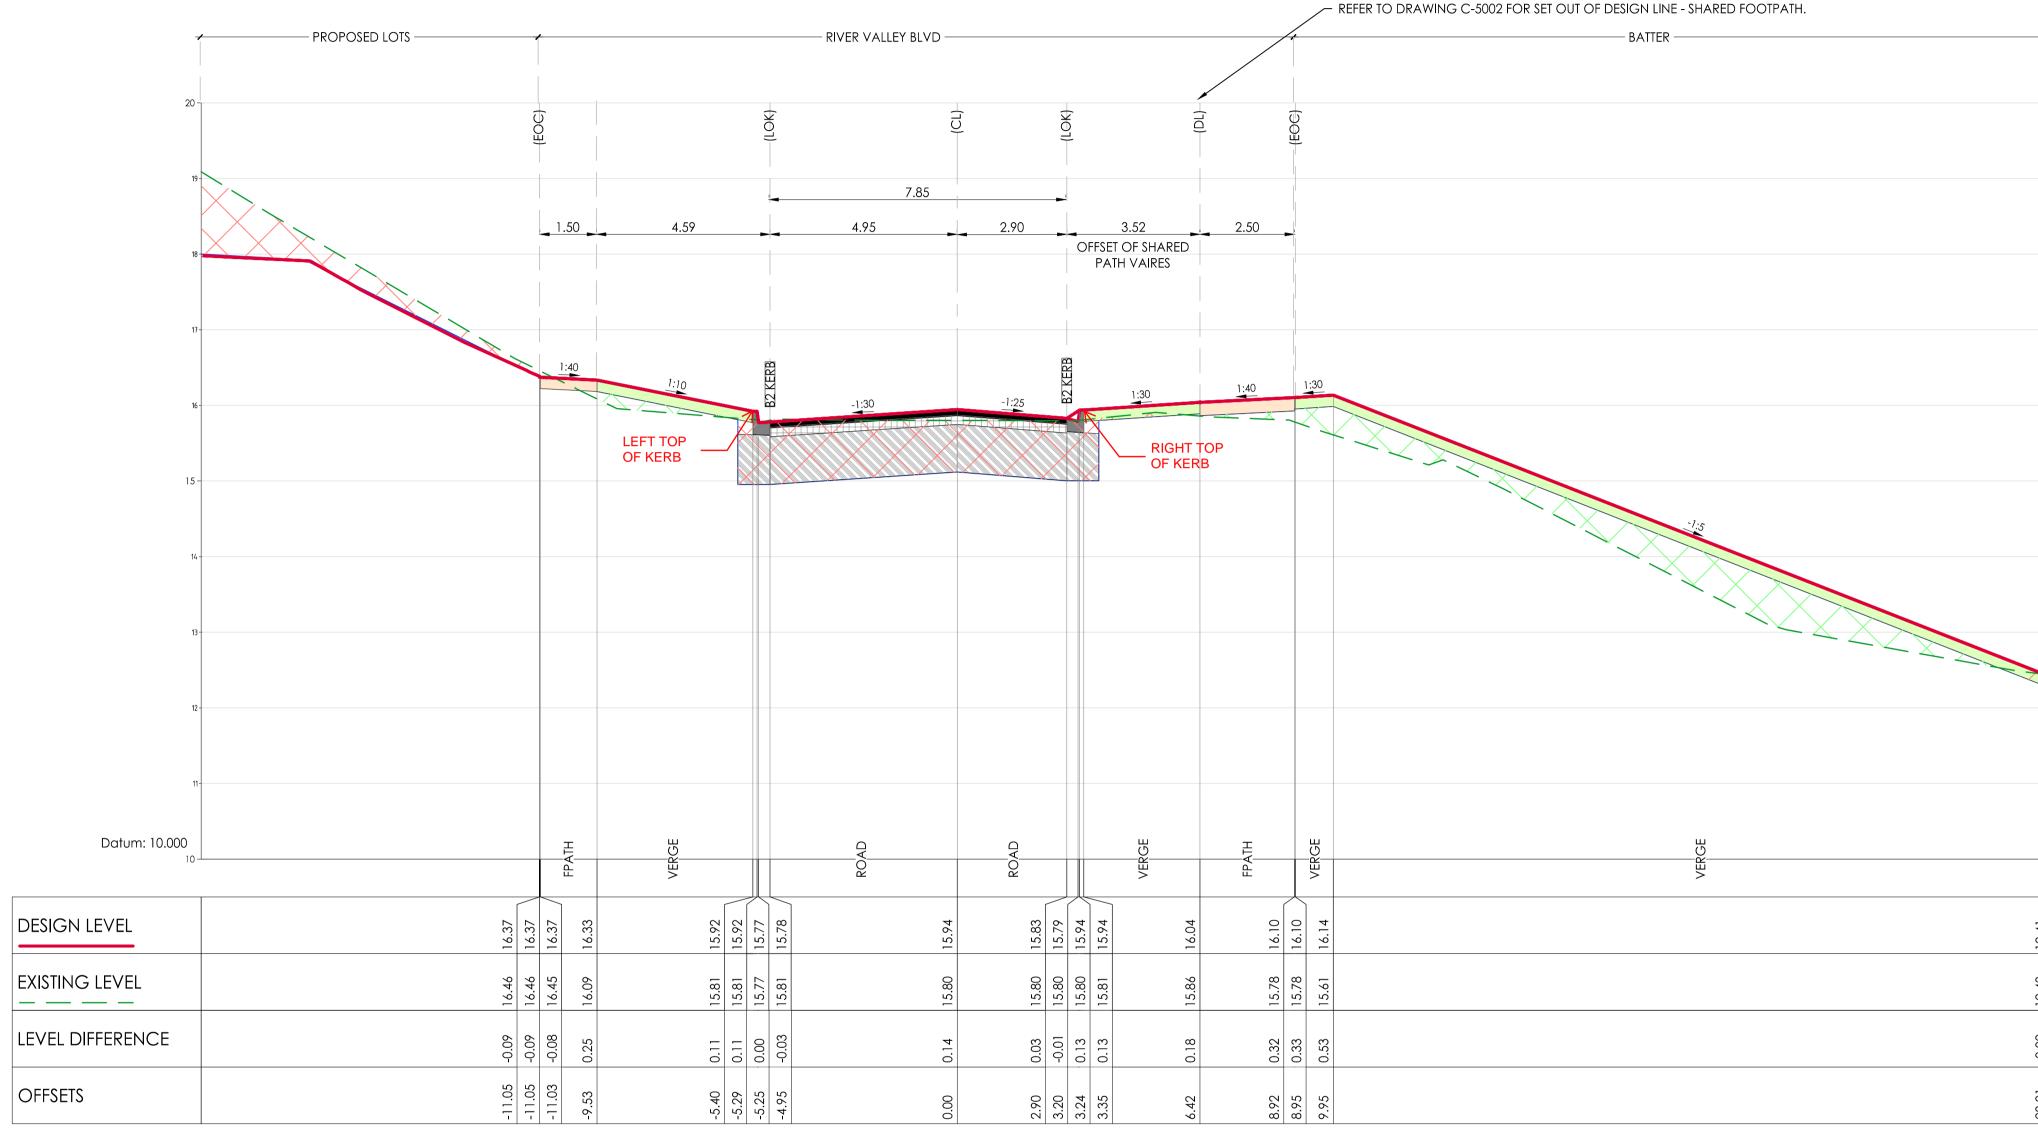




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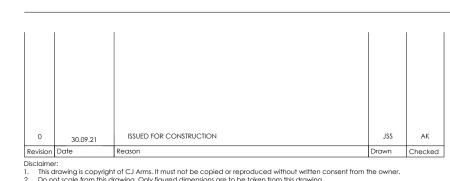
	CIVIL SITEWORKS  MELBOURNE T: (03) 9285 2800   E: info@cjarms.com   W: www.cjarms.com	
Project RIVER V	ALLEY - STAGE 7C	Drawing Title LONG SECTION - S
VOLIDI A	MD	

- SHARED PATH YOURLAND
Purpose of Issue Drawn Scale Date of First Issue ISSUED FOR CONSTRUCTION 1:500H 1:50V @ A1 31.03.21 15019 CJA 7C DR 5002



> KEY PLAN RIVER VALLEY BOULEVARD - DESIGN LINE SCALE 1:1000 Ch: 89.158 <u>Ch: 76.355</u> Ch:/63.568 85 <u>C</u>h: 52.218 85 Ch: 49-364 85

AL - RVB - CL - HA CHAINAGE 39.32 SCALE HORIZ. 1:100 SCALE VERT. 1:50 (X2)



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DENOTES ENGINEERED FILL TO T+T TYPE 2 SPECIFICATION (1000780.1000.\$1.REV4) AND PREPARED UNDER LEVEL 1 SUPERVISION. (AS PART OF EARLY WORKS).

DENOTES EXTENT OF CUT ( AS PART OF EARLY WORKS)





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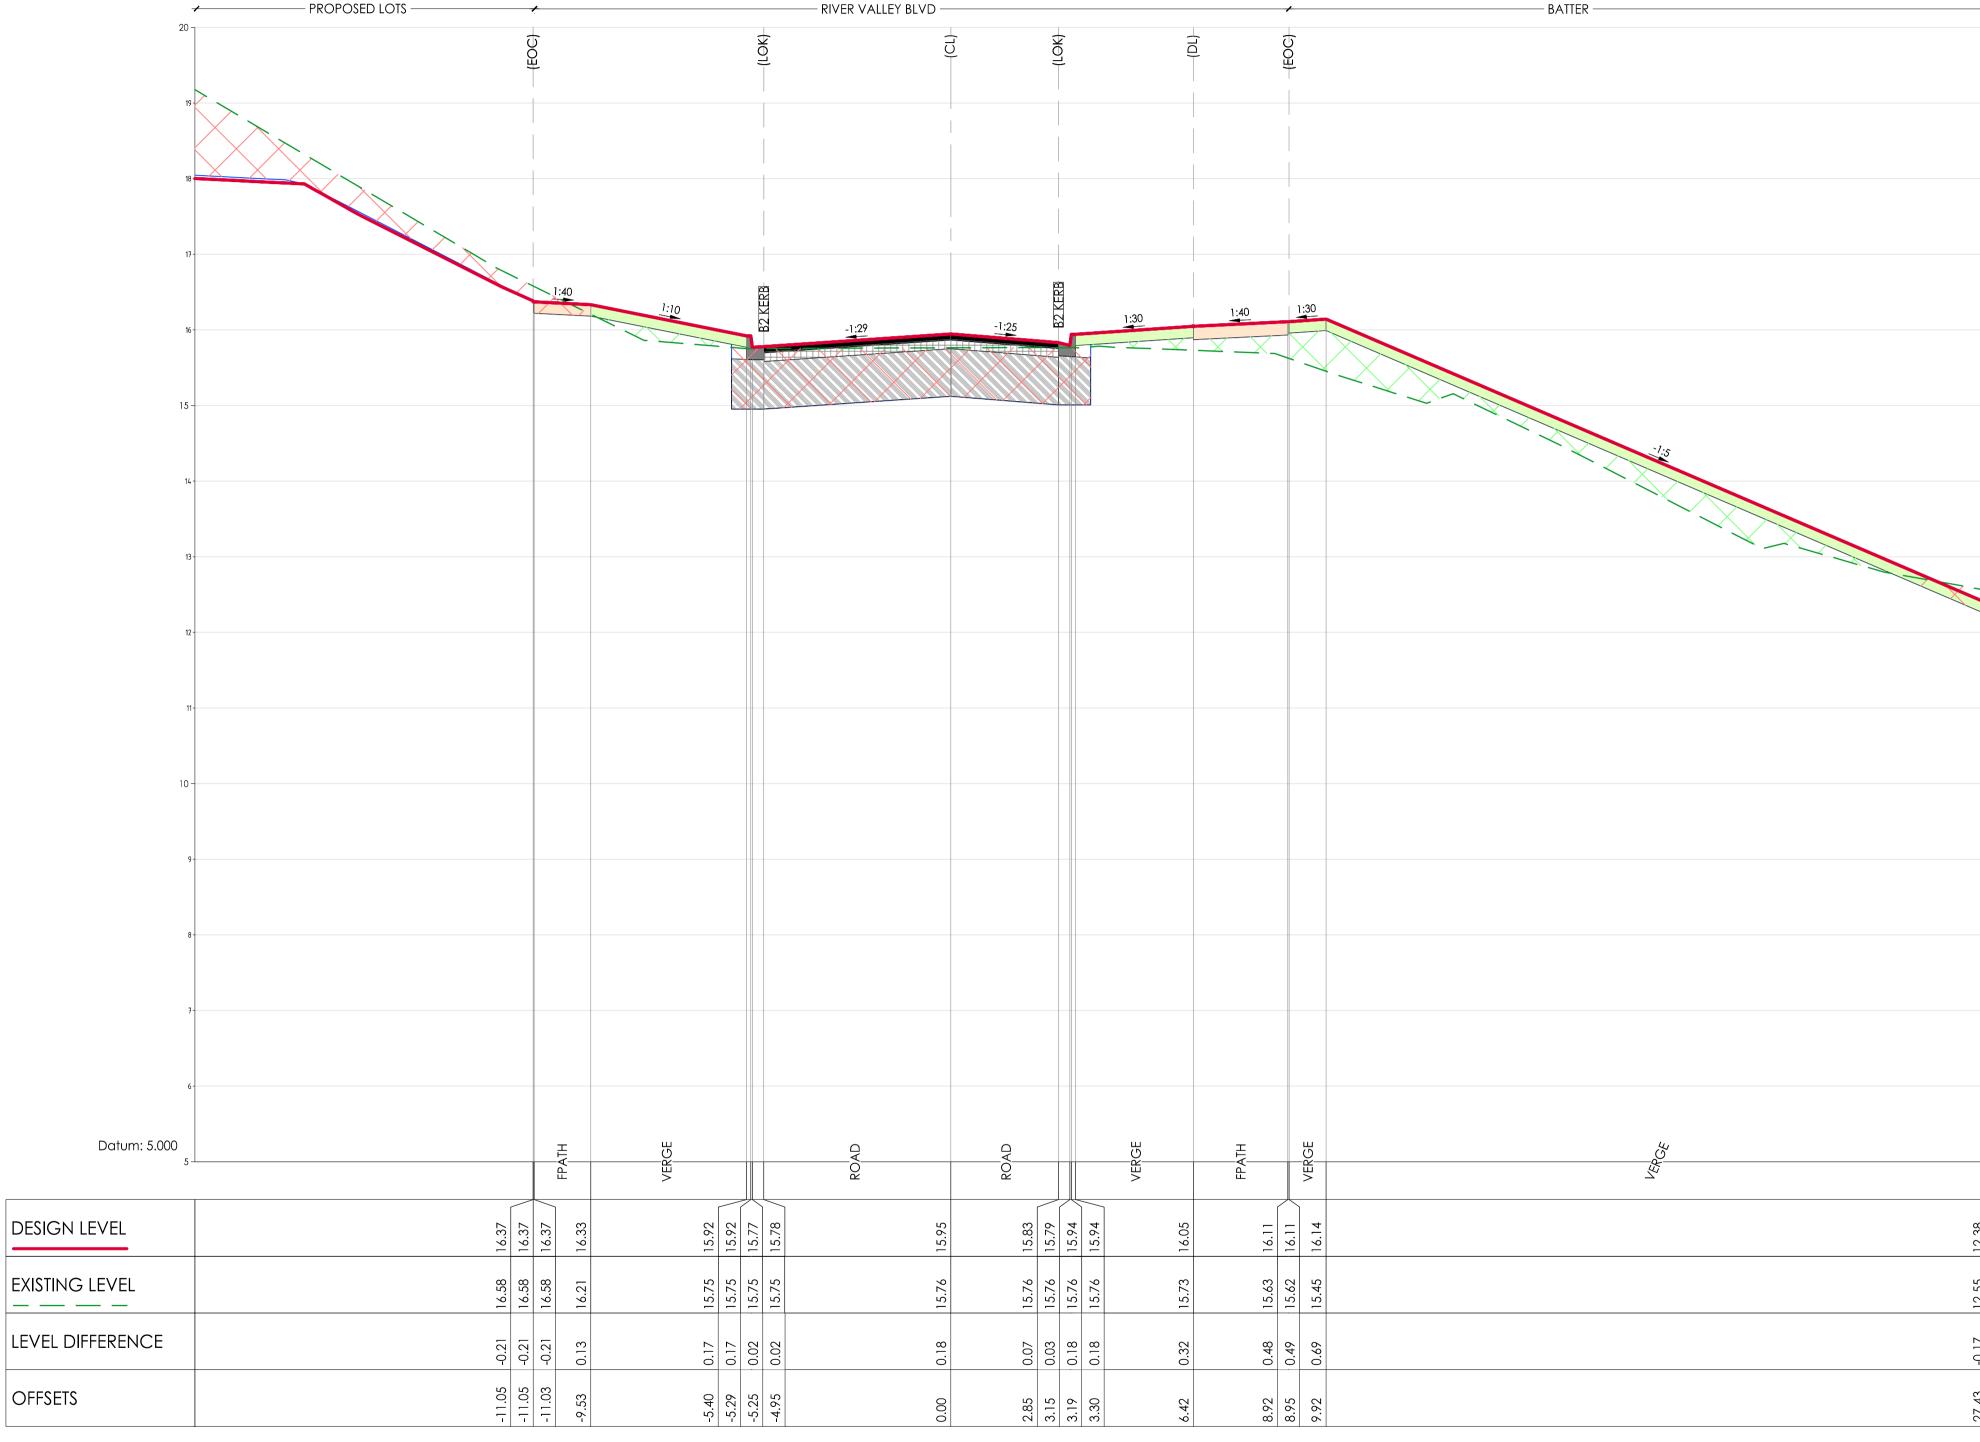



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DR

5100


15019 CJA 7C



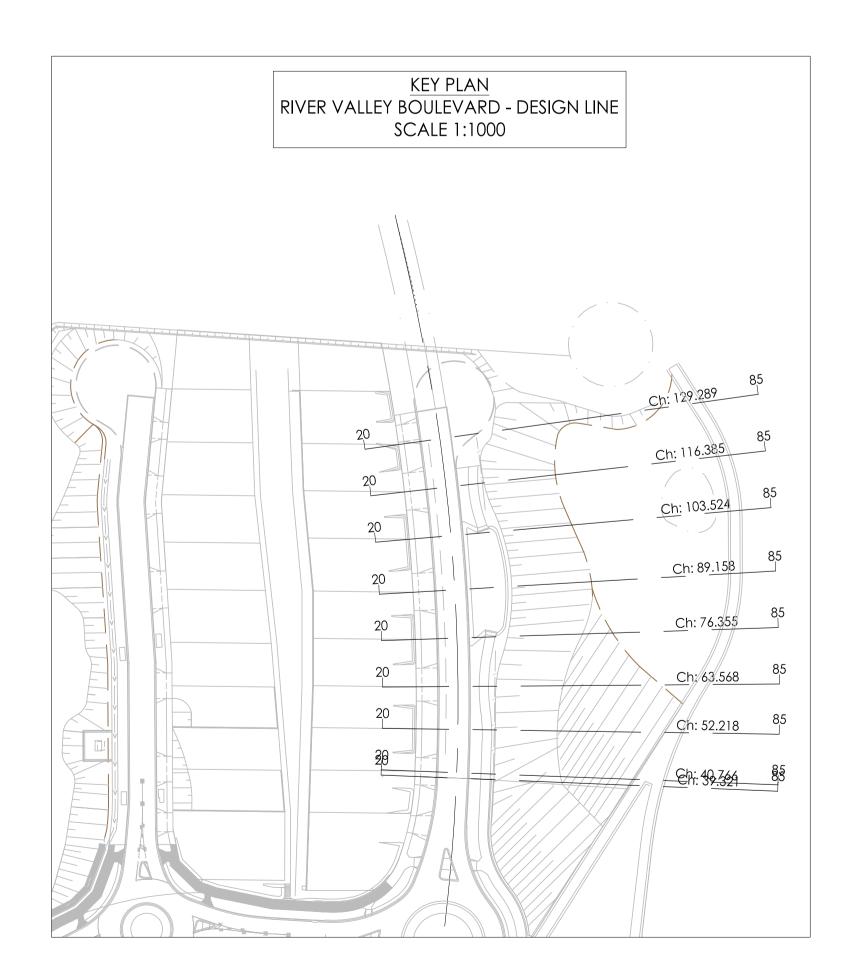

AL - RVB - CL - HA CHAINAGE 40.77

SCALE HORIZ. 1:100 SCALE VERT. 1:50 (X2)

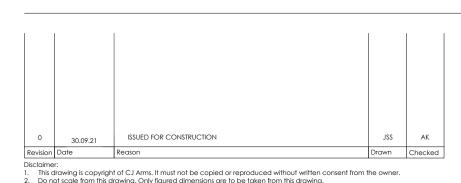

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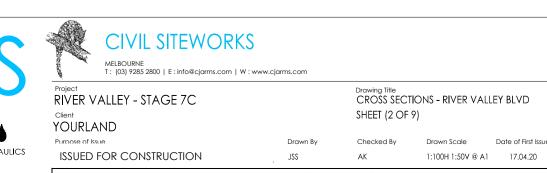
DENOTES ENGINEERED FILL TO T+T TYPE 2 SPECIFICATION (1000780.1000.\$1.REV4) AND PREPARED UNDER LEVEL 1 SUPERVISION. (AS PART OF EARLY WORKS).

DENOTES EXTENT OF CUT ( AS PART OF EARLY WORKS)





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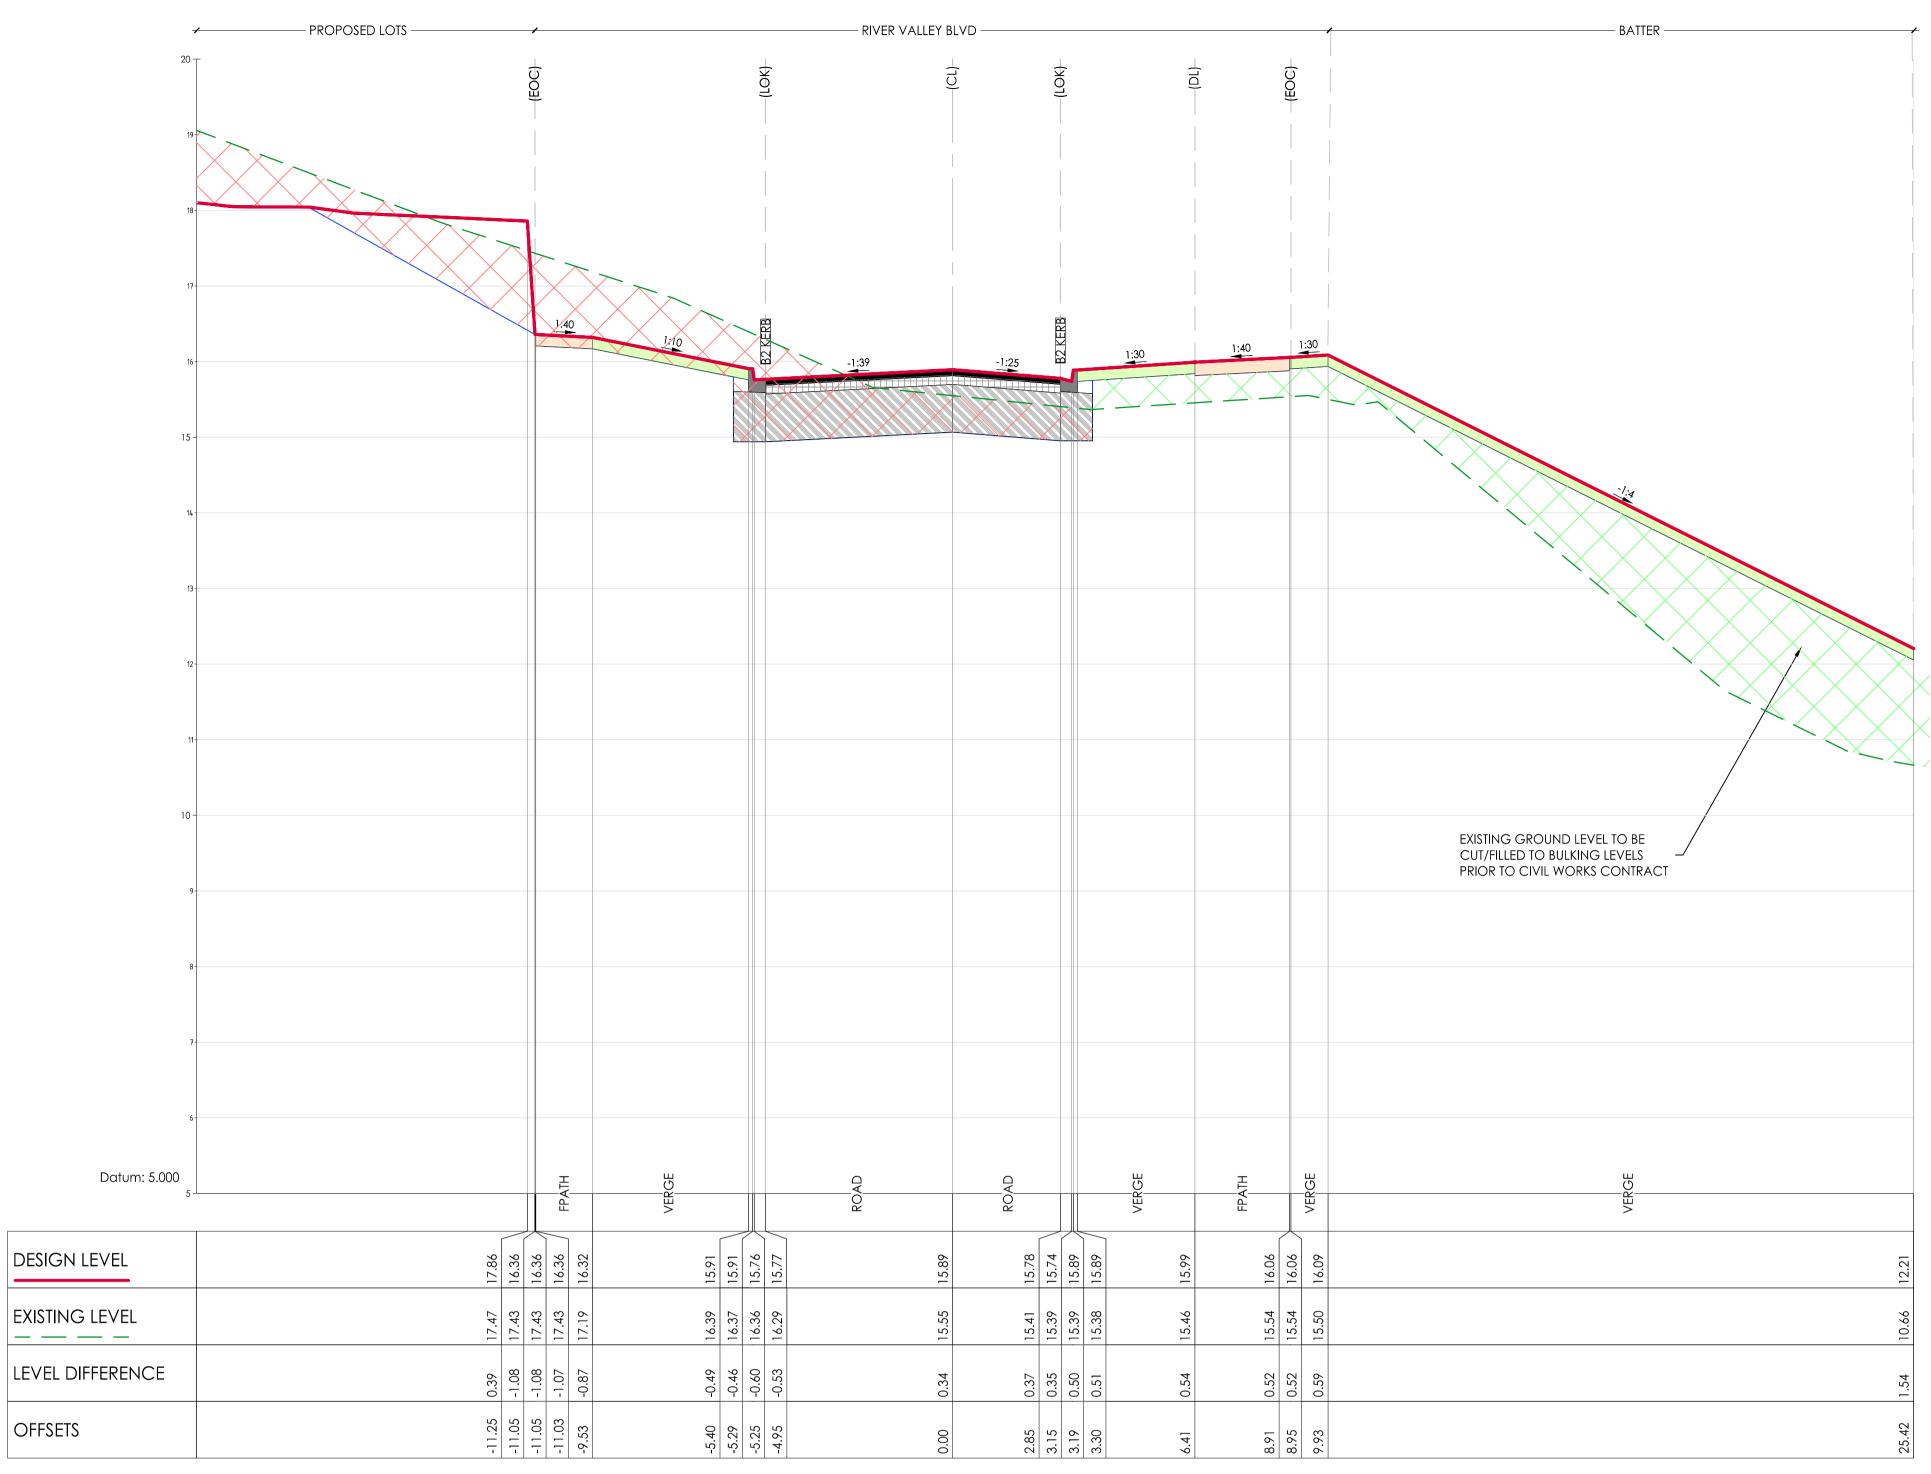


XX

DR


5101


15019 CJA 7C



AL - RVB - CL - HA CHAINAGE 52.22 SCALE HORIZ. 1:100 SCALE VERT. 1:50 (X2)

BRIMBANK CITY COUNCIL **Engineering Services** APPROVED PLANS AND SPECIFICATIONS Vikramt 01 Oct 2021

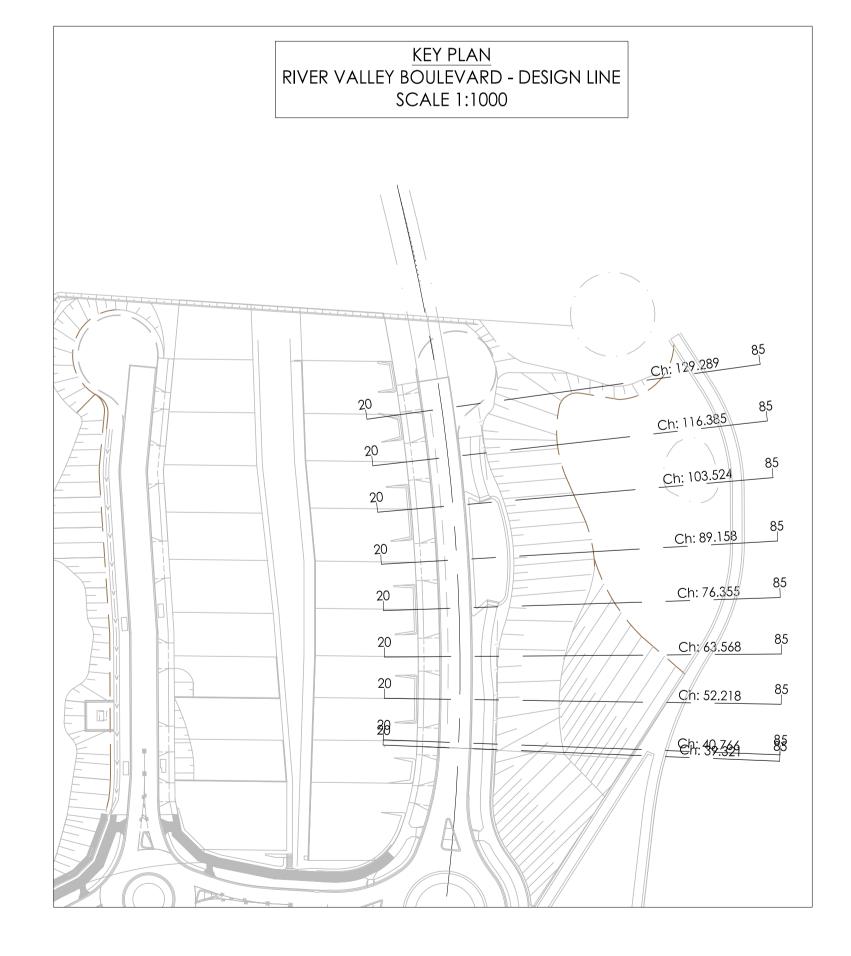

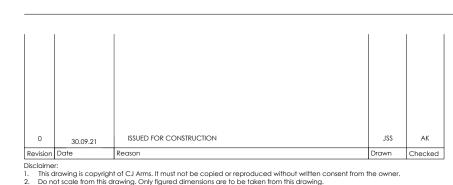

OFFSETS

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DENOTES ENGINEERED FILL TO T+T TYPE 2 SPECIFICATION (1000780.1000.\$1.REV4) AND PREPARED UNDER LEVEL 1 SUPERVISION. (AS PART OF EARLY WORKS).









XX

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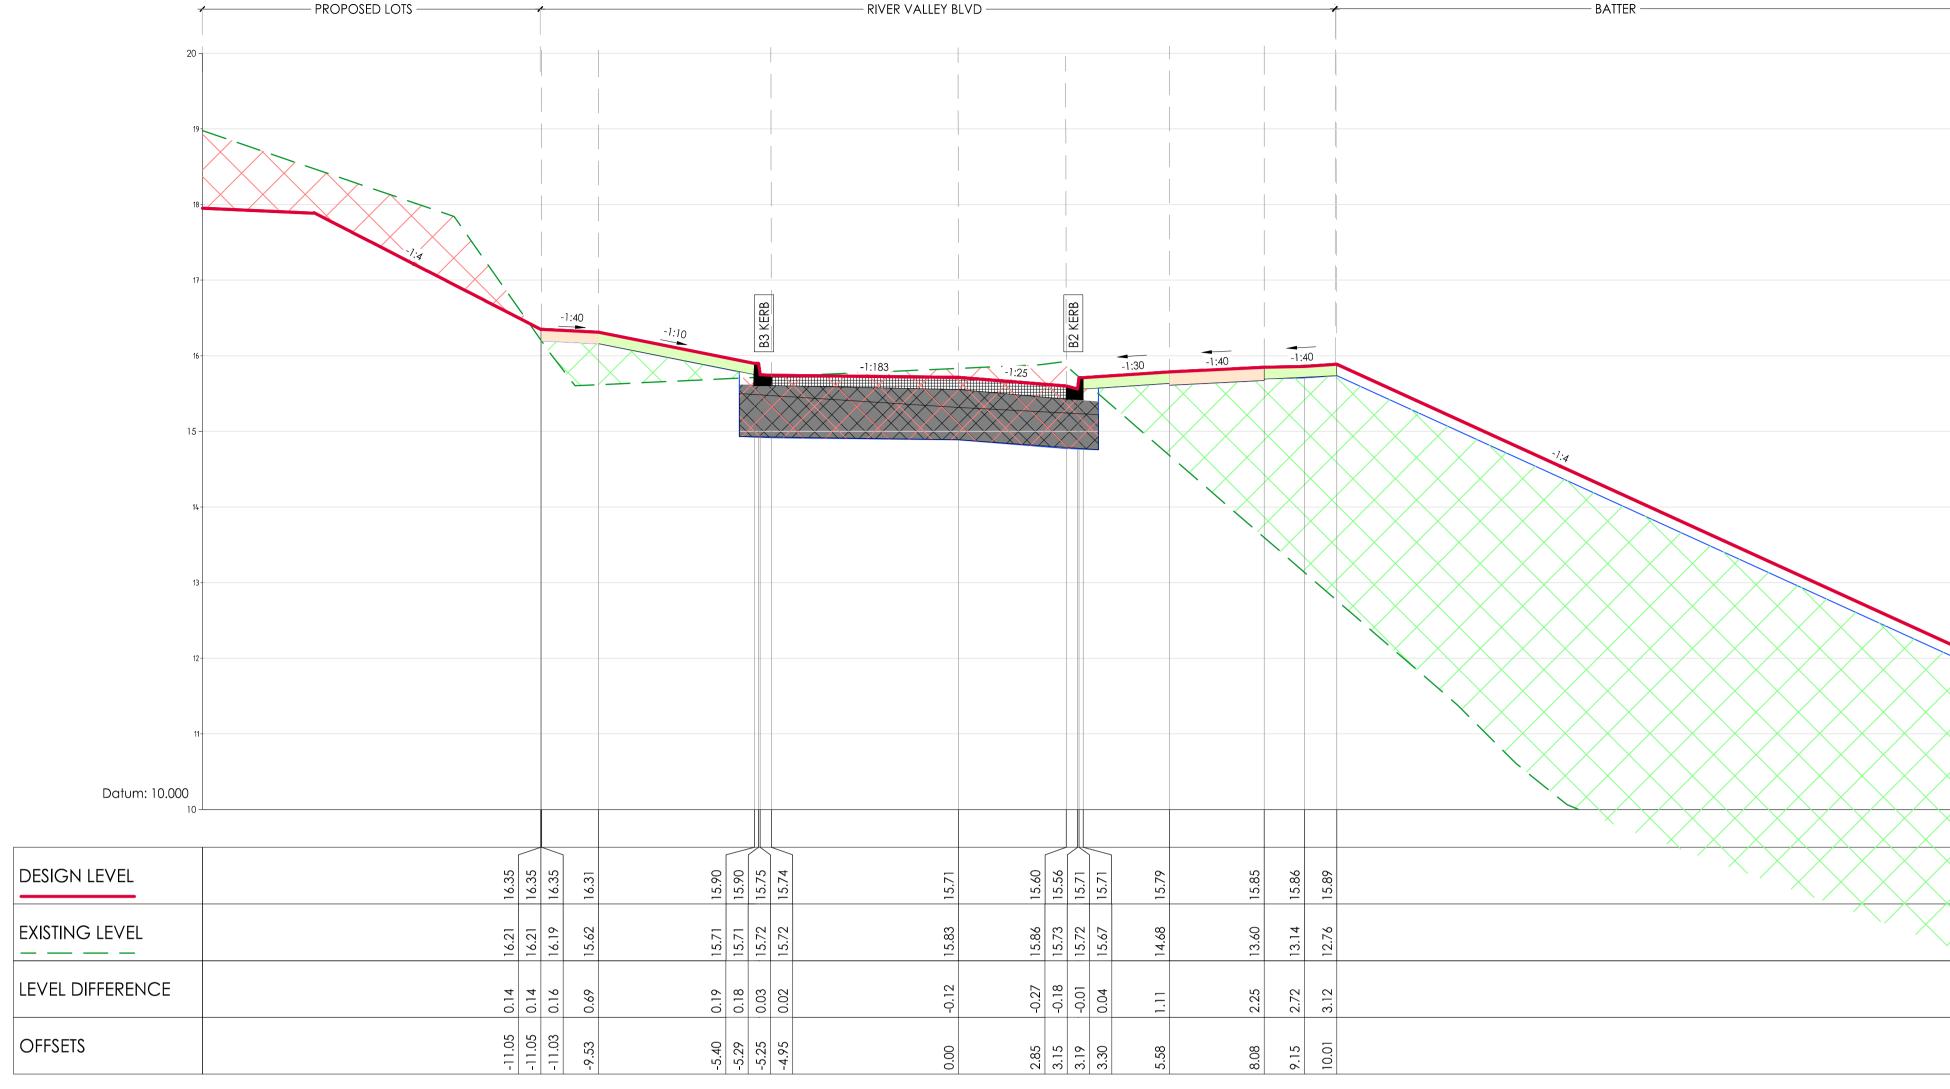
1:100H 1:50V @ A1 17.04.20

Number 5102

ISSUED FOR CONSTRUCTION

15019 CJA 7C


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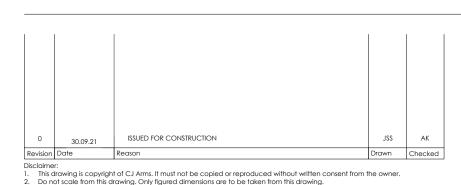


AL - RVB - CL - HA CHAINAGE 63.57

SCALE HORIZ. 1:100 SCALE VERT. 1:50 (X2)

BRIMBANK CITY COUNCIL Engineering Services
APPROVED PLANS AND SPECIFICATIONS Vikramt 01 Oct 2021



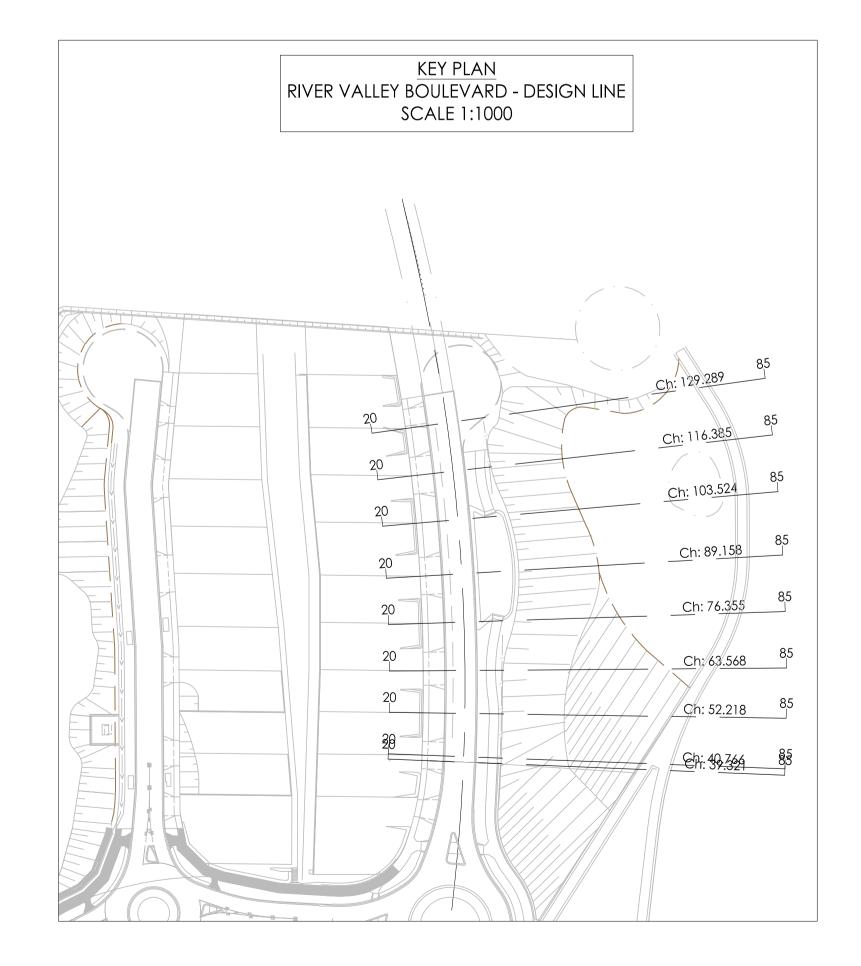

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DENOTES ENGINEERED FILL TO T+T TYPE 2 SPECIFICATION (1000780.1000.S1.REV4) AND PREPARED UNDER LEVEL 1 SUPERVISION. (AS PART OF EARLY WORKS).

DENOTES EXTENT OF CUT ( AS PART OF EARLY WORKS)






www.cjarms.com




15019 CJA 7C

Drawing Title CROSS SECTIONS - RIVER VALLEY BLVD SHEET (4 OF 9) Client YOURLAND ISSUED FOR CONSTRUCTION 1:100H 1:50V @ A1 31.03.21 Number 5103

DR

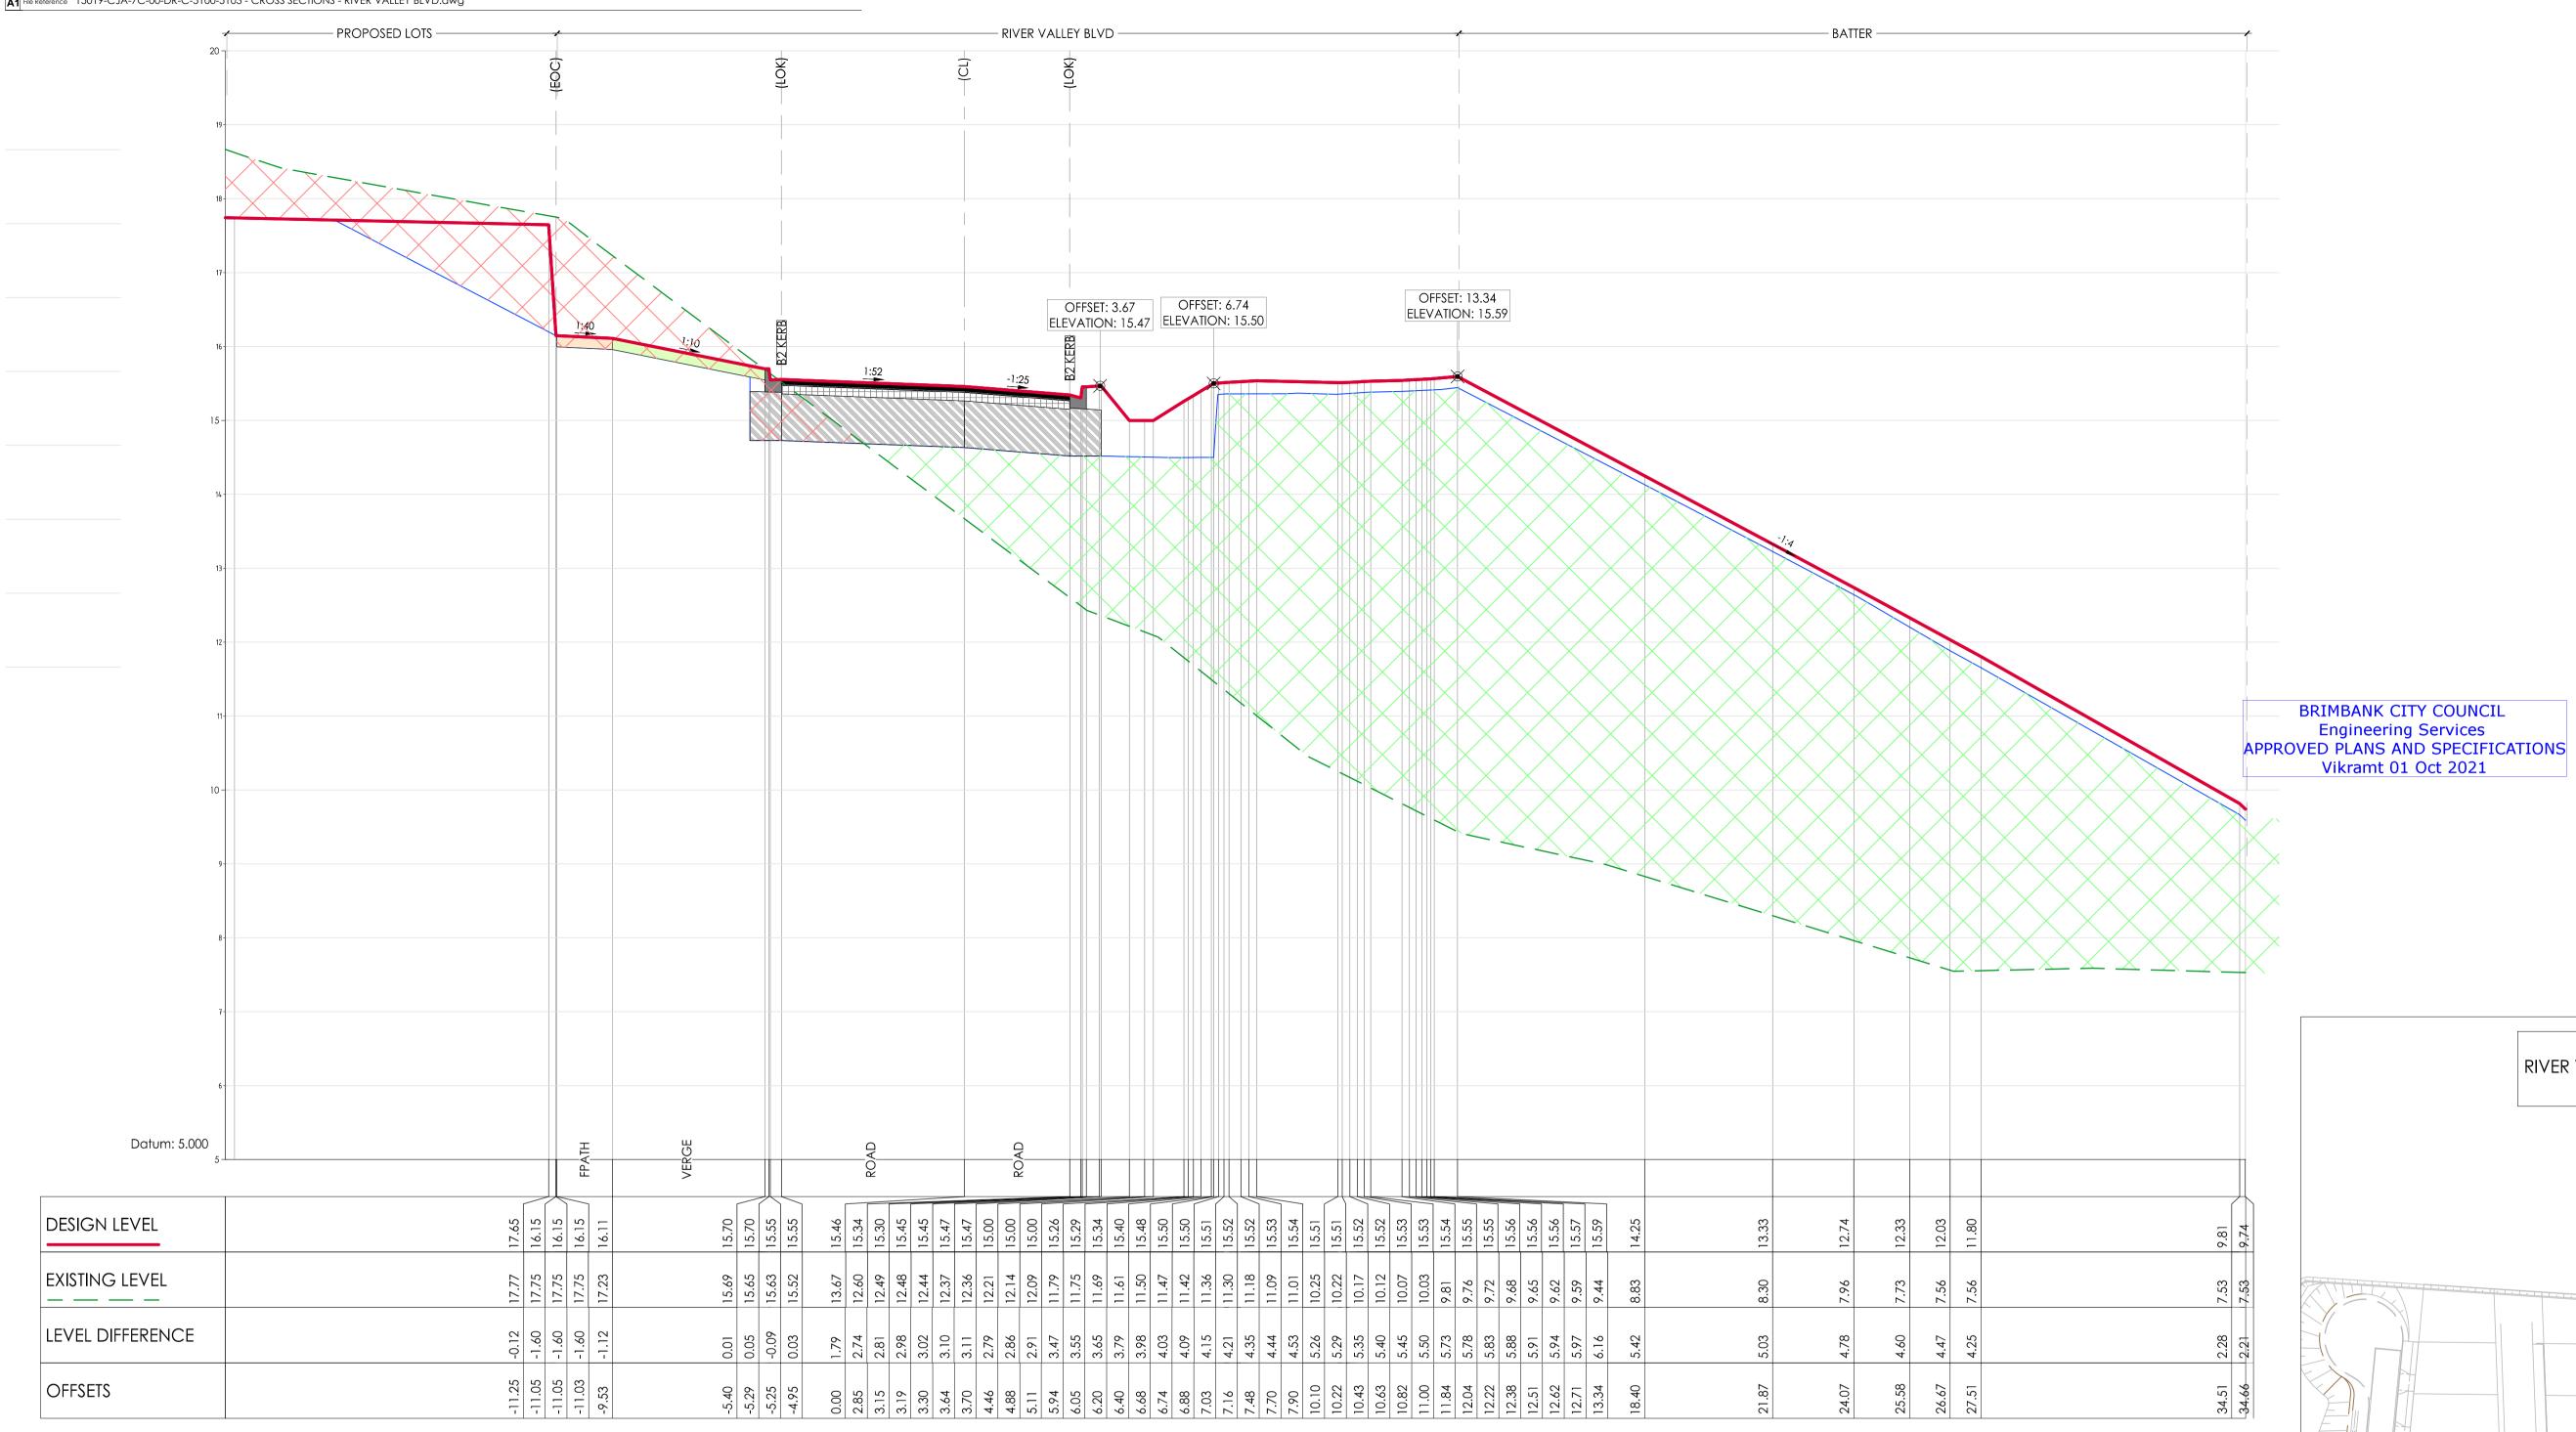

AL - RVB - CL - HA CHAINAGE 76.36 SCALE HORIZ. 1:100 SCALE VERT. 1:50 (X2)

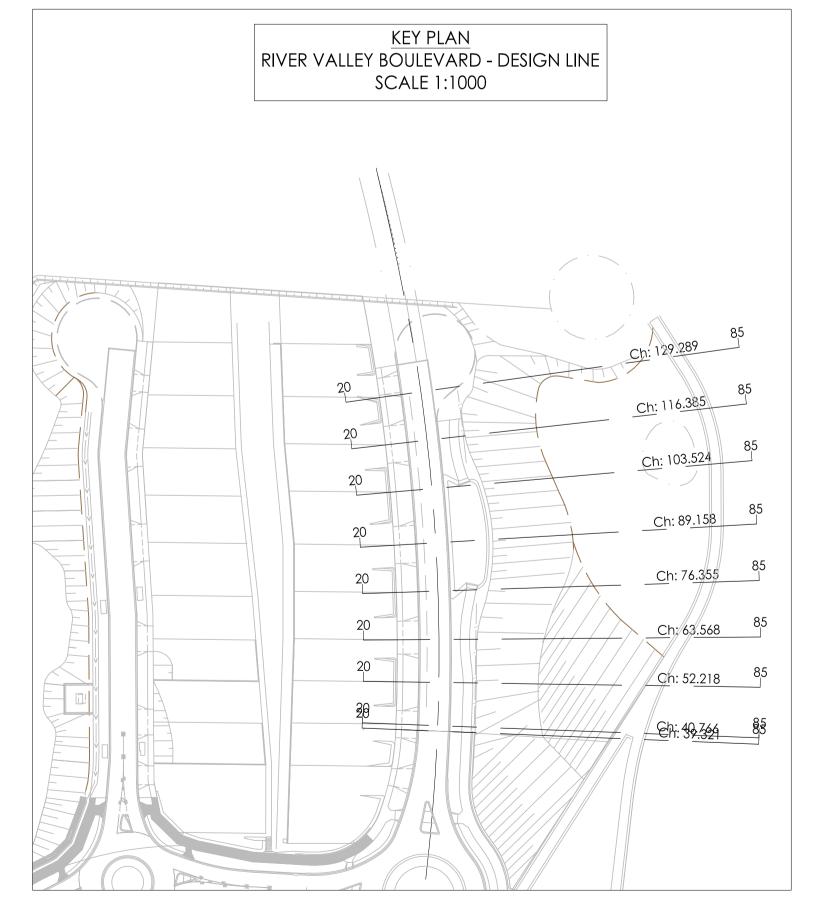

drawing.

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DENOTES EXTENT OF CUT ( AS PART OF EARLY WORKS)






www.cjarms.com

BRIMBANK CITY COUNCIL


Vikramt 01 Oct 2021




Project RIVER VALLEY - STAGE 7C Drawing Title
CROSS SECTIONS - RIVER VALLEY BLVD SHEET (5 OF 9) YOURLAND ISSUED FOR CONSTRUCTION 1:100H 1:50V @ A1 09.04.21 15019 CJA 7C 5104 XX DR

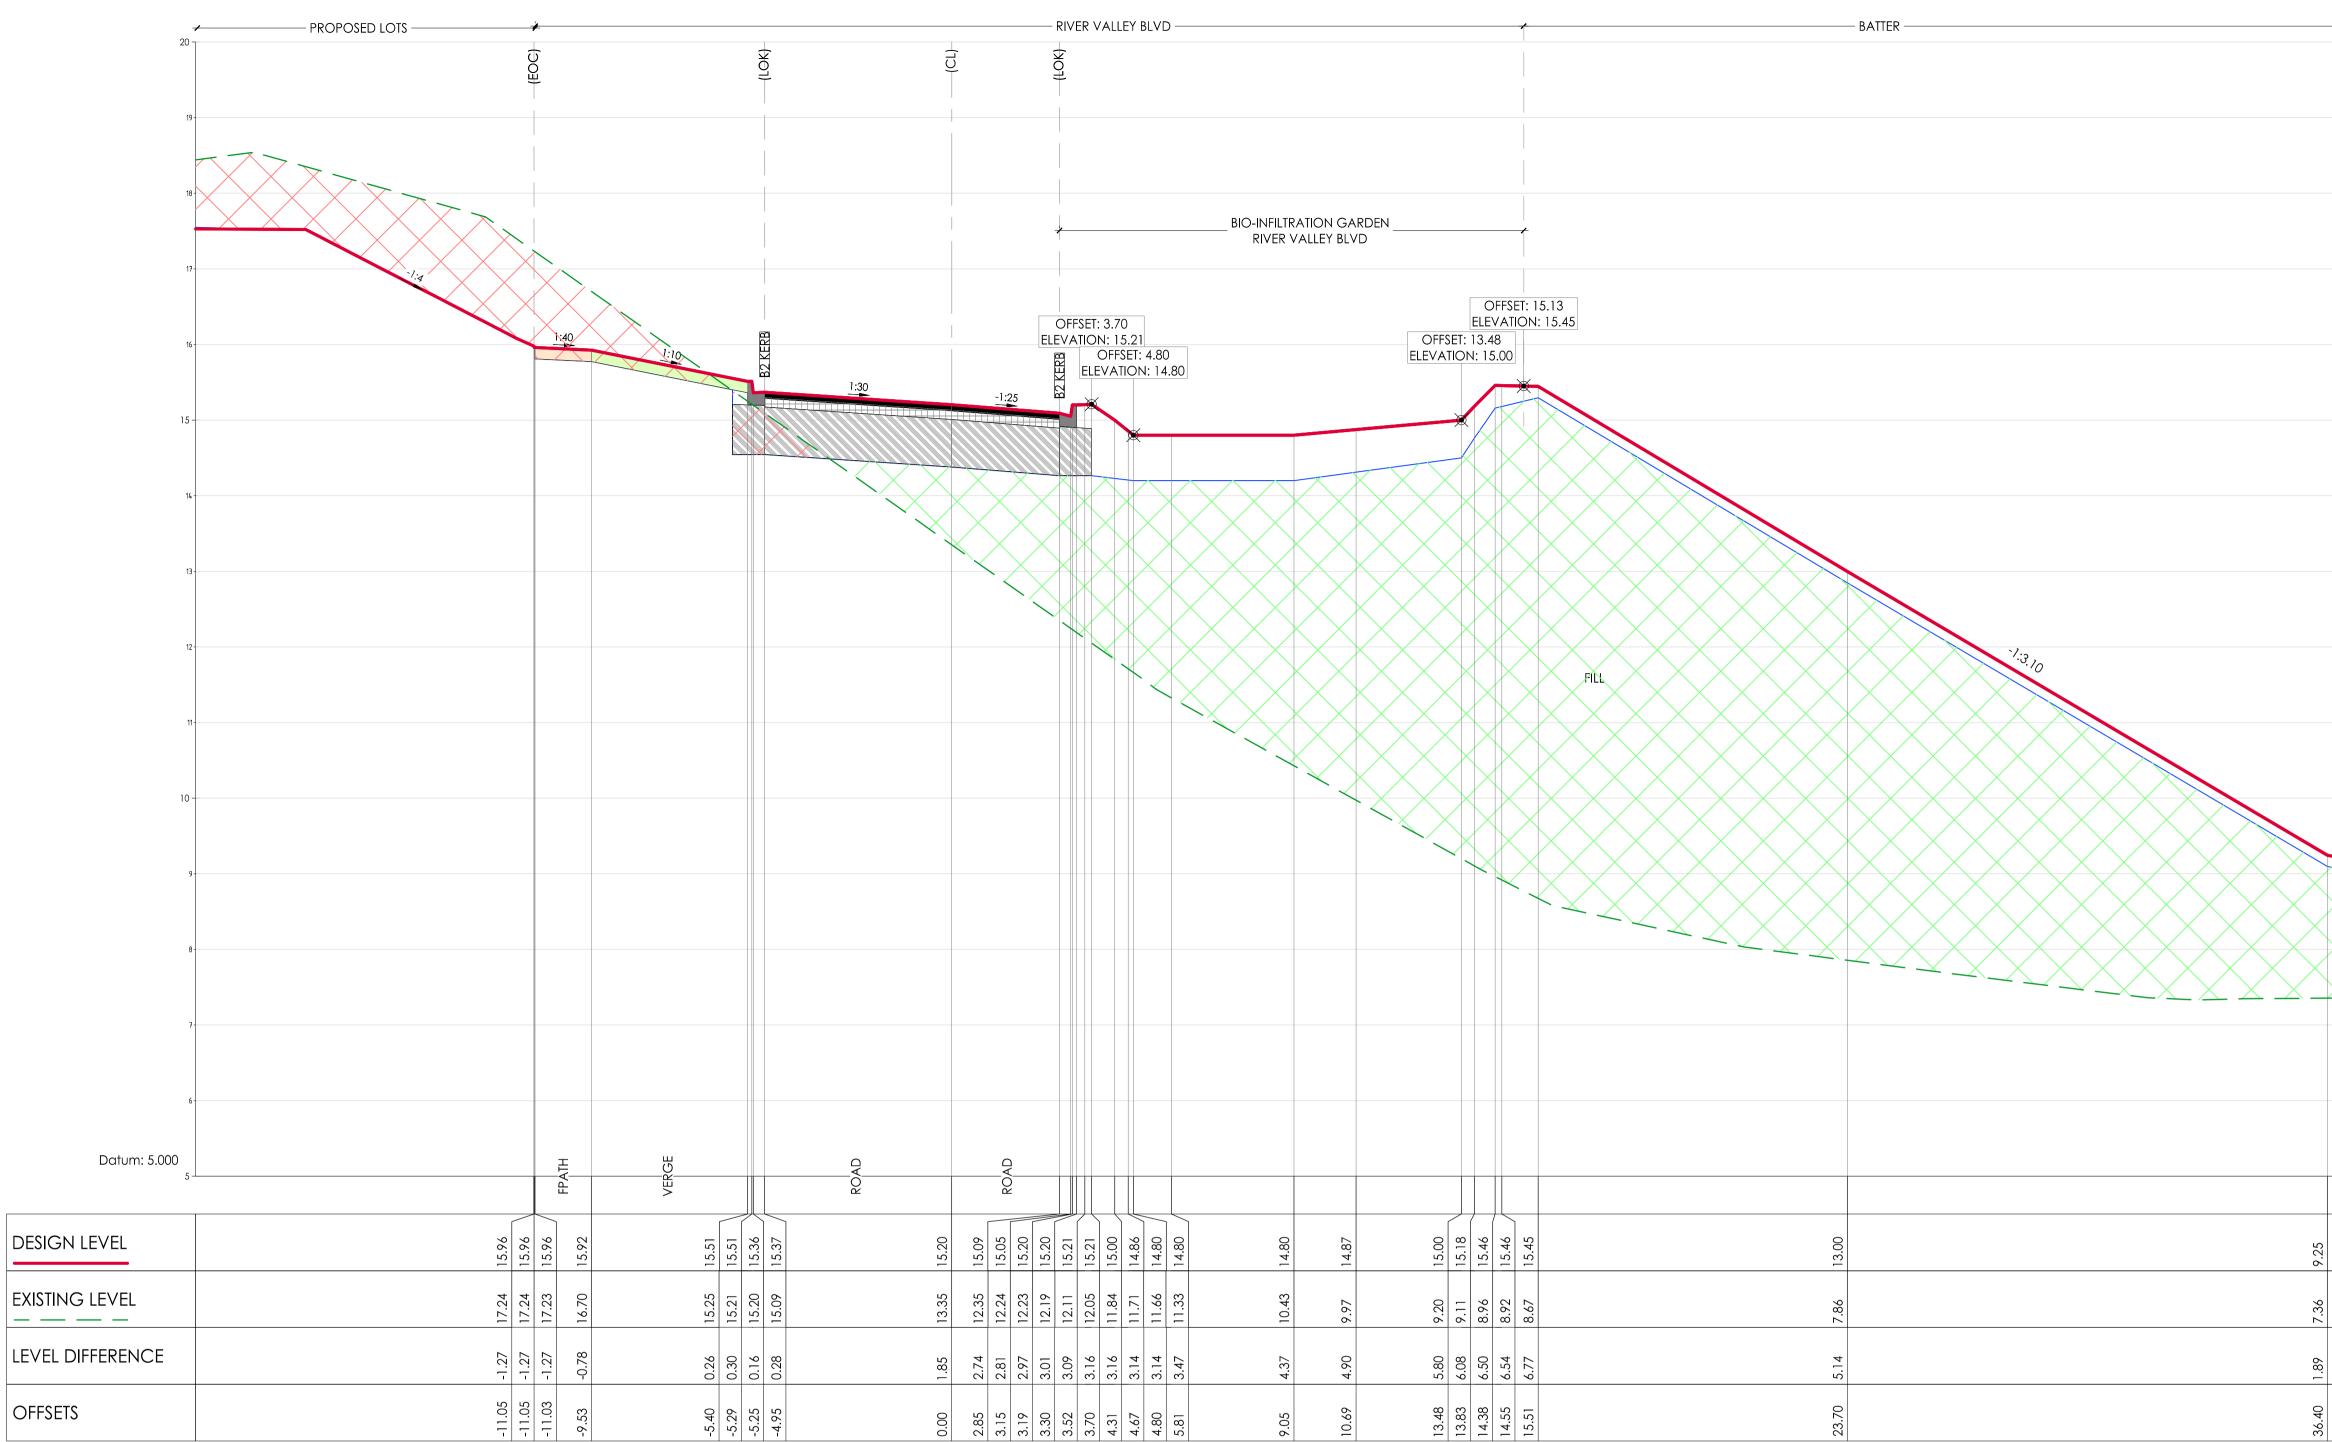

AL - RVB - CL - HA CHAINAGE 89.16 SCALE HORIZ. 1:100 SCALE VERT. 1:50 (X2)

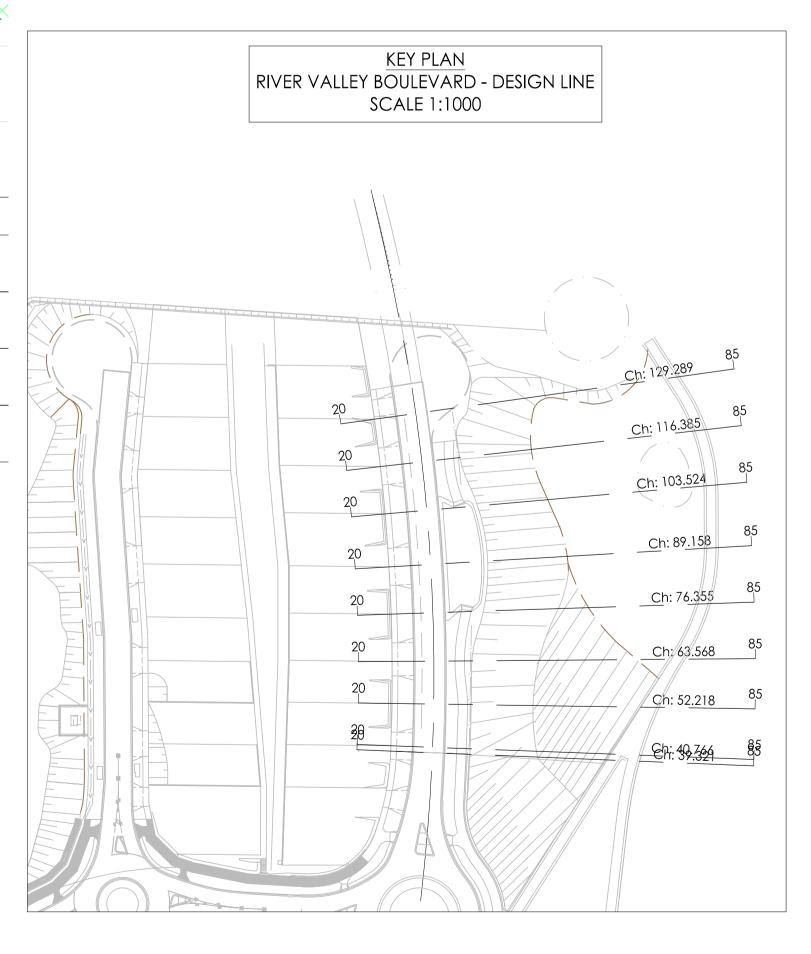

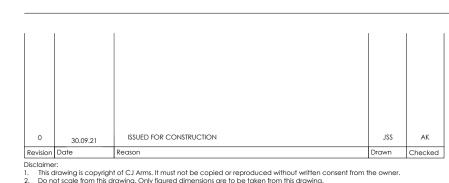

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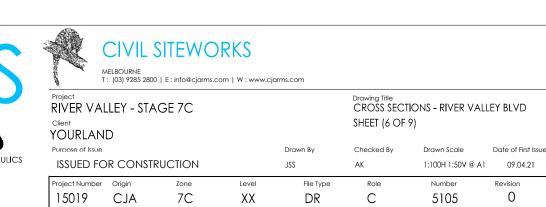
DENOTES ENGINEERED FILL TO T+T TYPE 2 SPECIFICATION (1000780.1000.\$1.REV4) AND PREPARED UNDER LEVEL 1 SUPERVISION. (AS PART OF EARLY WORKS).

DENOTES EXTENT OF CUT ( AS PART OF EARLY WORKS)






www.cjarms.com



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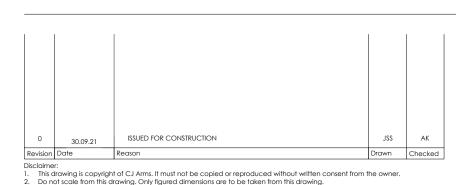
15019 CJA 7C



> KEY PLAN RIVER VALLEY BOULEVARD - DESIGN LINE SCALE 1:1000 Ch: 89.158 Ch: 76.35\$ Ch:/63.568 85 <u>C</u>h: 52.218 85 <u>C</u>h: 49<u>.344</u> 85
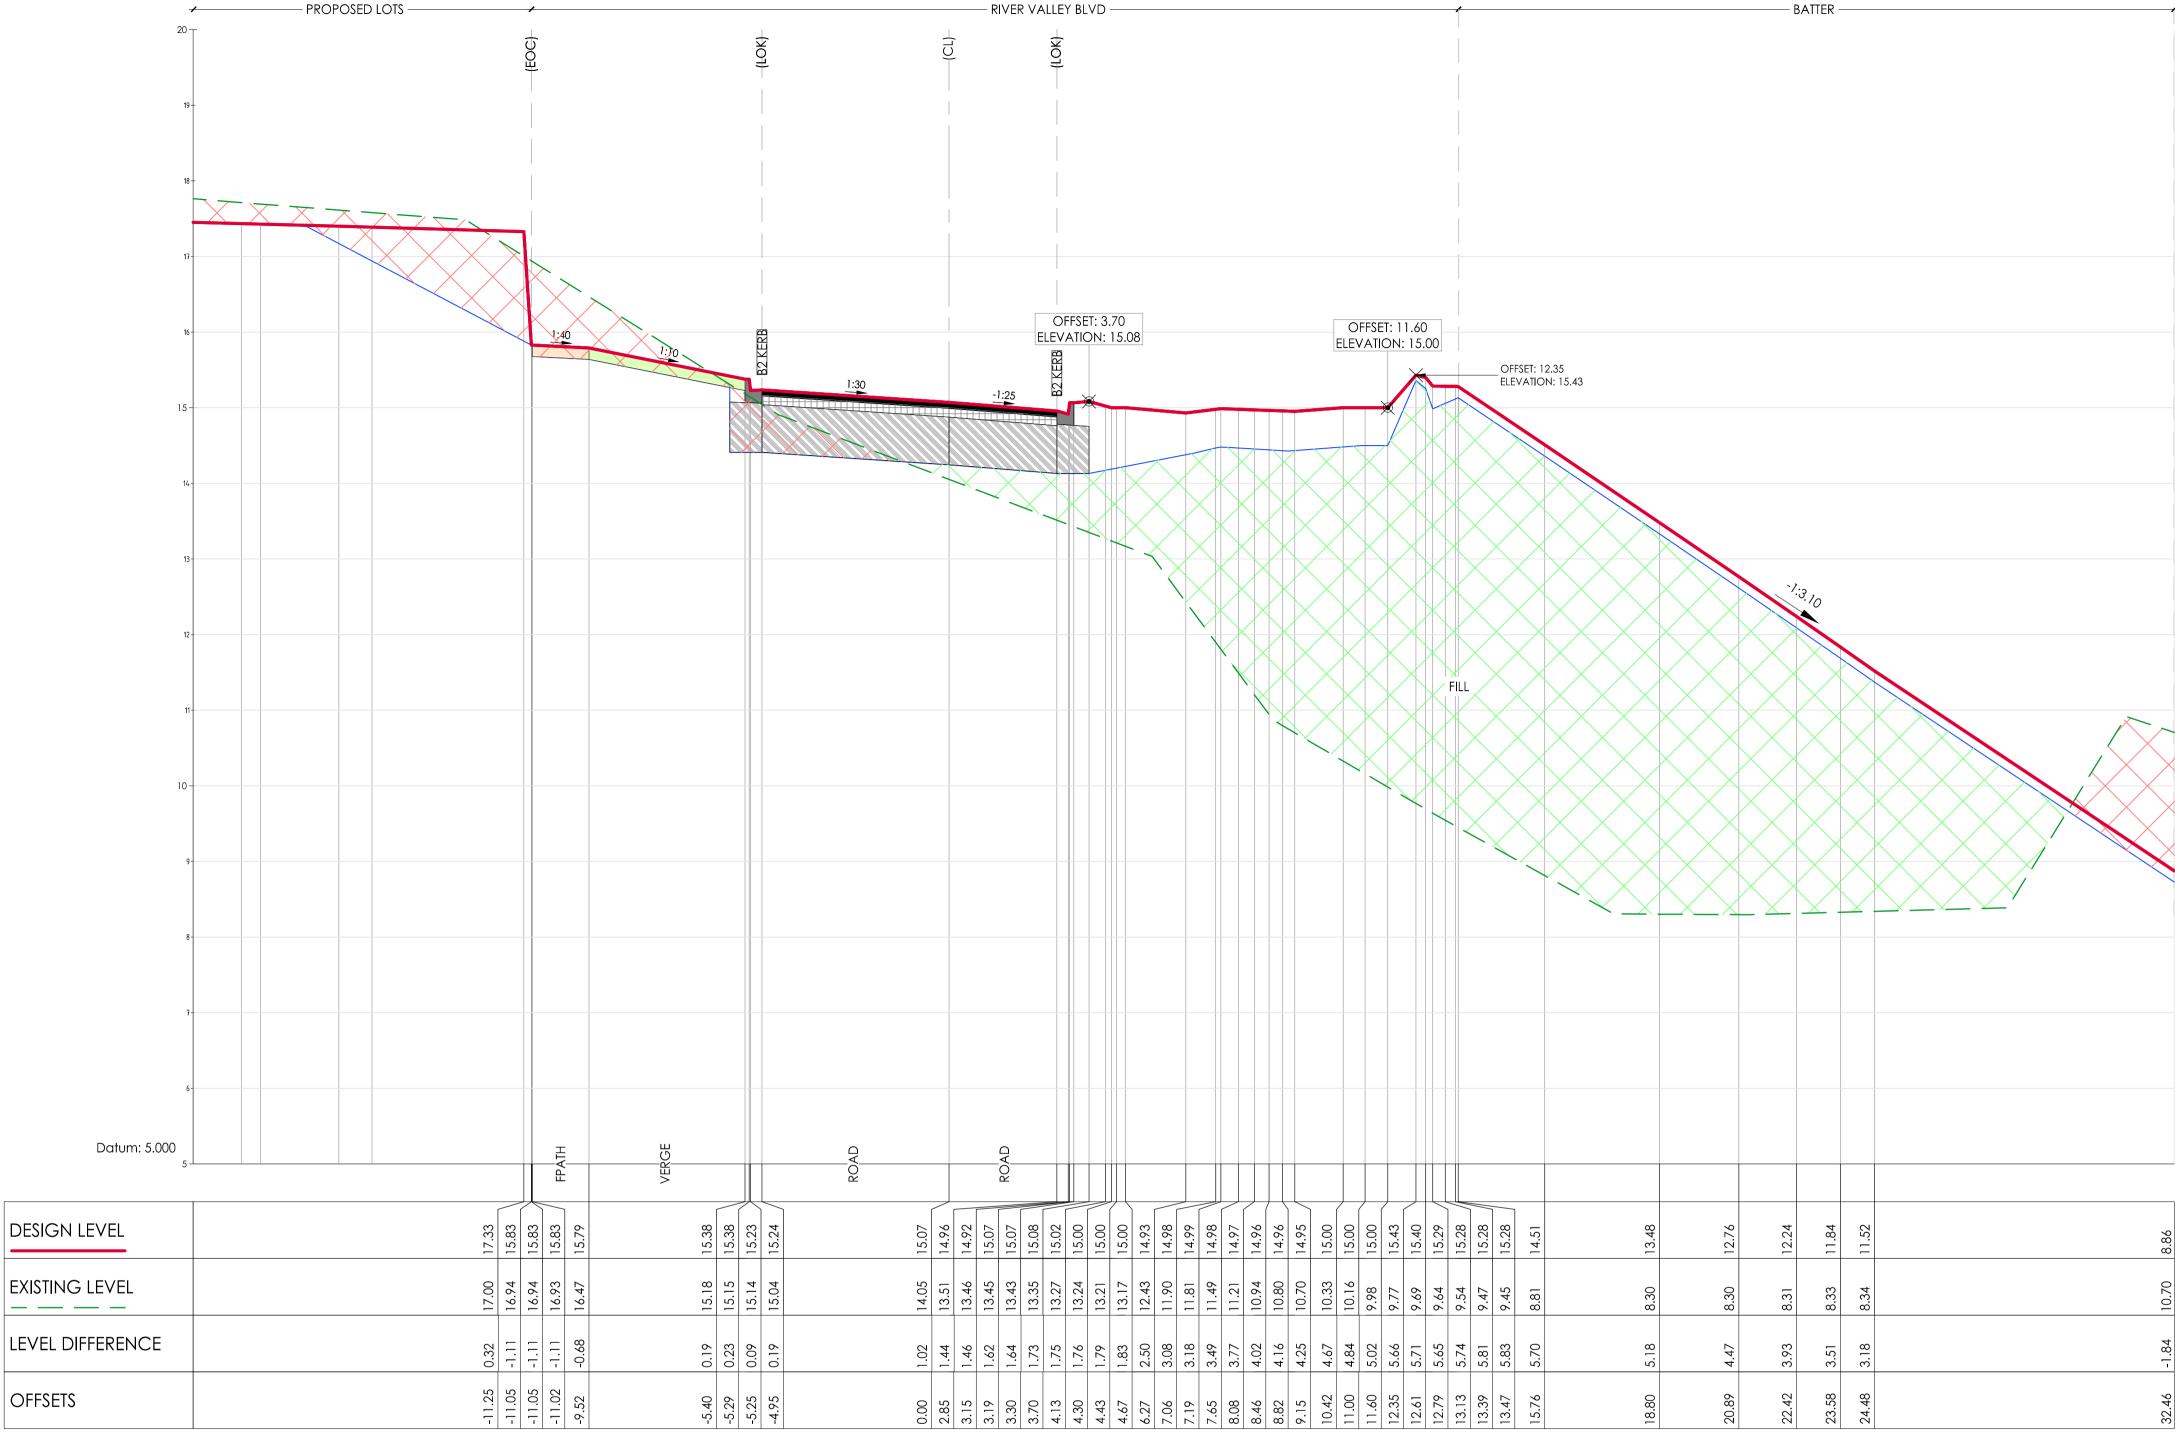
> > 15019 CJA 7C

AL - RVB - CL - HA CHAINAGE 103.52 SCALE HORIZ. 1:100 SCALE VERT. 1:50 (X2)



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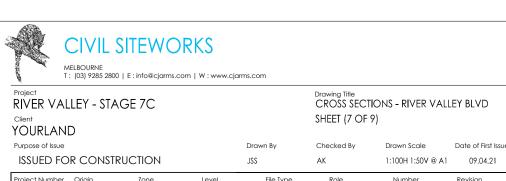
DENOTES ENGINEERED FILL TO T+T TYPE 2 SPECIFICATION (1000780.1000.S1.REV4) AND PREPARED UNDER LEVEL 1 SUPERVISION. (AS PART OF EARLY WORKS).








www.cjarms.com



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5106



AL - RVB - CL - HA CHAINAGE 116.39 SCALE HORIZ. 1:100

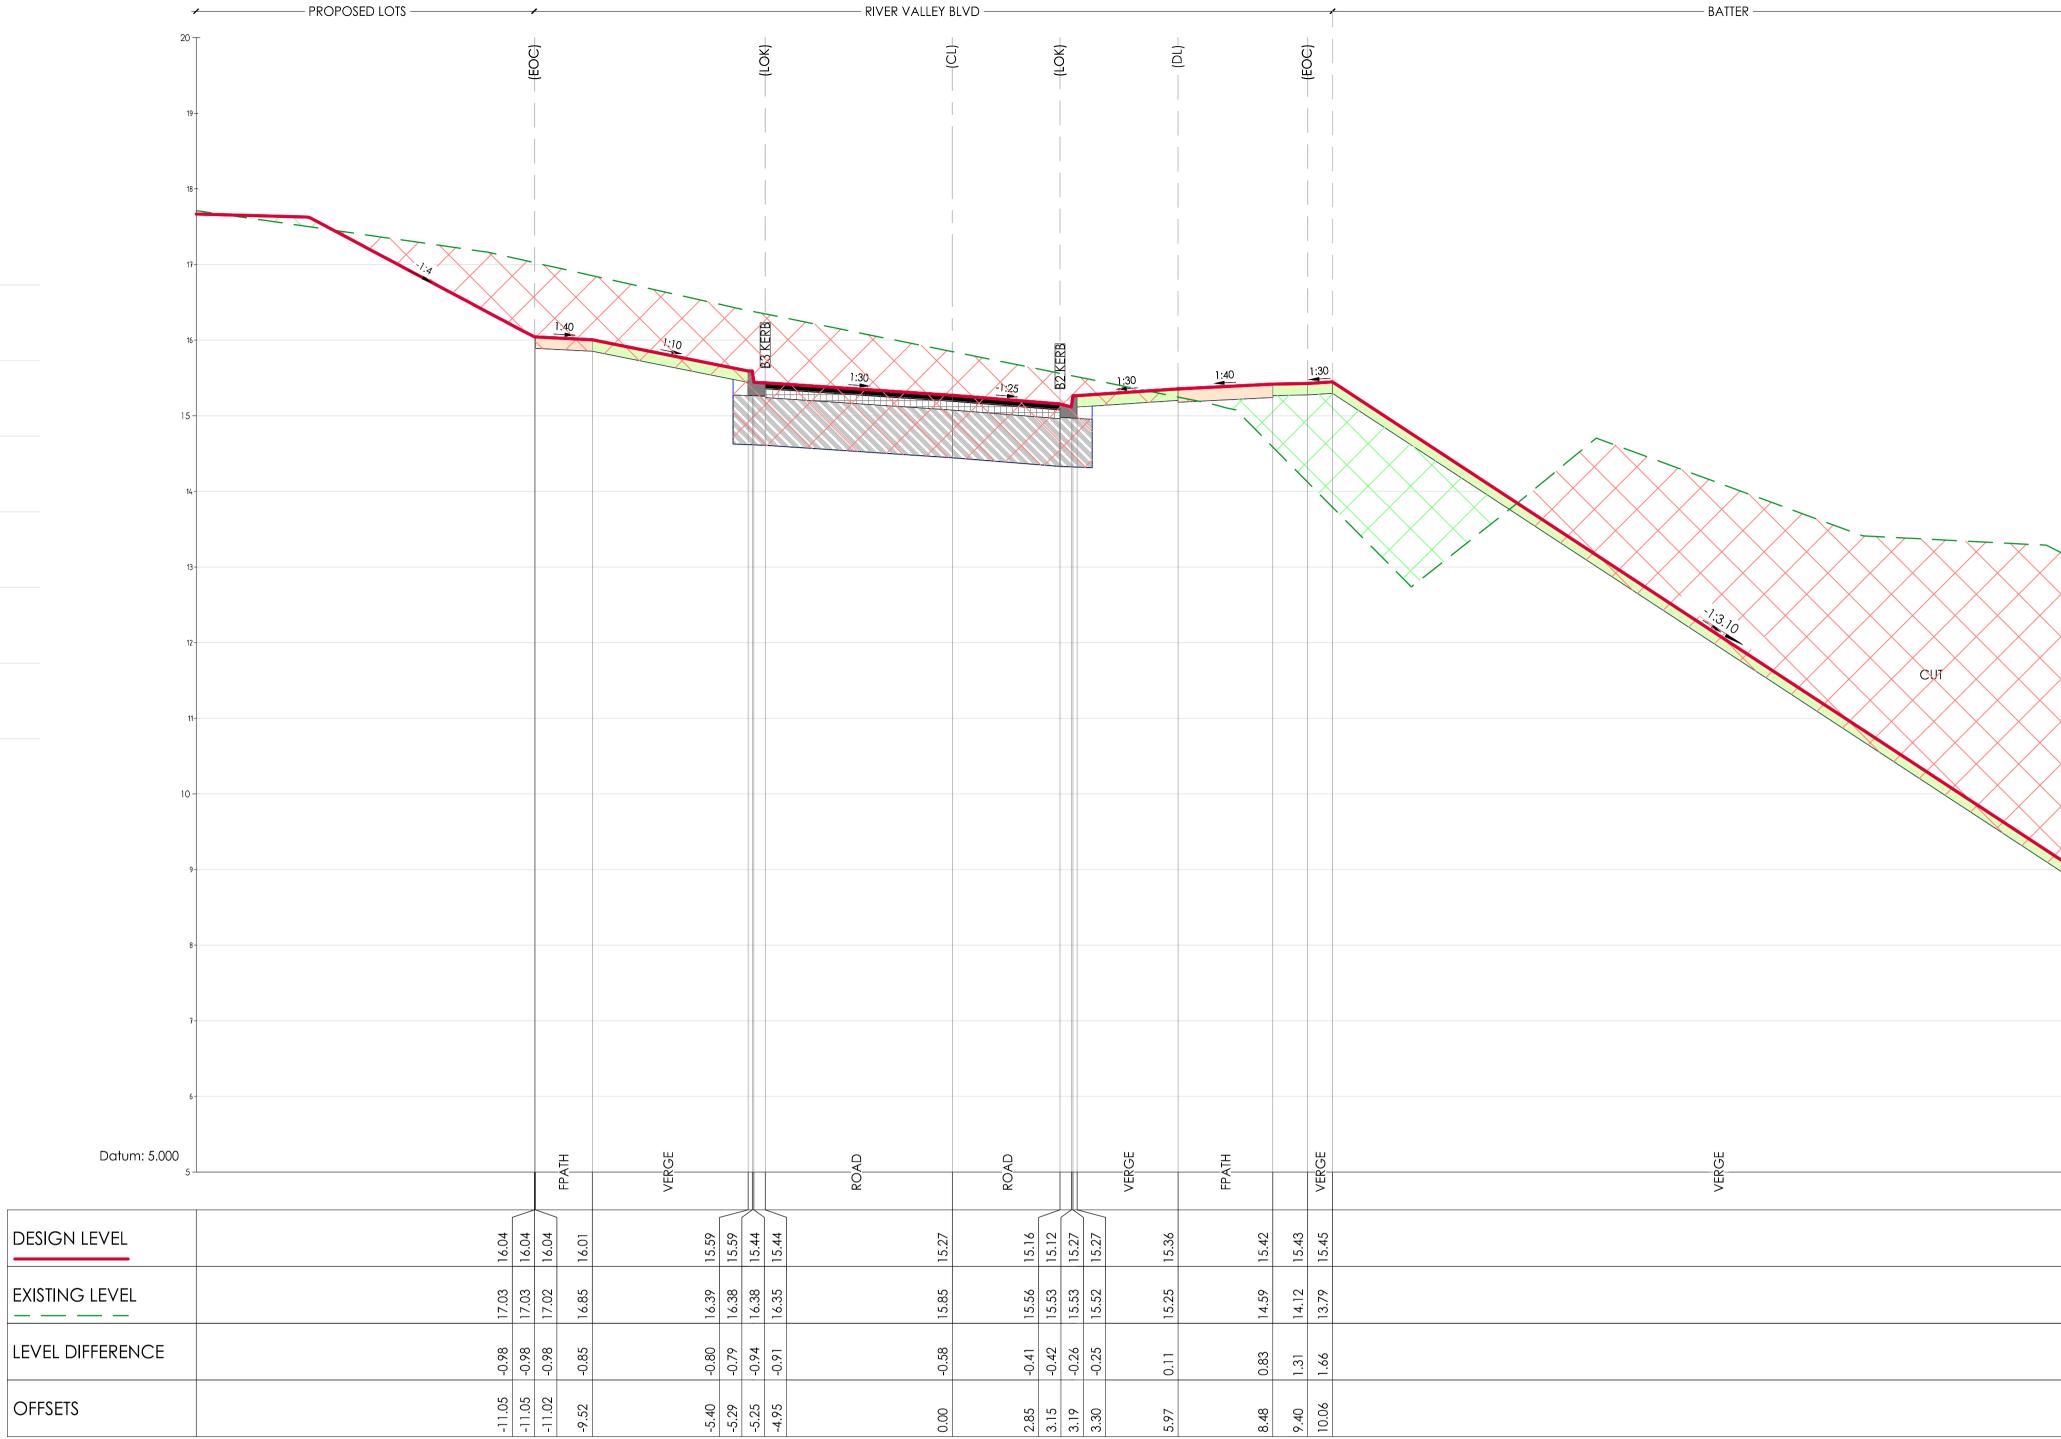SCALE VERT. 1:50 (X2)

KEY PLAN RIVER VALLEY BOULEVARD - DESIGN LINE SCALE 1:1000 \_\_Ch: 89<u>.158</u> <u>Ch: 76.355</u> Ch;/63.568 Cn: 52.218 85 Ch: 39-369 85


Note for Contractors

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DENOTES ENGINEERED FILL TO T+T TYPE 2 SPECIFICATION (1000780.1000.\$1.REV4) AND PREPARED UNDER LEVEL 1 SUPERVISION. (AS PART OF EARLY WORKS).






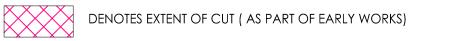

www.cjarms.com


BRIMBANK CITY COUNCIL Engineering Services APPROVED PLANS AND SPECIFICATIONS Vikramt 01 Oct 2021

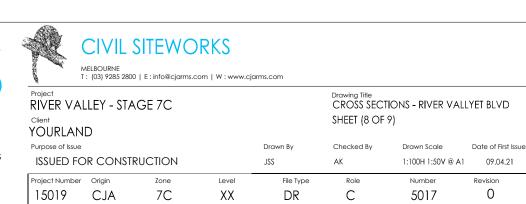


DR


XX

15019 CJA 7C

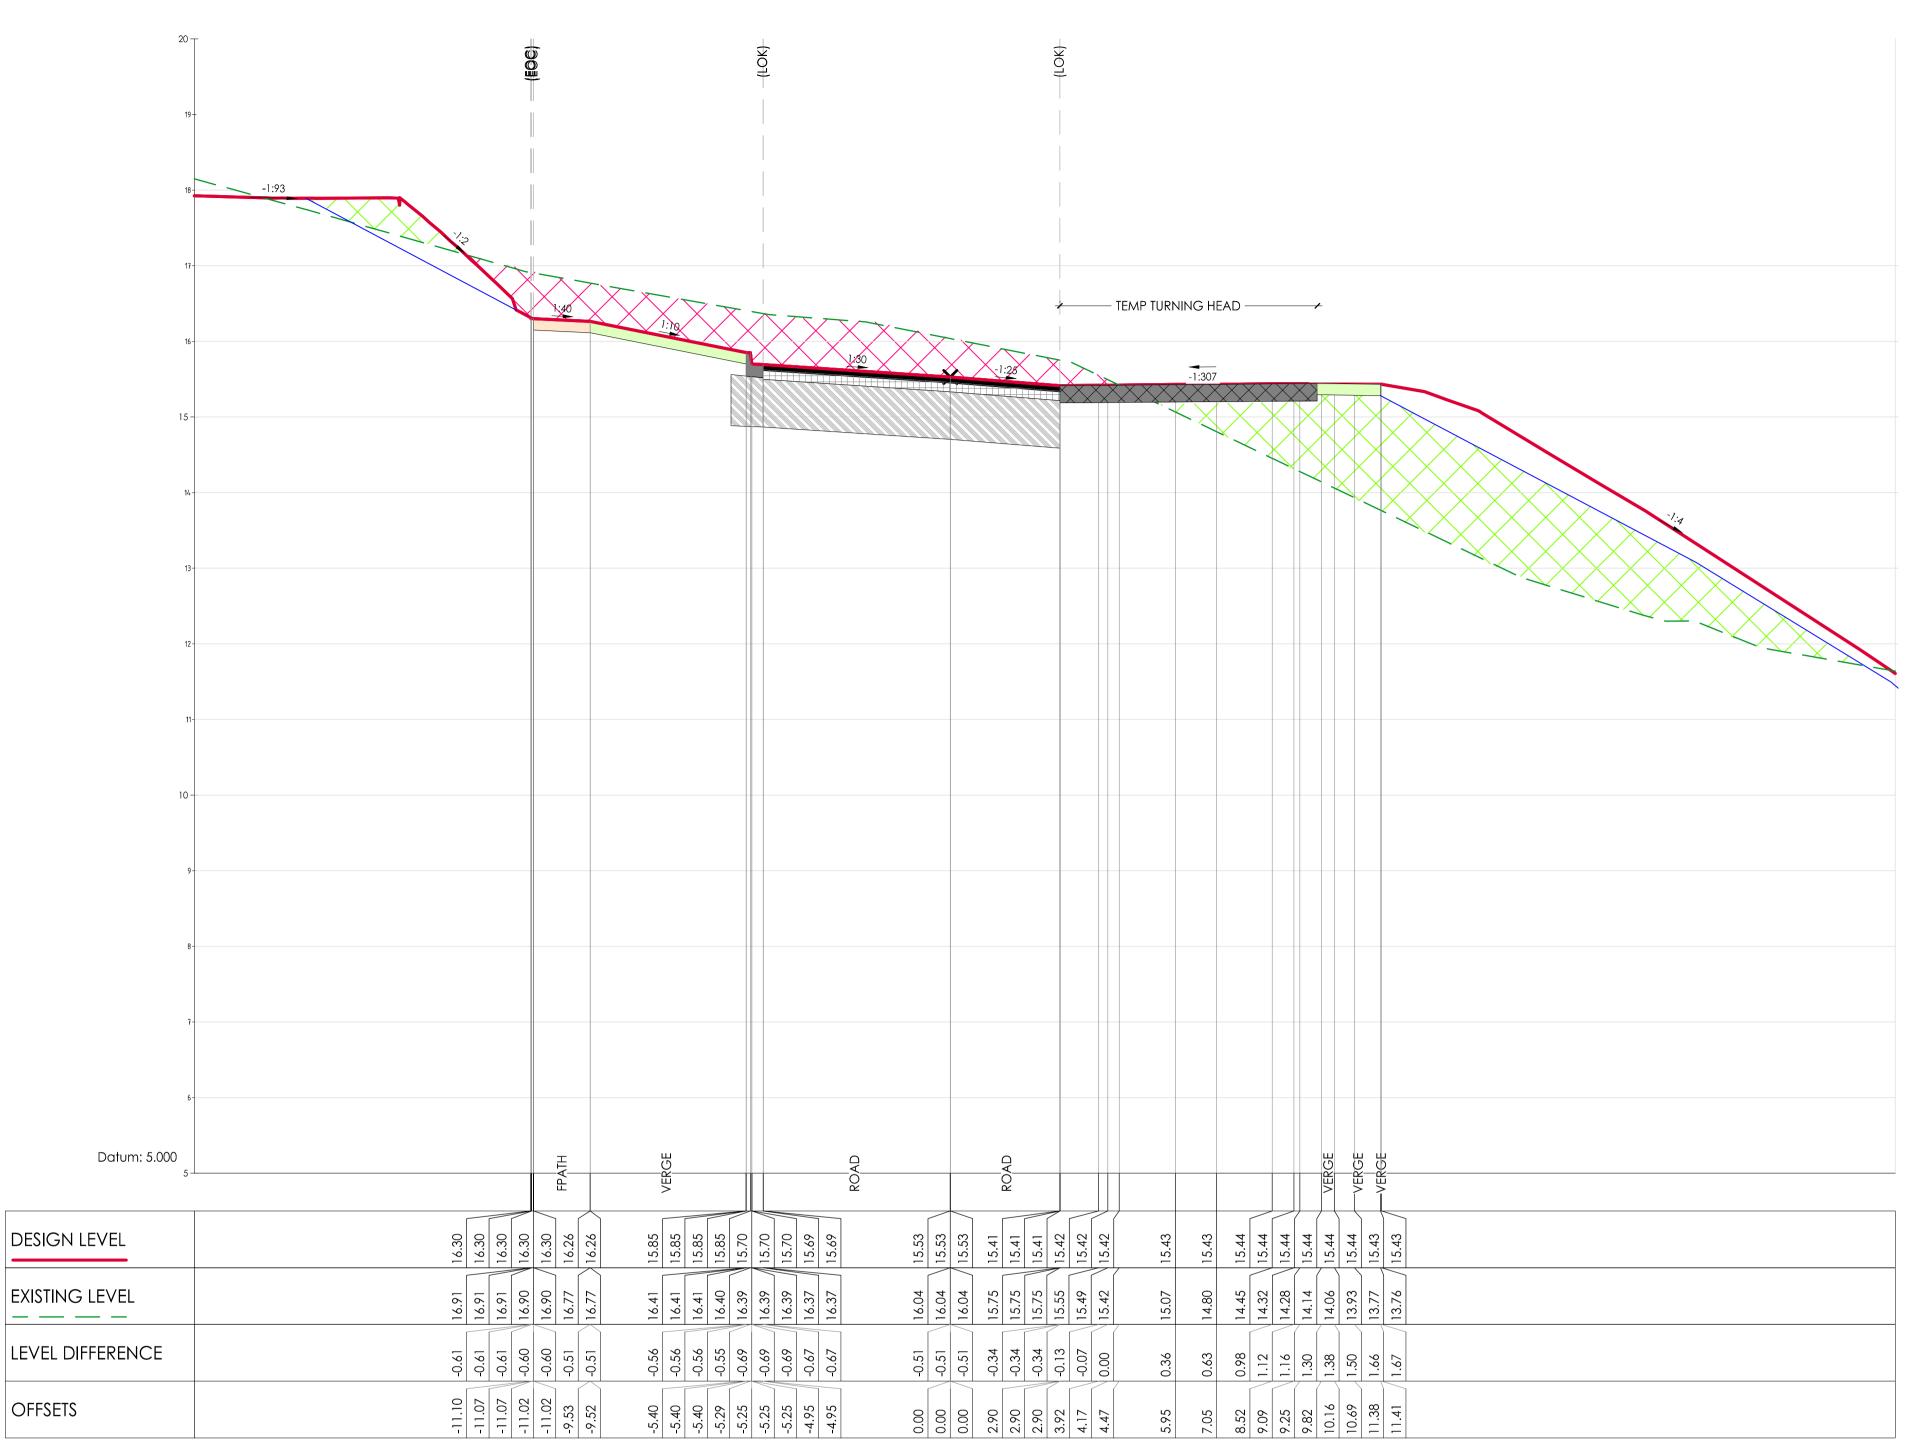

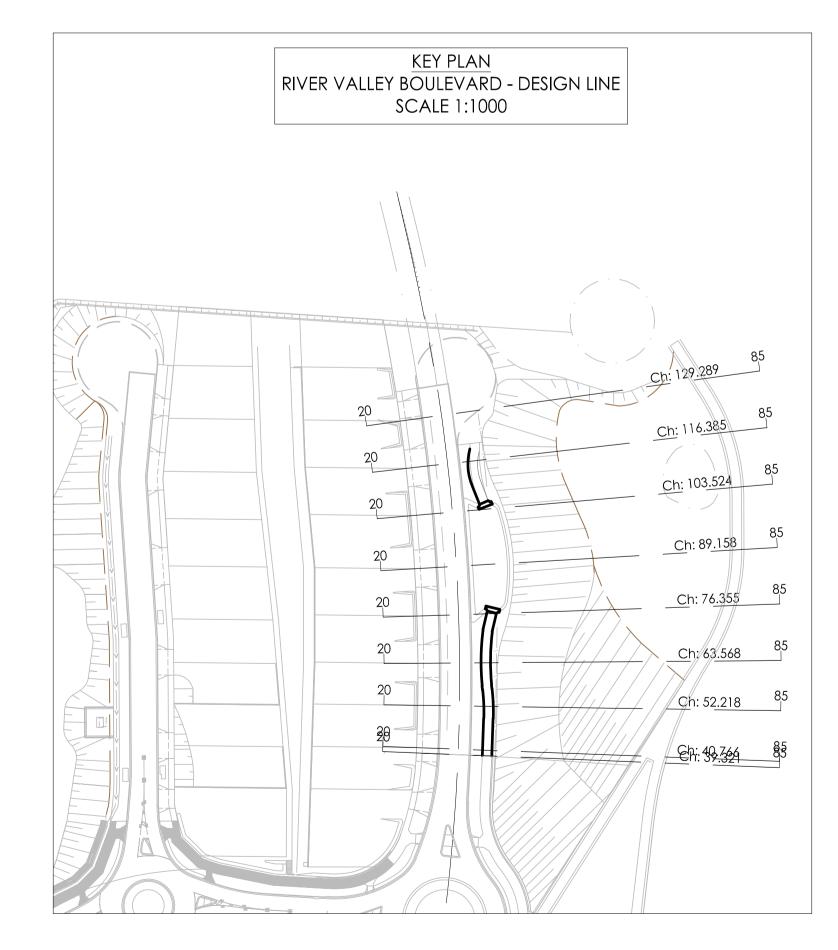

AL - RVB - CL - HA CHAINAGE 129.29 SCALE HORIZ. 1:100 SCALE VERT. 1:50 (X2)

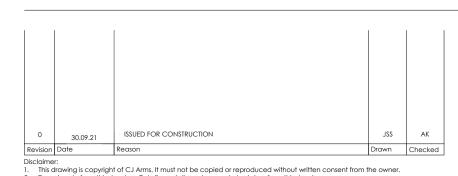

OFFSETS

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DENOTES ENGINEERED FILL TO T+T TYPE 2 SPECIFICATION (1000780.1000.\$1.REV4) AND PREPARED UNDER LEVEL 1 SUPERVISION. (AS PART OF EARLY WORKS).

ISSUED FOR CONSTRUCTION

DENOTES EXTENT OF CUT ( AS PART OF EARLY WORKS)







XX

DR


1:100H 1:50V @ A1 02.06.21

5108


ISSUED FOR CONSTRUCTION

15019 CJA XX


Plot Date 26-Oct-20 - PROPOSED LOTS -- PERENNIAL DRIVE -

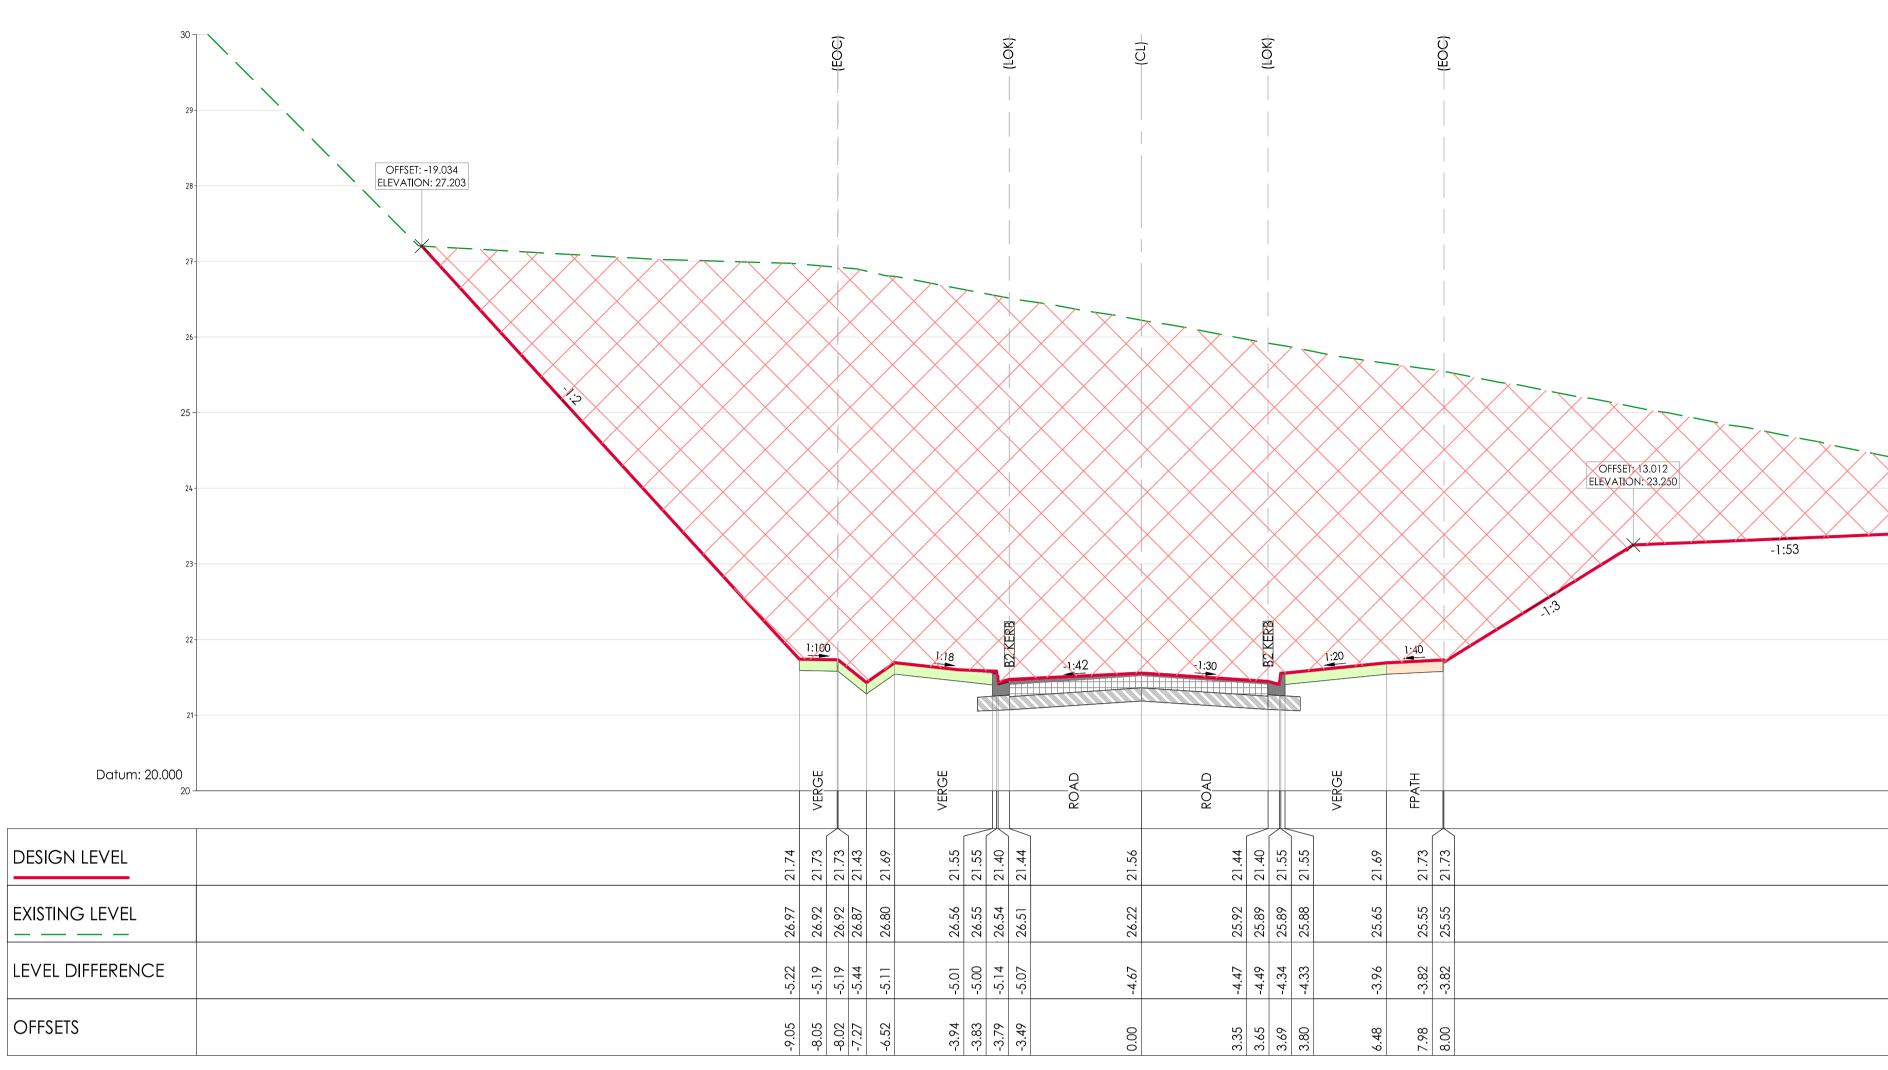

AL - PDRIVE - CL - HA CHAINAGE 99.73 SCALE HORIZ. 1:100 SCALE VERT. 1:50 (X2)

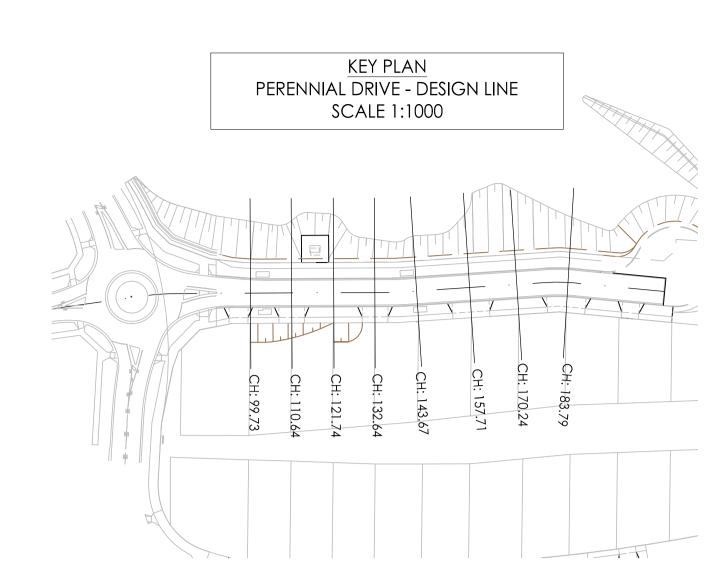

BRIMBANK CITY COUNCIL Engineering Services
APPROVED PLANS AND SPECIFICATIONS Vikramt 01 Oct 2021

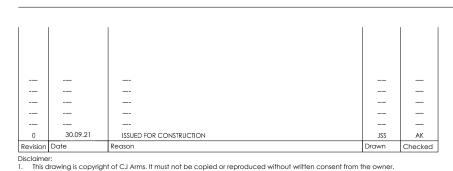

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DENOTES EXTENT OF CUT ( AS PART OF EARLY WORKS)

ISSUED FOR CONSTRUCTION








Project RIVER VALLEY - STAGE 7C Client YOURLAND Drawing Title CROSS SECTIONS - PERRENIAL DRIVE SHEET (1 OF 8)

www.cjarms.com

ISSUED FOR CONSTRUCTION 1:100H 1:50V @ A1 17.04.20 15019 CJA 7C 5150 DR

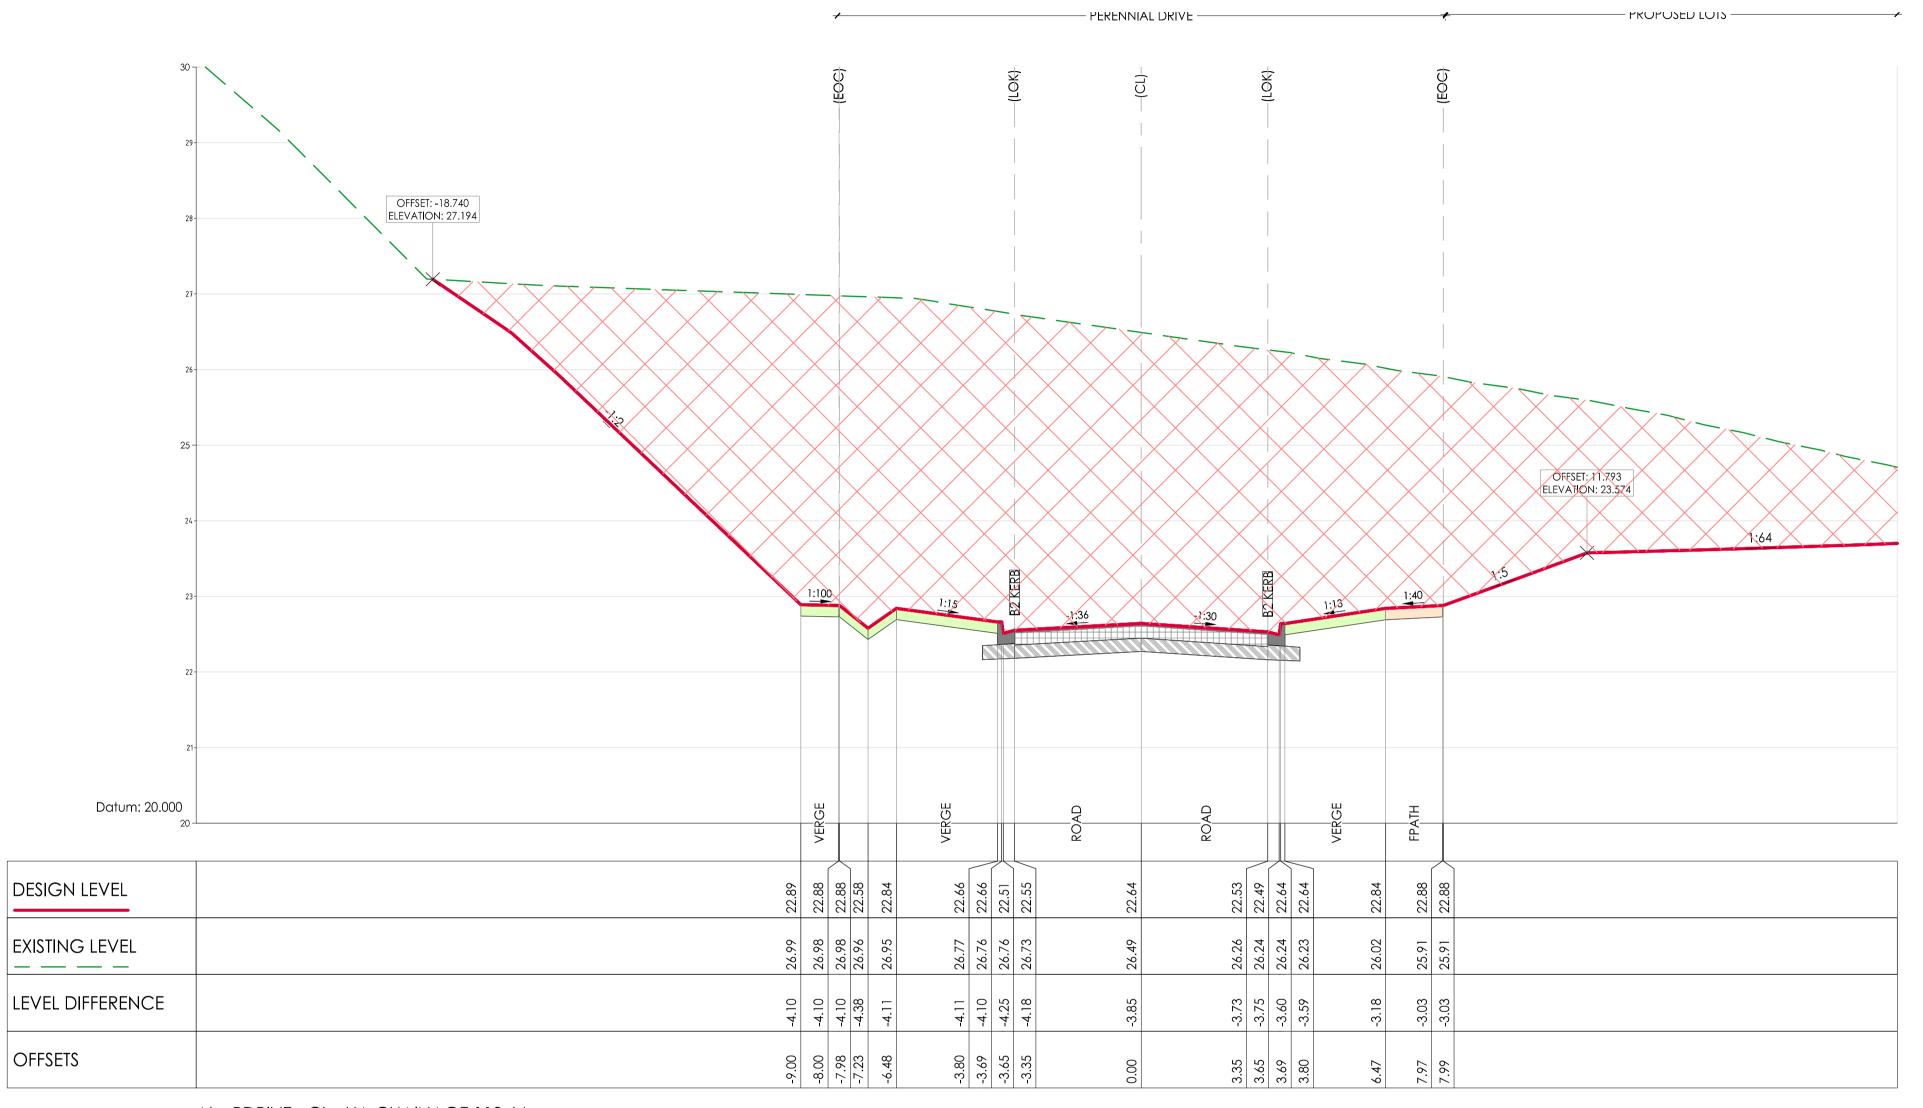

KEY PLAN PERENNIAL DRIVE - DESIGN LINE SCALE 1:1000

BRIMBANK CITY COUNCIL **Engineering Services** APPROVED PLANS AND SPECIFICATIONS Vikramt 01 Oct 2021

AL - PDRIVE - CL - HA CHAINAGE 110.64 SCALE HORIZ. 1:100 SCALE VERT. 1:50 (X2)

Revision Date Reason Drawn Checket

Disclaimer:

1. This drawing is copyright of CJ Arms. It must not be copied or reproduced without written consent from the owner.

2. Do not scale from this drawing. Only figured dimensions are to be taken from this drawing.

3. All contractors must visit site and be responsible for taking and checking all dimensions related to the works shown on the drawing prior to fabrication or setting out.

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DENOTES EXTENT OF CUT ( AS PART OF EARLY WORKS)

ISSUED FOR CONSTRUCTION








Project RIVER VALLEY - STAGE 7C Drawing Title CROSS SECTIONS - PERENNIAL DRIVE SHEET (2 OF 8) YOURLAND Purpose of Issue
ISSUED FOR CONSTRUCTION Drawn Scale Date of First Issue 1:100H 1:50V @ A1 17.04.20 Project Number Origin Zone 15019 CJA 7C Number 5151 XX

DR


- PROPOSED LOTS — - PERENNIAL DRIVE

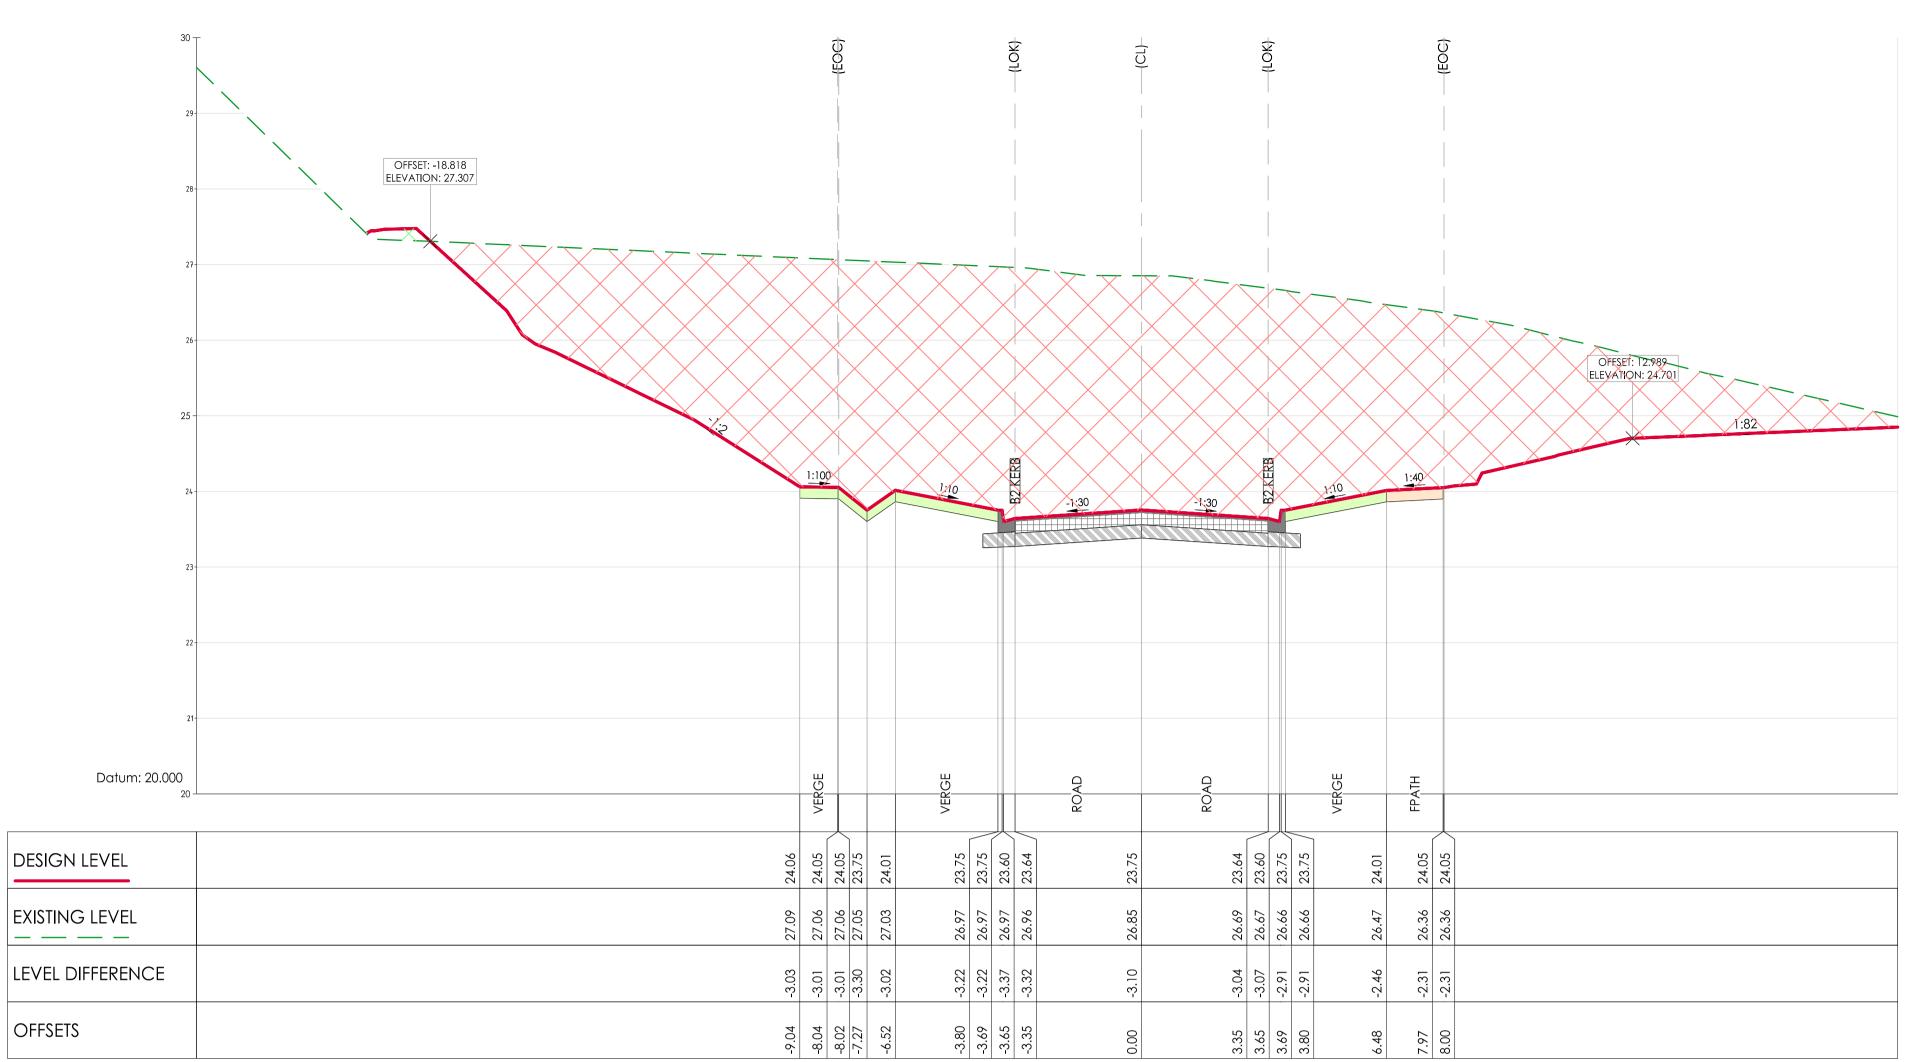

**Engineering Services** APPROVED PLANS AND SPECIFICATIONS Vikramt 01 Oct 2021

BRIMBANK CITY COUNCIL

AL - PDRIVE - CL - HA CHAINAGE 121.74 SCALE HORIZ. 1:100 SCALE VERT. 1:50 (X2)

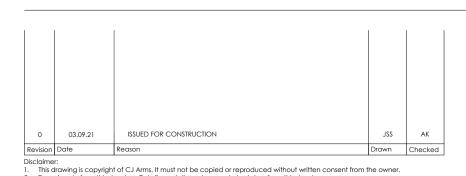

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DENOTES ENGINEERED FILL TO T+T TYPE 2 SPECIFICATION (1000780.1000.\$1.REV4) AND PREPARED UNDER LEVEL 1 SUPERVISION. (AS PART OF EARLY WORKS).

DENOTES EXTENT OF CUT ( AS PART OF EARLY WORKS)








www.cjarms.com




KEY PLAN PERENNIAL DRIVE - DESIGN LINE SCALE 1:1000

Client YOURLAND PURDAGE AS INCITATION IN TO A SAMPHUR ISSUED FOR CONSTRUCTION 1:100H 1:50V @ A1 09.04.21 15019 CJA 7C 5152 DR

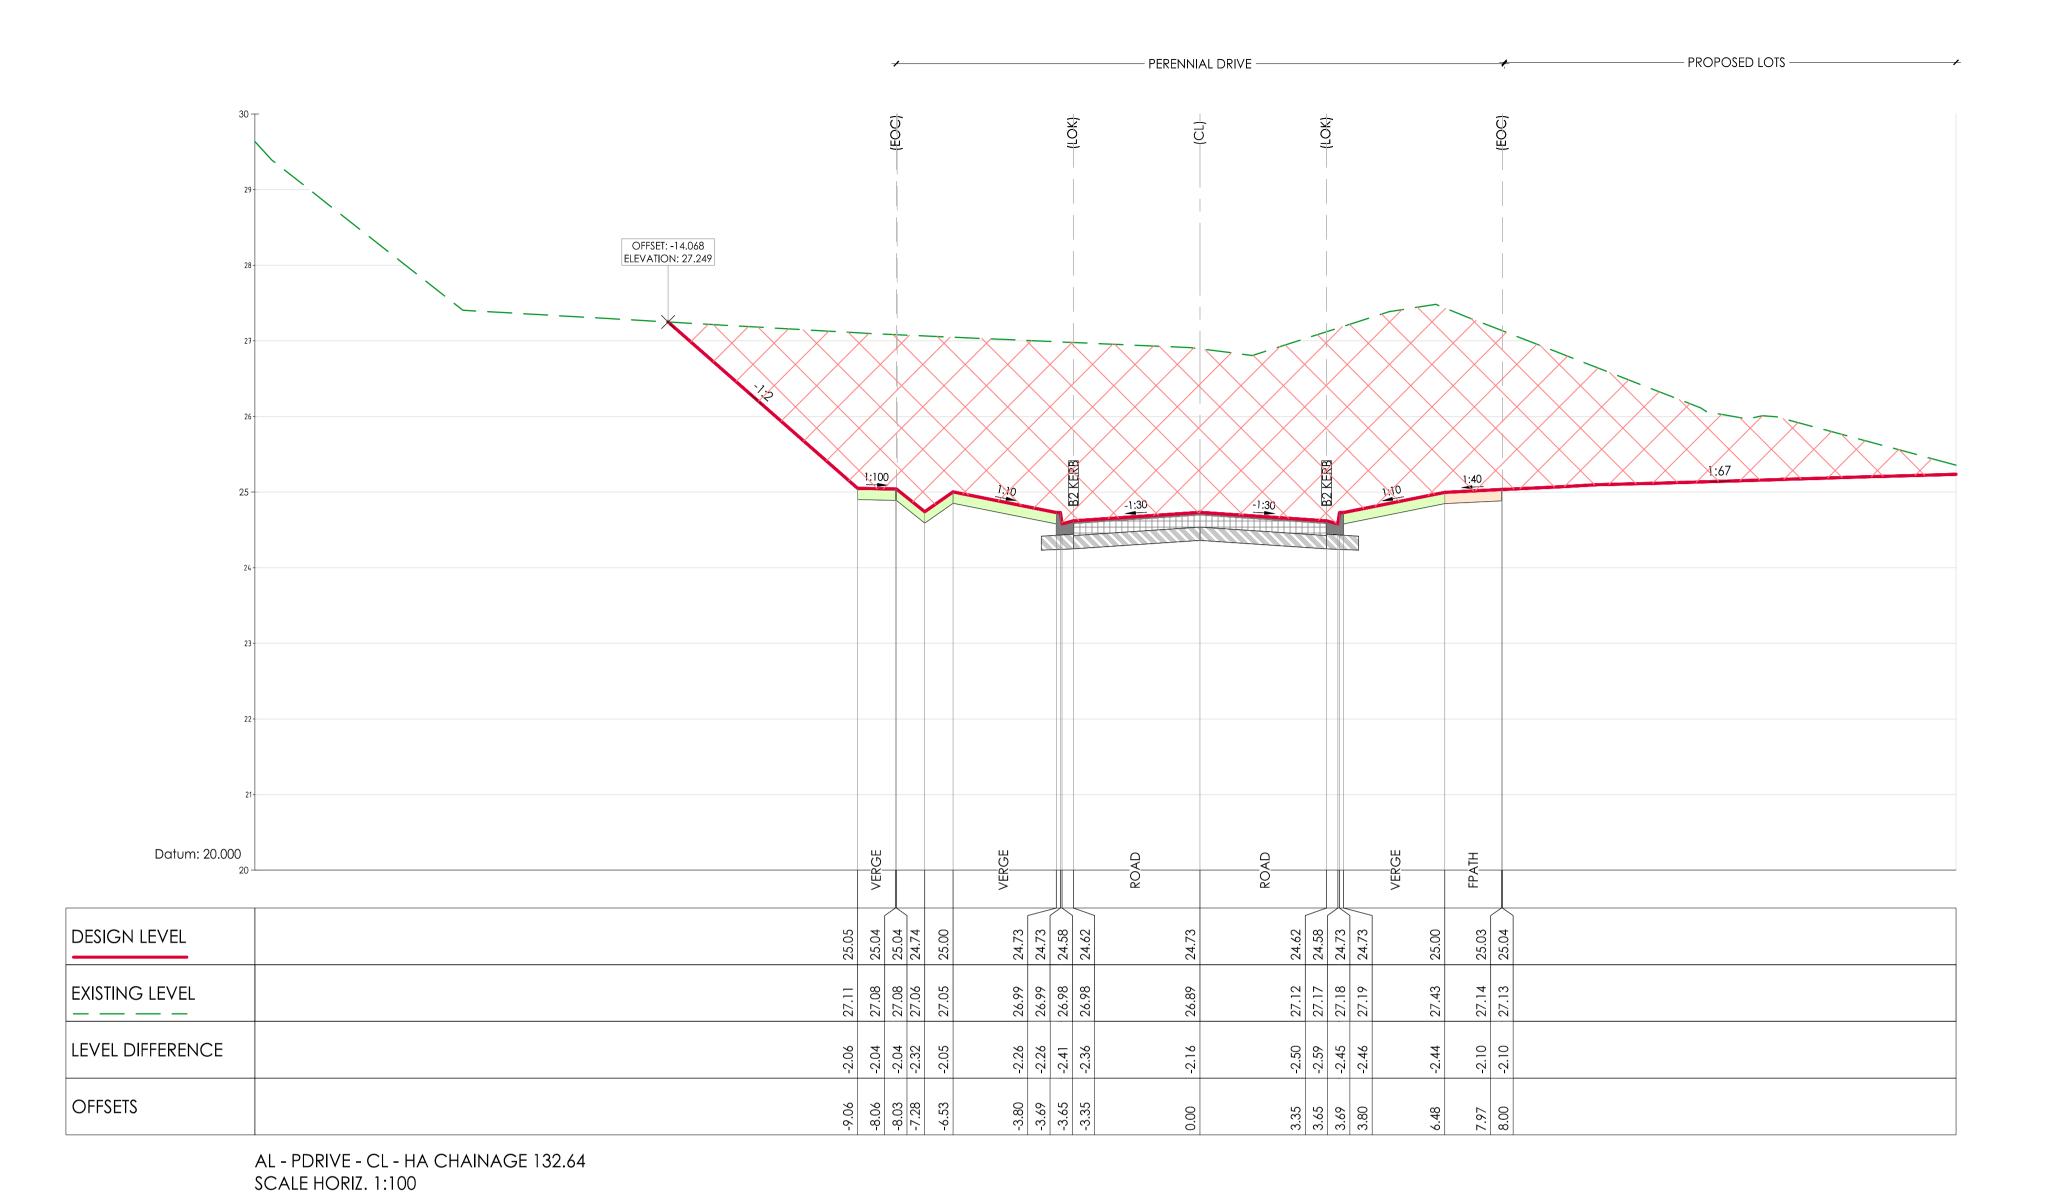

Vikramt 01 Oct 2021

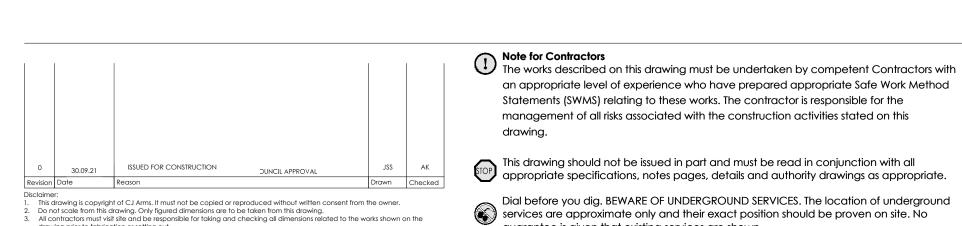

SCALE VERT. 1:50 (X2)

Note for Contractors

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guarantee is given that existing services are shown.

drawing.

DENOTES EXTENT OF CUT ( AS PART OF EARLY WORKS)

DENOTES ENGINEERED FILL TO T+T TYPE 2 SPECIFICATION (1000780.1000.\$1.REV4) AND PREPARED UNDER LEVEL 1 SUPERVISION. (AS PART OF EARLY WORKS).





Project RIVER VALLEY - STAGE 7C Drawing Title CROSS SECTIONS - PERENNIAL DRIVE SHEET (4 OF 8) Client YOURLAND

DR

1:100H 1:50V @ A1 09.04.21


Number 5153

ISSUED FOR CONSTRUCTION

15019 CJA 7C

KEY PLAN PERENNIAL DRIVE - DESIGN LINE SCALE 1:1000

ISSUED FOR CONSTRUCTION

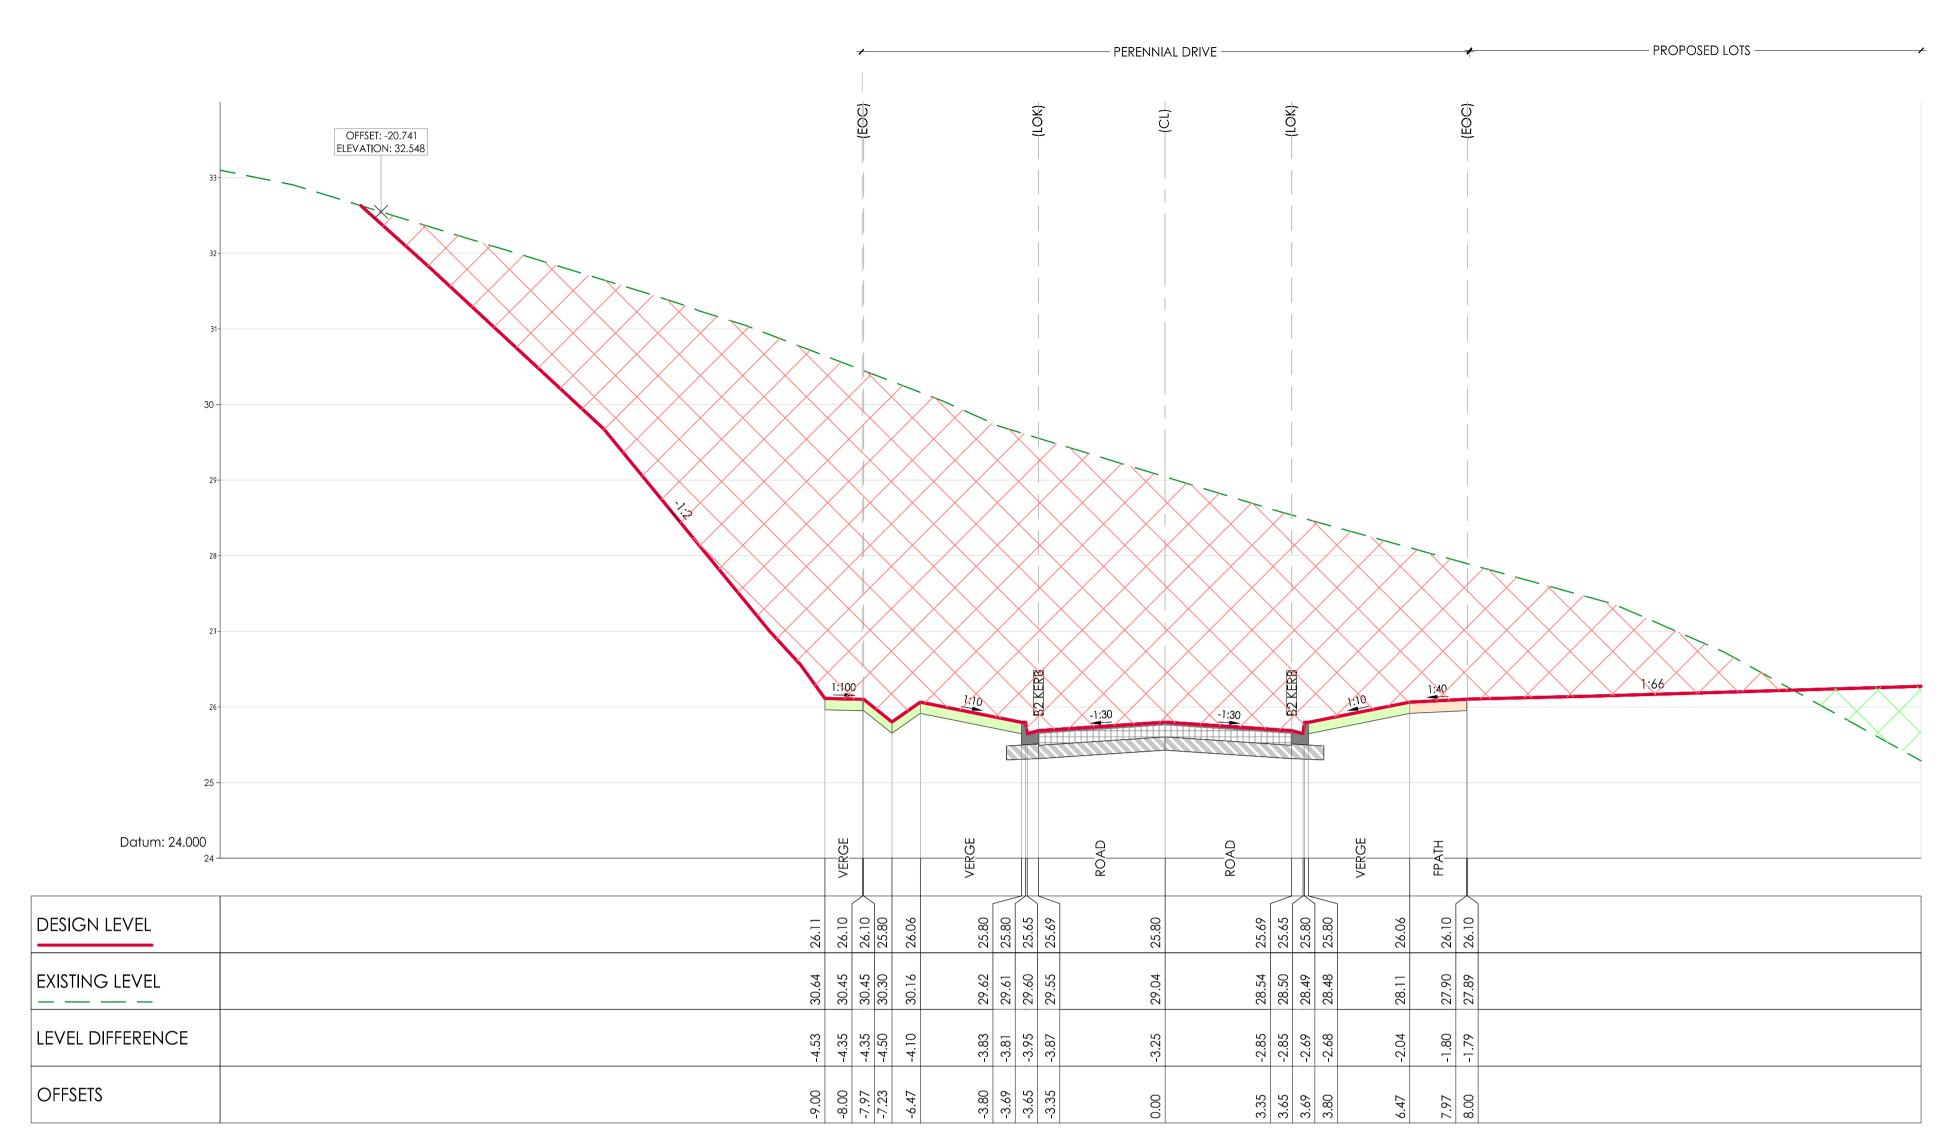


Plot Date 26-Oct-20

AL - PDRIVE - CL - HA CHAINAGE 157.71 SCALE HORIZ. 1:100 SCALE VERT. 1:50 (X2)

KEY PLAN PERENNIAL DRIVE - DESIGN LINE SCALE 1:1000

BRIMBANK CITY COUNCIL Engineering Services
APPROVED PLANS AND SPECIFICATIONS Vikramt 01 Oct 2021

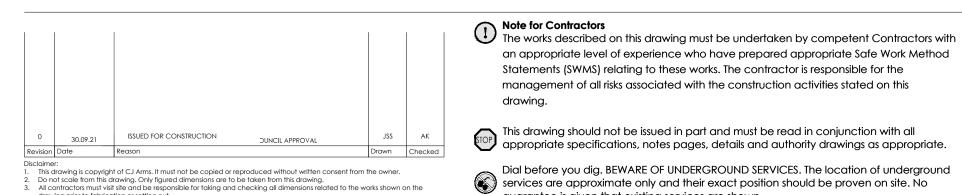

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guarantee is given that existing services are shown.


DENOTES ENGINEERED FILL TO T+T TYPE 2 SPECIFICATION (1000780.1000.\$1.REV4) AND PREPARED UNDER LEVEL 1 SUPERVISION. (AS PART OF EARLY WORKS).

DENOTES EXTENT OF CUT ( AS PART OF EARLY WORKS)





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DR

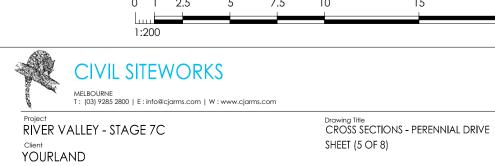1:100H 1:50V @ A1 09.04.21

5154


ISSUED FOR CONSTRUCTION

15019 CJA 7C


ISSUED FOR CONSTRUCTION

File Reference 15019-CJA-7C-00-DR-C-5104-5105 - CROSS SECTIONS - PERRENIAL DRIVE\_recover000.dwg Plot Date 26-Oct-20


- PROPOSED LOTS -- PERENNIAL DRIVE -

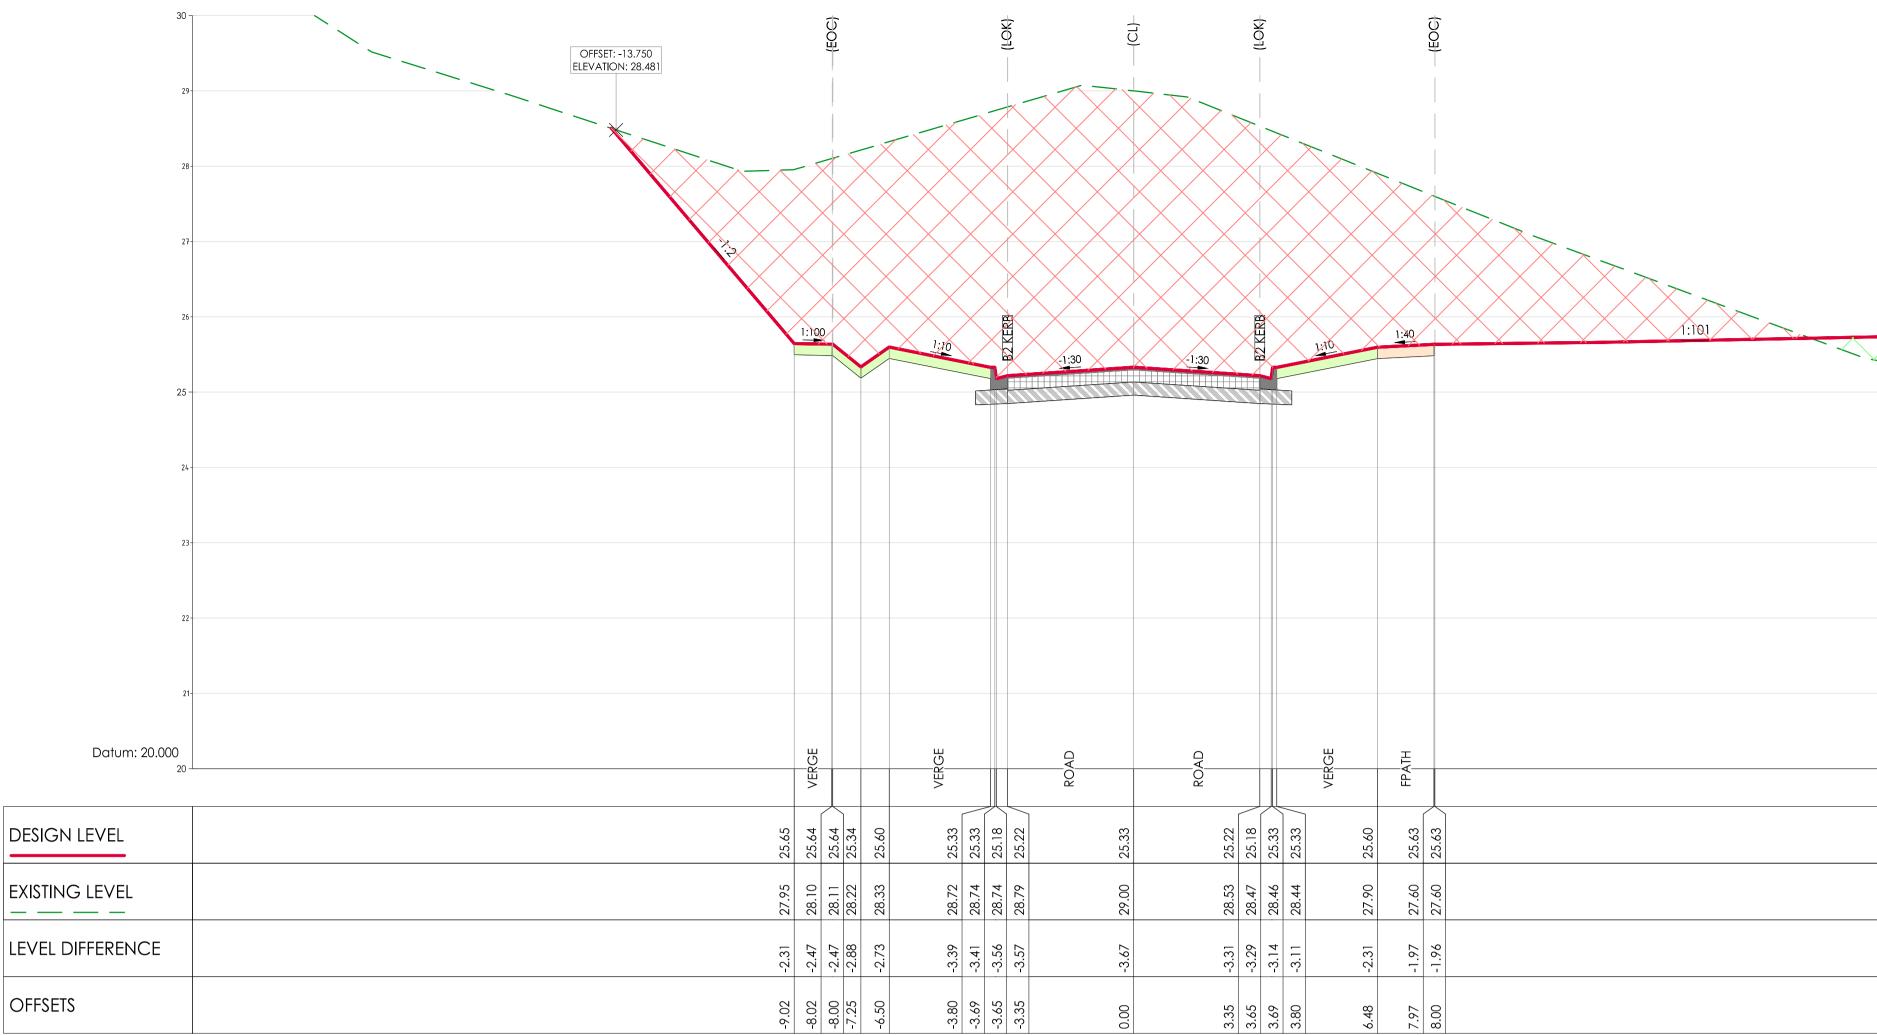

AL - PDRIVE - CL - HA CHAINAGE 143.67 SCALE HORIZ. 1:100 SCALE VERT. 1:50 (X2)

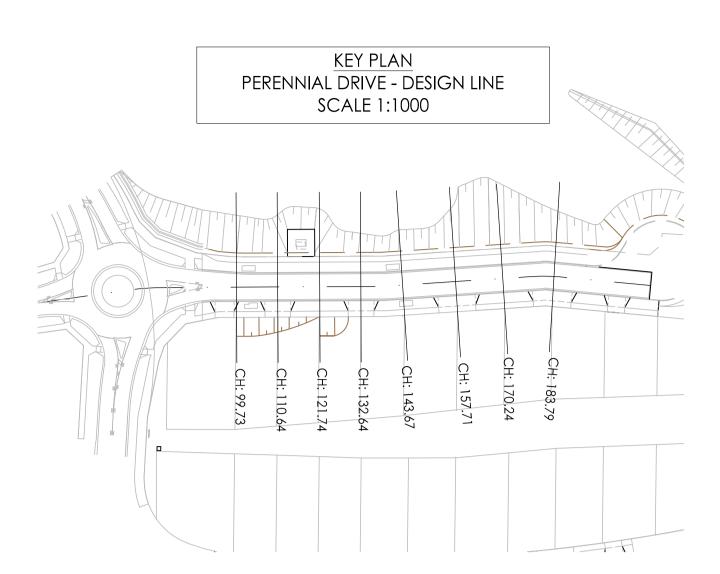

BRIMBANK CITY COUNCIL Engineering Services
APPROVED PLANS AND SPECIFICATIONS Vikramt 01 Oct 2021

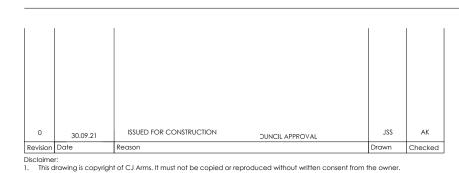

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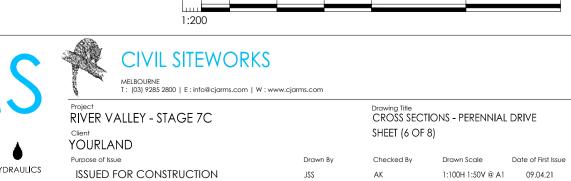
Dial before you dig. BEWARE OF UNDERGROUND SERVICES. The location of underground services are approximate only and their exact position should be proven on site. No guarantee is given that existing services are shown.

DENOTES ENGINEERED FILL TO T+T TYPE 2 SPECIFICATION (1000780.1000.\$1.REV4) AND PREPARED UNDER LEVEL 1 SUPERVISION. (AS PART OF EARLY WORKS).

DENOTES EXTENT OF CUT ( AS PART OF EARLY WORKS)







DR

15019 CJA 7C

- PROPOSED LOTS -- PERENNIAL DRIVE 1:73 Datum: 20.000 DESIGN LEVEL 26.53 26.52 26.52 26.22 26.48 30.15 29.93 29.93 29.76 29.60 EXISTING LEVEL \_ \_ \_ \_ LEVEL DIFFERENCE -3.62 -3.41 -3.41 -3.54 -3.51 -2.79 -2.77 -2.91 -2.80

Plot Date 26-Oct-20


AL - PDRIVE - CL - HA CHAINAGE 170.24 SCALE HORIZ. 1:100 SCALE VERT. 1:50 (X2) KEY PLAN
PERENNIAL DRIVE - DESIGN LINE
SCALE 1:1000

CH: 157.71

CH: 157.71

CH: 198.73

BRIMBANK CITY COUNCIL Engineering Services APPROVED PLANS AND SPECIFICATIONS Vikramt 01 Oct 2021

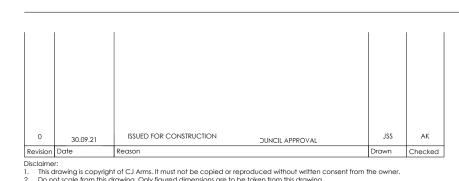

OFFSETS

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h

-9.00 -8.00 -7.97 -7.23

DENOTES ENGINEERED FILL TO T+T TYPE 2 SPECIFICATION (1000780.1000.S1.REV4) AND PREPARED UNDER LEVEL 1 SUPERVISION. (AS PART OF EARLY WORKS).

DENOTES EXTENT OF CUT ( AS PART OF EARLY WORKS)









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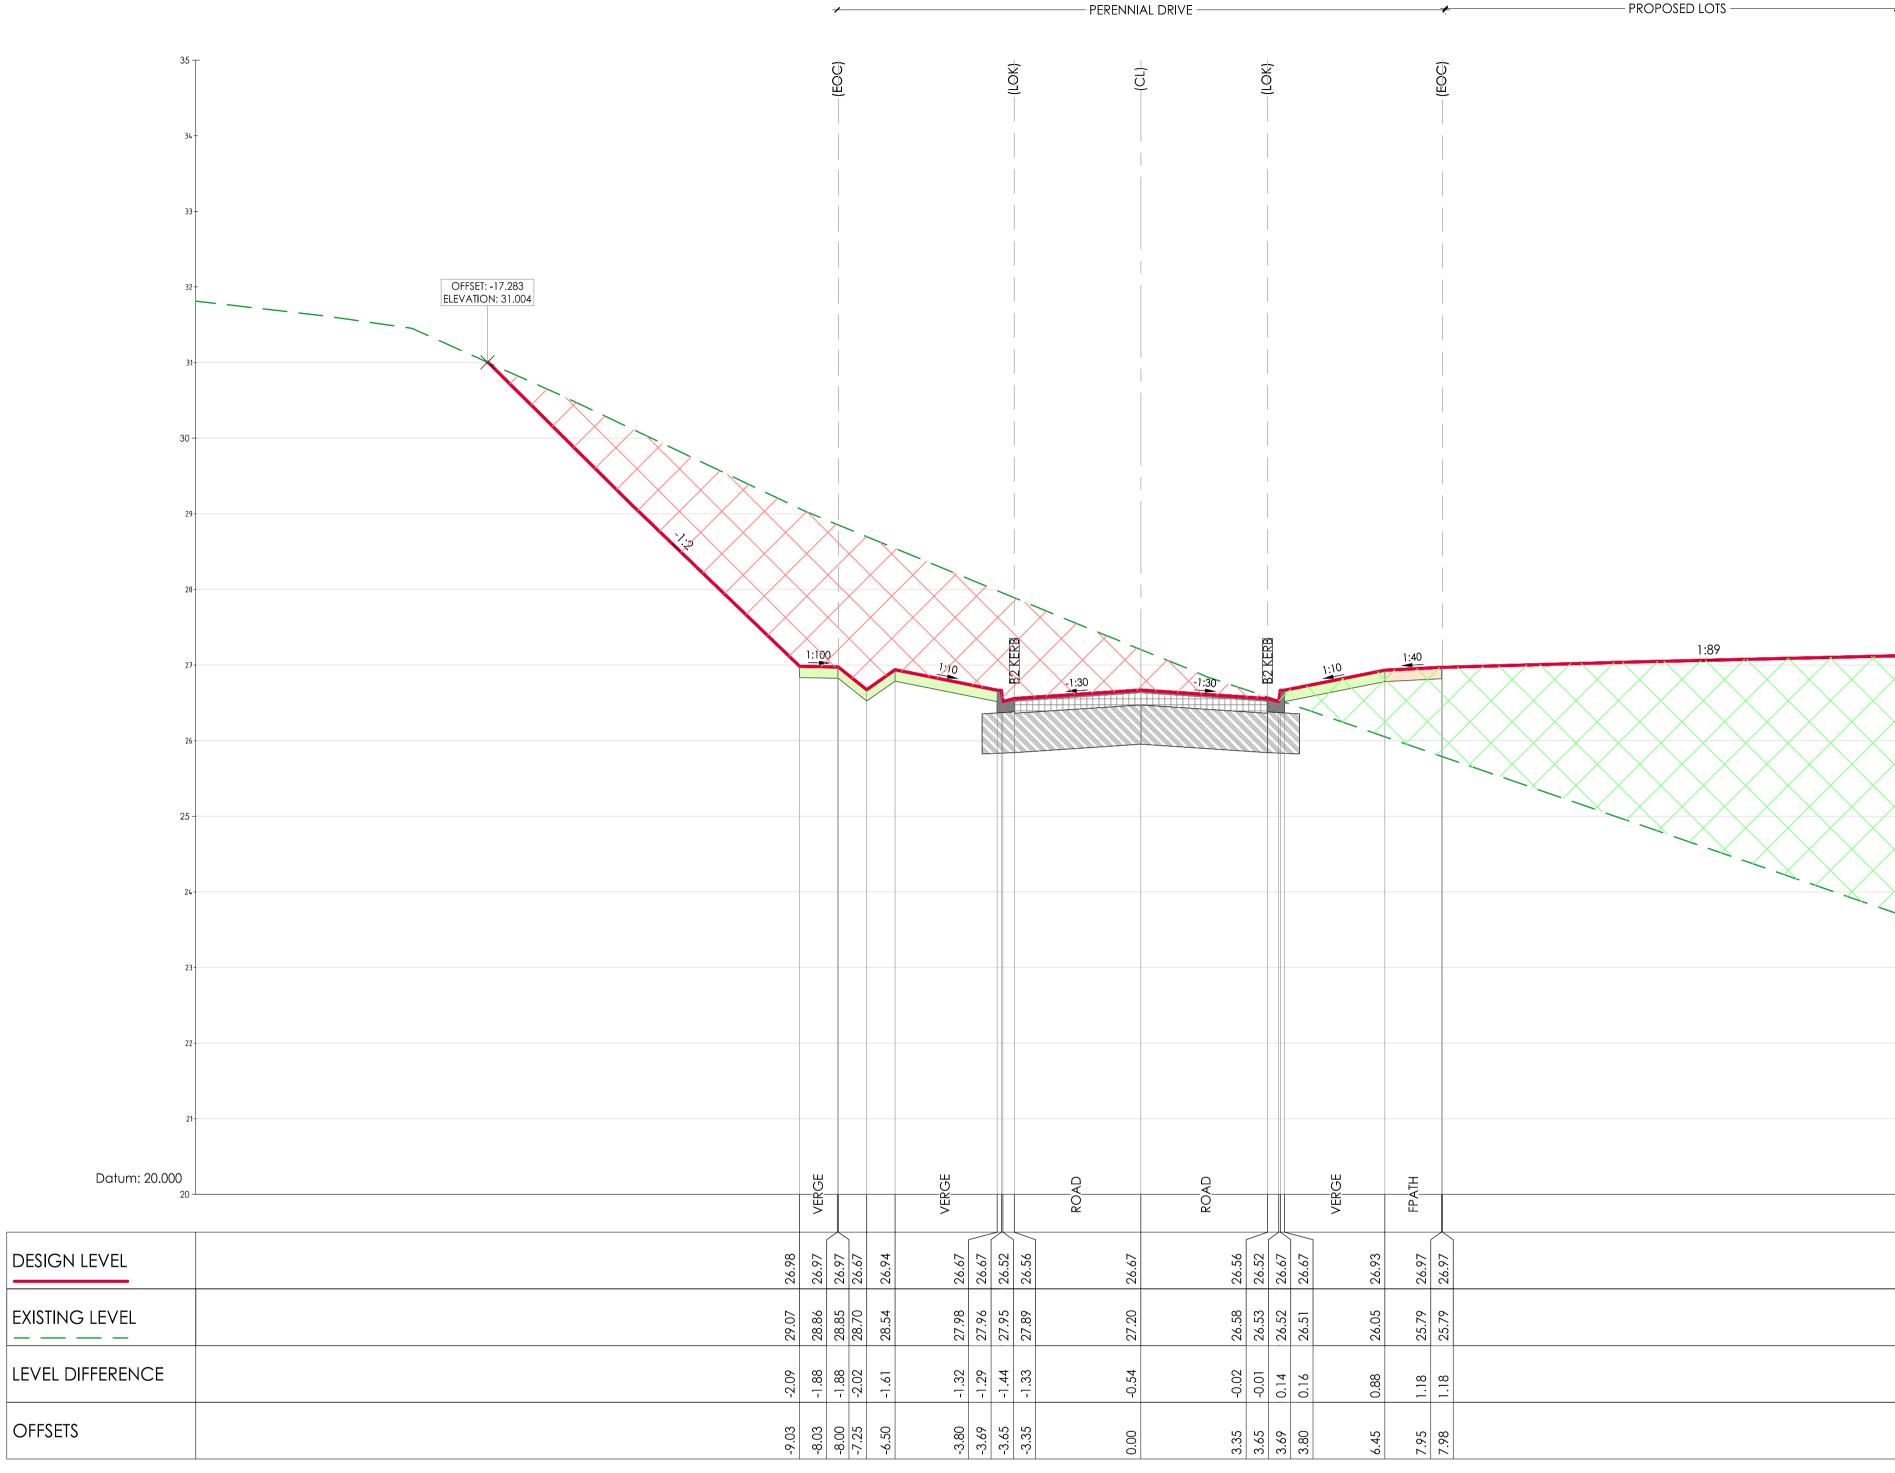
DR

1:100H 1:50V @ A1 09.04.21

5156

ISSUED FOR CONSTRUCTION

15019 CJA 7C



KEY PLAN PERENNIAL DRIVE - DESIGN LINE SCALE 1:1000

BRIMBANK CITY COUNCIL Engineering Services APPROVED PLANS AND SPECIFICATIONS Vikramt 01 Oct 2021

AL - PDRIVE - CL - HA CHAINAGE 183.79

SCALE VERT. 1:50 (X2)

SCALE HORIZ. 1:100

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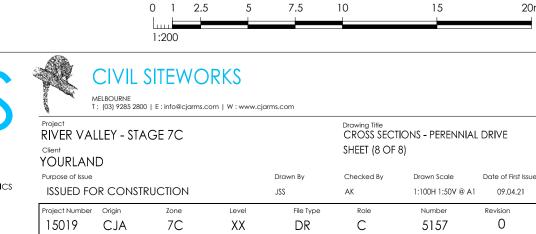
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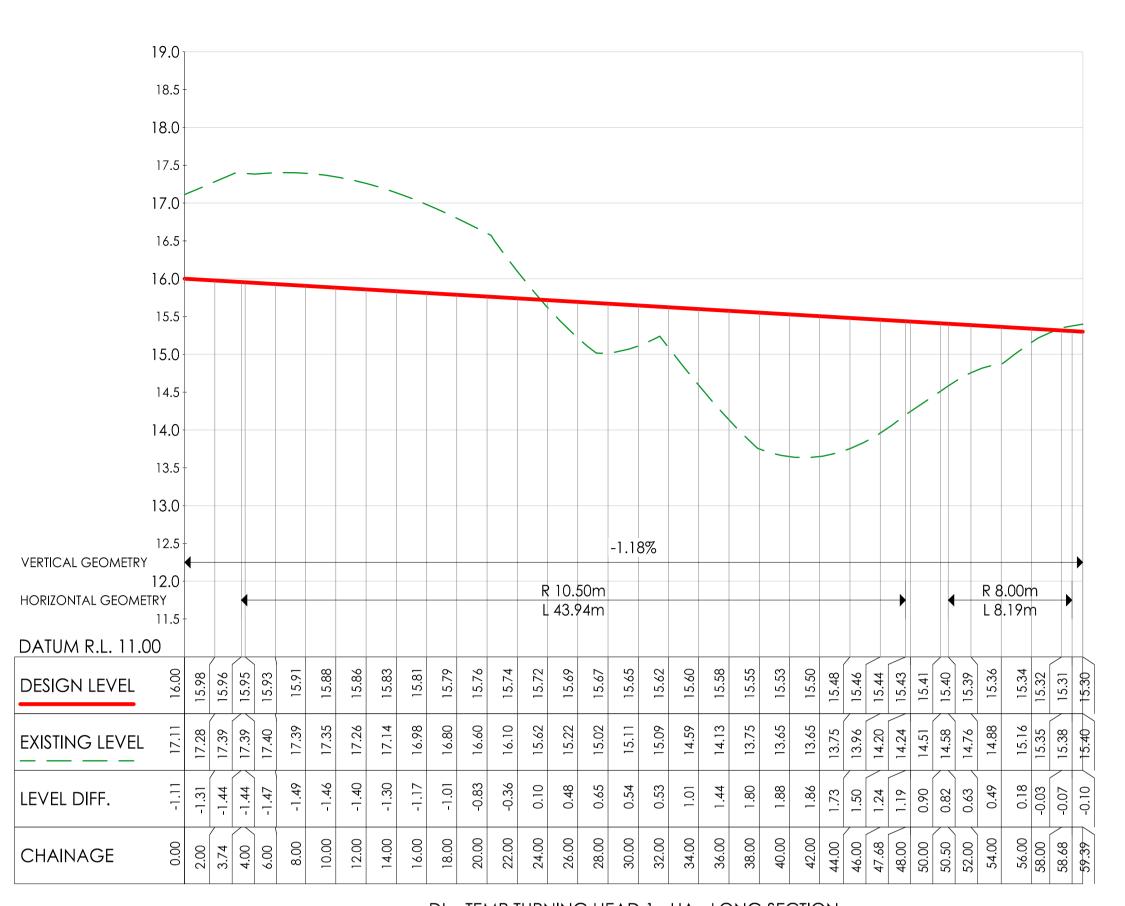
DENOTES ENGINEERED FILL TO T+T TYPE 2 SPECIFICATION (1000780.1000.S1.REV4) AND PREPARED UNDER LEVEL 1 SUPERVISION. (AS PART OF EARLY WORKS).

DENOTES EXTENT OF CUT ( AS PART OF EARLY WORKS)












DL - TEMP TURNING HEAD 1 - HA - LONG SECTION SCALES: HORIZONAL 1:250 VERTICAL 1:50 (5x)

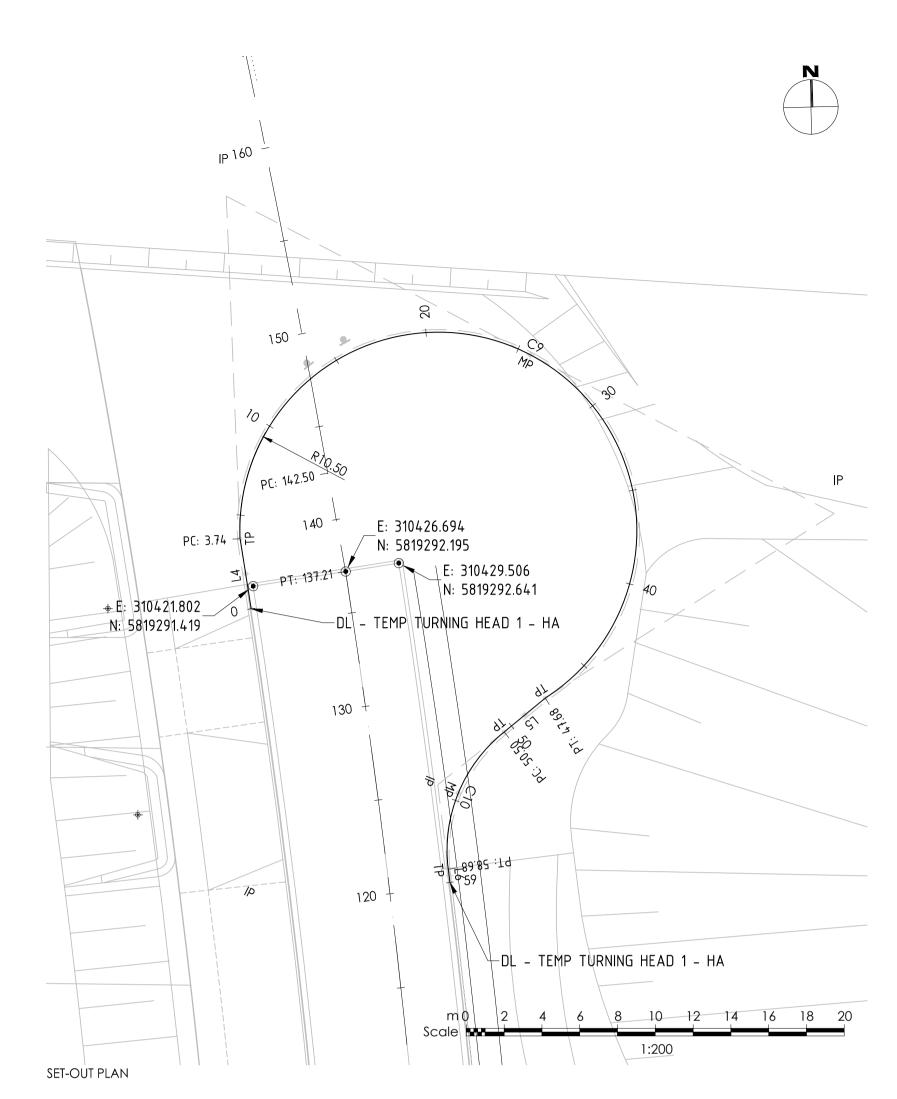


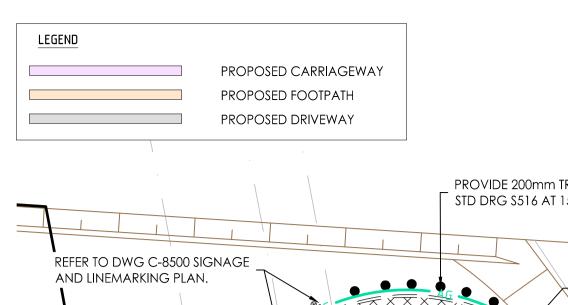

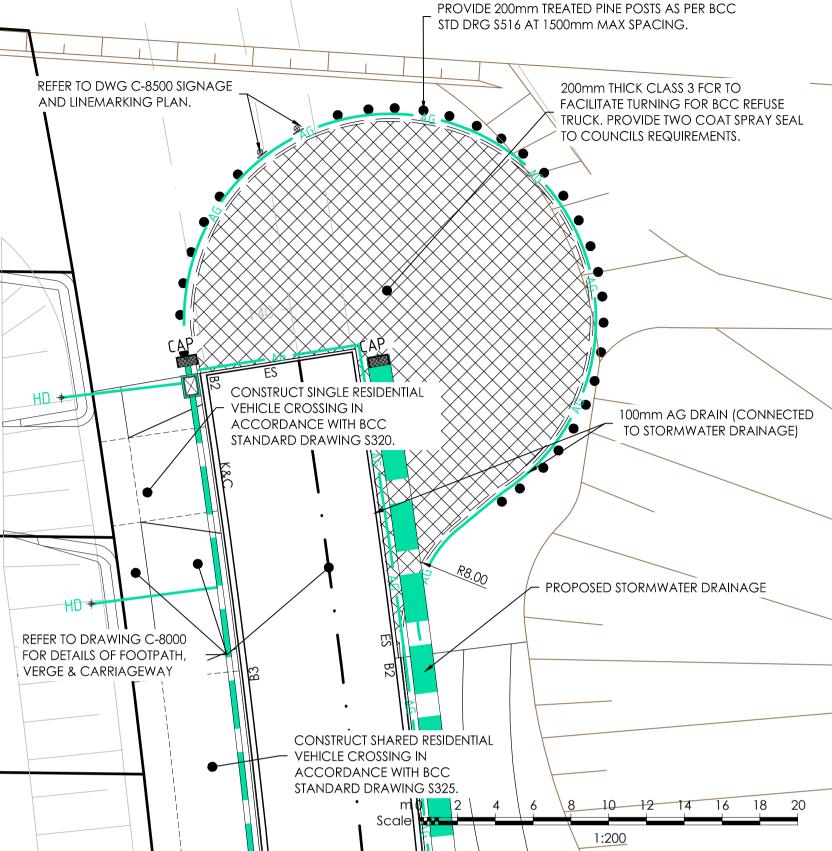

BRIMBANK CITY COUNCIL
Engineering Services
PPROVED PLANS AND SPECIFICATIONS
Vikramt 01 Oct 2021

Set Out Table for DL - TEMP TURNING HEAD 1 - HA									
TAG		CHAINAGE	EASTING	NORTHING	LENGTH	RADIUS	BEARING		
L4	START END	0.00 3.74	310421.695 310421.110	5819290.225 5819293.923	3.74		351° 01′ 25″		
С9	TP IP TP	3.74 -14.53 47.68	310421.110 310421.852 310437.253	5819293.923 5819275.665 5819285.500	43.94	10.5	117° 33' 20.56"		
L5	START END	47.68 50.50	310437.253 310435.081	5819285.500 5819283.710	2.81		230° 30′ 14″		
C10	TP IP TP	50.50 54.99 58.68	310435.081 310431.564 310432.120	5819283.710 5819280.915 5819276.457	8.19	8.0	202° 12' 31.71"		
L6	START END	58.68 59.39	310432.120 310432.209	5819276.457 5819275.753	0.71		172° 49′ 44″		

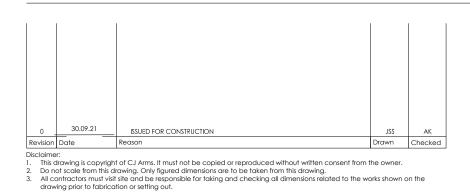

Note for Contractors

The works described on this drawing must be undertaken by competent Contractors with an appropriate level of experience who have prepared appropriate Safe Work Method Statements (SWMS) relating to these works. The contractor is responsible for the management of all risks associated with the construction activities stated on this drawing.

This drawing should not be issued in part and must be read in conjunction with all appropriate specifications, notes pages, details and authority drawings as appropriate.

Dial before you dig. BEWARE OF UNDERGROUND SERVICES. The location of underground services are approximate only and their exact position should be proven on site. No guarantee is given that existing services are shown.







CIVIL SITEWORKS
MELBOURNE T: (03) 9285 2800   E:info@cjarms.com   W:www.cjarms

Project RIVER VALLEY - STAGE 7C Client YOURLAND Drawing Title
DETAILS & SET OUT - TEMP TURN HEAD 1 RIVER VALLEY BLVD ISSUED FOR CONSTRUCTION 1:250 @ A1 17.04.20 15019 CJA 7C DR 5200


DETAILS PLAN

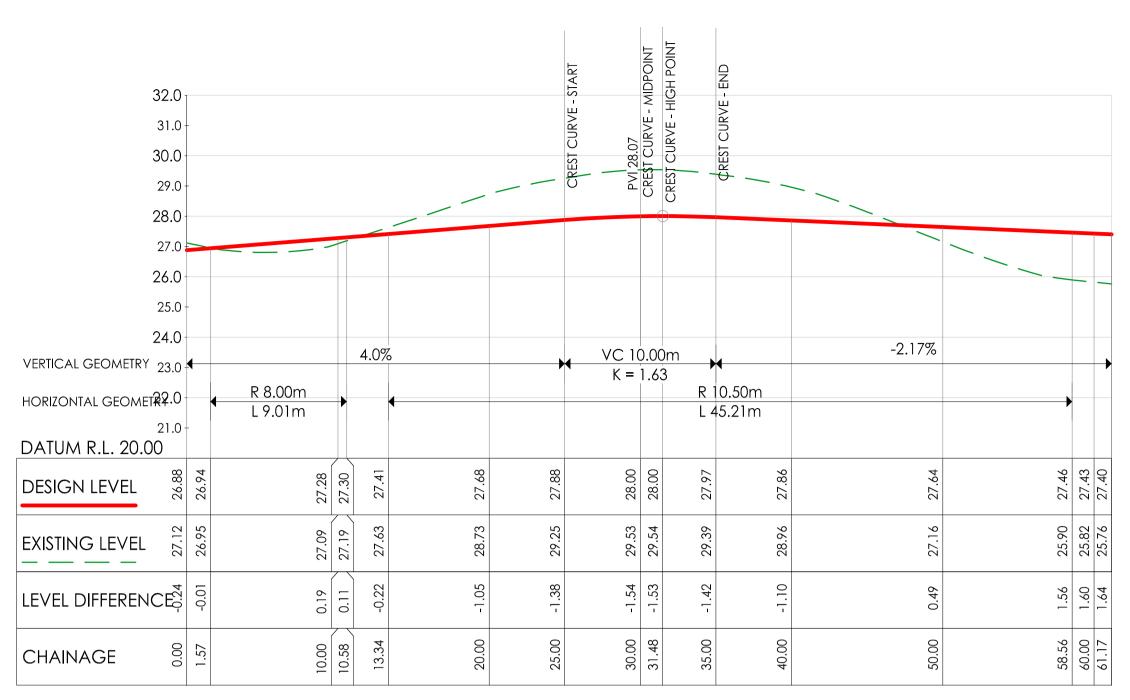

AL -TEMP TURN HEAD 2 - KERB RETURN - LONG SECTION SCALES: HORIZONAL 1:250 VERTICAL 1:125 (2x)

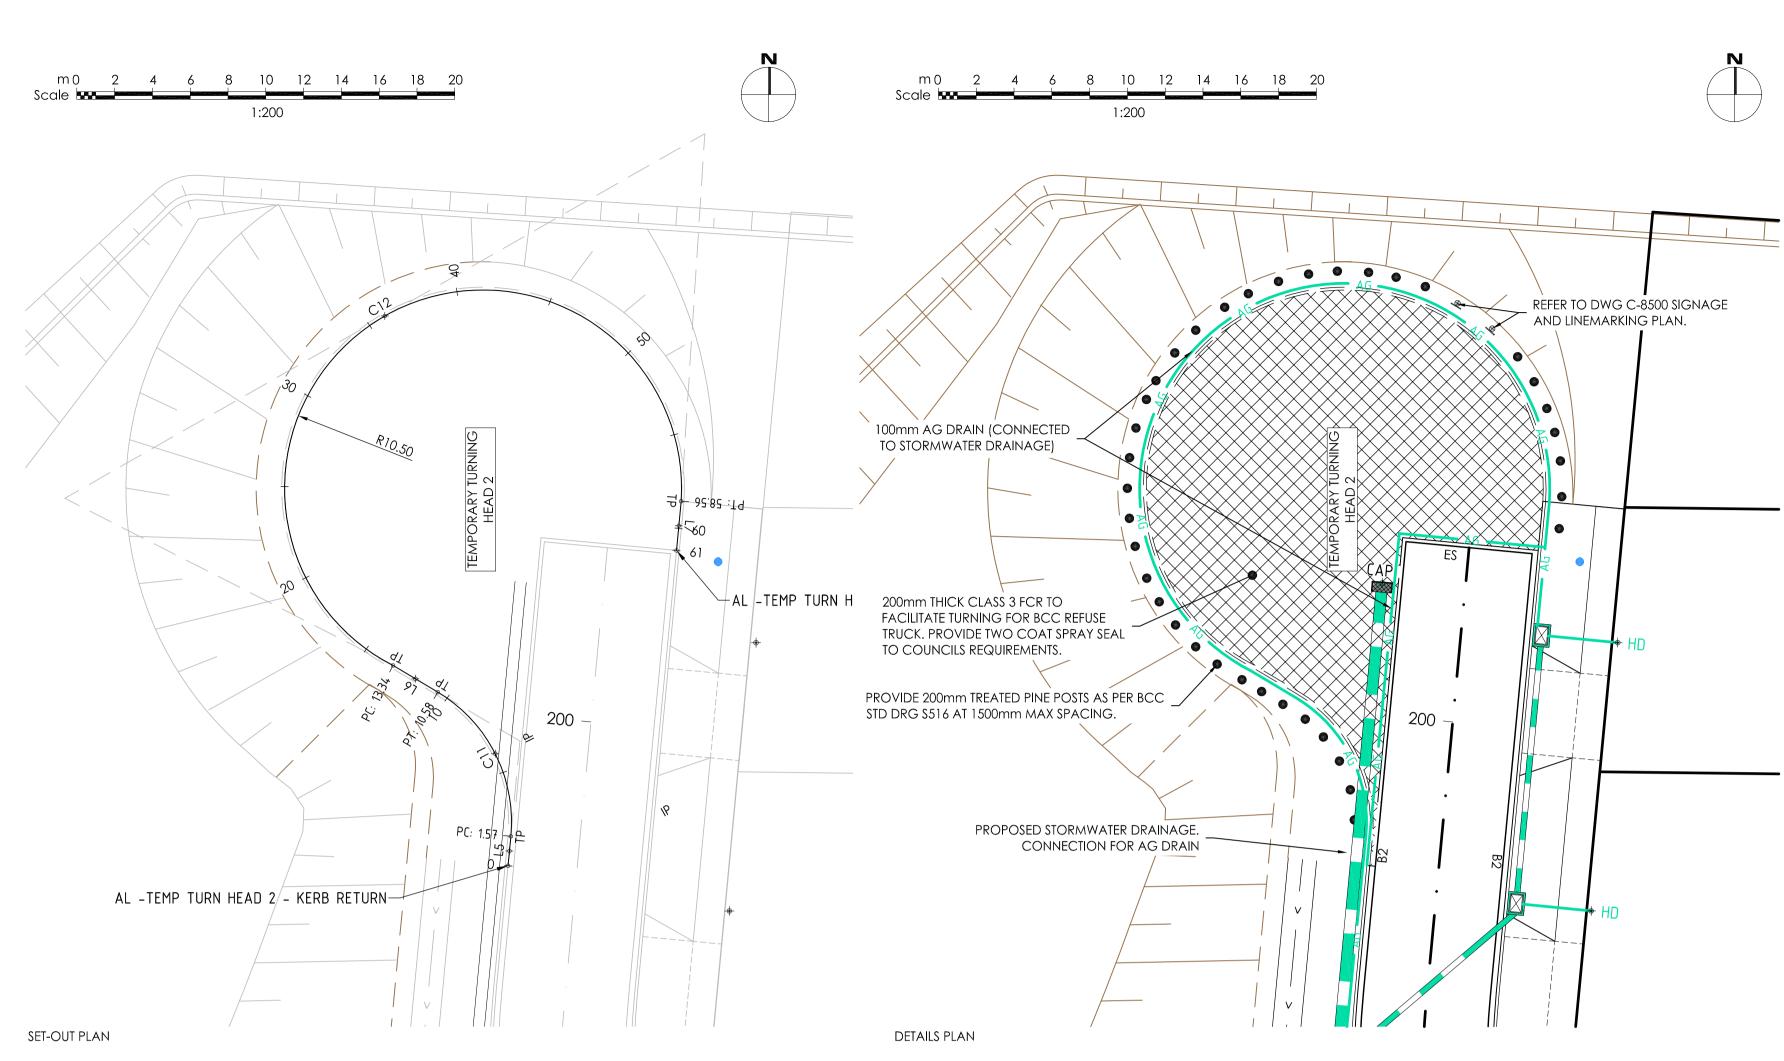

Set Out Table for AL -TEMP TURN HEAD 2 - KERB RETURN									
TAG		CHAINAGE	EASTING	NORTHING	LENGTH	RADIUS	BEARING		
L5	START END	0.00 1.57	310343.498 310343.645	5819278.594 5819280.155	1.57		005° 24′ 06"		
C11	TP IP TP	1.57 6.62 10.58	310343.645 310344.121 310339.782	5819280.155 5819285.186 5819287.777	9.01	8.0	333° 07' 19.04'		
L6	START END	10.58 13.34	310339.782 310337.413	5819287.777 5819289.192	2.76		300° 50′ 32"		
C12	TP IP TP	13.34 -2.61 58.56	310337.413 310351.627 310352.653	5819289.192 5819281.959 5819297.874	45.21	10.5	060° 19' 46.55"		
L7	START END	58.56 61.17	310352.653 310352.407	5819297.874 5819295.274	2.61		185° 24′ 06″		

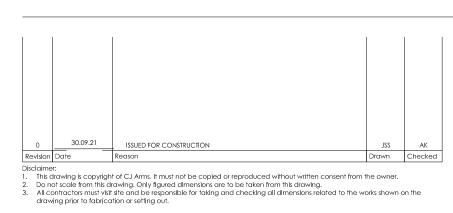

Note for Contractors
The works described on this drawing must be undertaken by competent Contractors with an appropriate level of experience who have prepared appropriate Safe Work Method Statements (SWMS) relating to these works. The contractor is responsible for the management of all risks associated with the construction activities stated on this drawing.

This drawing should not be issued in part and must be read in conjunction with all appropriate specifications, notes pages, details and authority drawings as appropriate.

Dial before you dig. BEWARE OF UNDERGROUND SERVICES. The location of underground services are approximate only and their exact position should be proven on site. No guarantee is given that existing services are shown.








Project
RIVER VALLEY - STAGE 7C
Client
YOURLAND
Purpose of Issue


ISSUED FOR CONSTRUCTION

Project Number Origin
Jone
Level
File Type
Role
Number
Revision

Drawing Title
DETAILS & SET OUT - TEMP TURN HEAD 2
PERRENIAL DRIVE


Drawn By
Checked By
Drawn Scale
Date of First Issue
Role
Date of First Issue
Drawn By
Checked By
Drawn Scale
Date of First Issue
Role
Date of First Issue
Drawn By
Checked By
Drawn Scale
Date of First Issue
Revision
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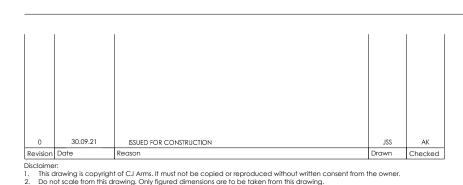


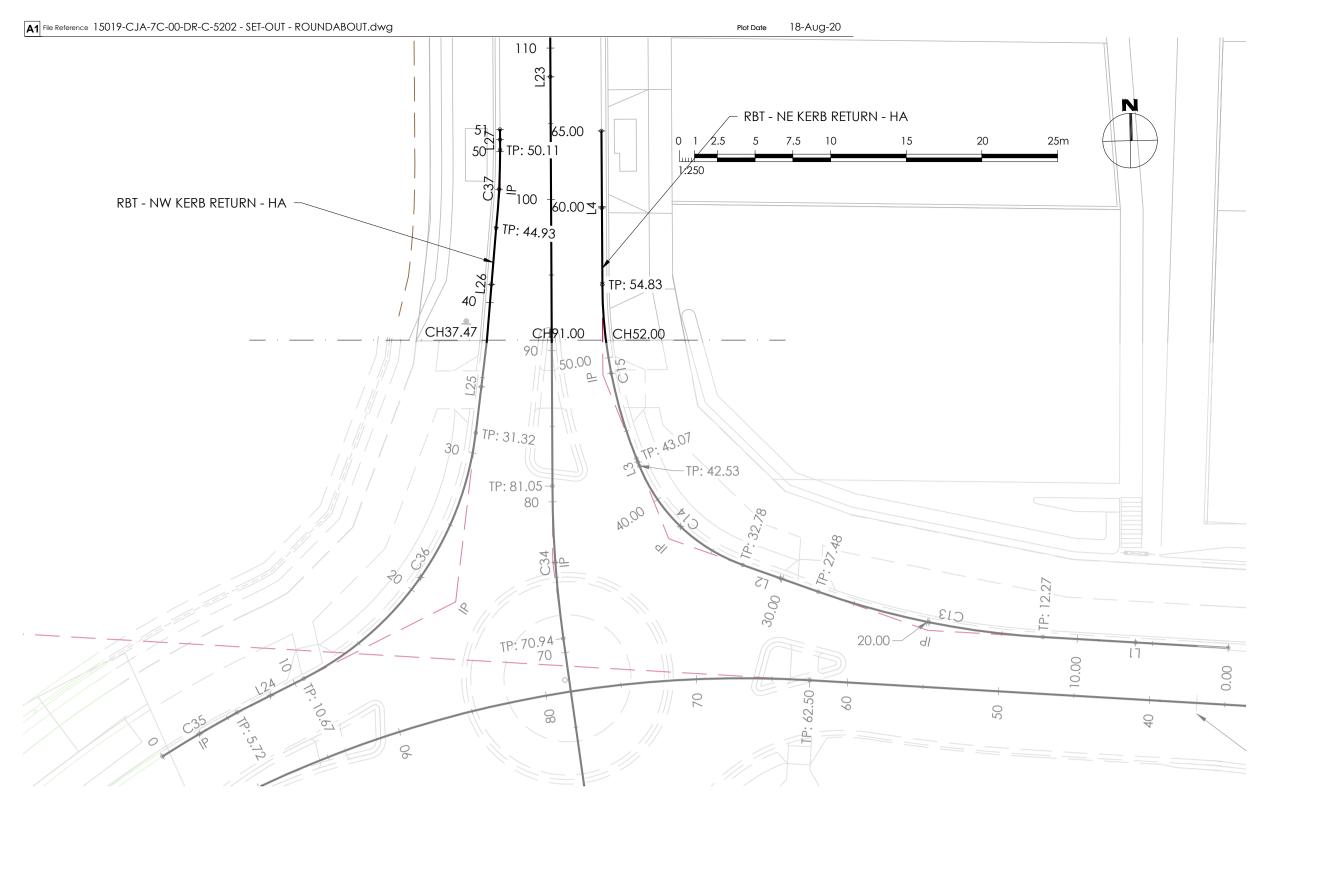	Set Out Table for AL - RBT - NW KERB RETURN - HA											
TAG		CHAINAGE	EASTING	NORTHING	LENGTH	RADIUS	BEARING					
C35	TP IP TP	0.00 2.86 5.72	310323.509 310325.933 310328.440	5819149.535 5819151.056 5819152.437	5.72	100.1	059° 30' 56.22"					
L24	START END	5.72 10.67	310328.440 310332.857	5819152.437 5819154.672	4.95		063° 09′ 46″					
C36	TP IP TP	10.67 21.92 31.32	310332.857 310342.892 310344.228	5819154.672 5819159.749 5819170.916	20.65	21.0	034° 59' 30.06"					
L25	START END	31.32 37.47	310344.228 310344.958	5819170.916 5819177.018	6.14		006° 49′ 14″					
L26	START END	37.47 44.93	310344.958 310345.571	5819177.018 5819184.456	7.46		004° 42′ 50″					
C37	TP IP TP	44.93 47.52 50.11	310345.571 310345.835 310345.843	5819184.456 5819187.033 5819189.623	5.18	52.5	003° 00' 47.78"					
L27	START END	50.11 51.46	310345.843 310345.831	5819189.623 5819190.971	1.35		359° 28′ 28″					

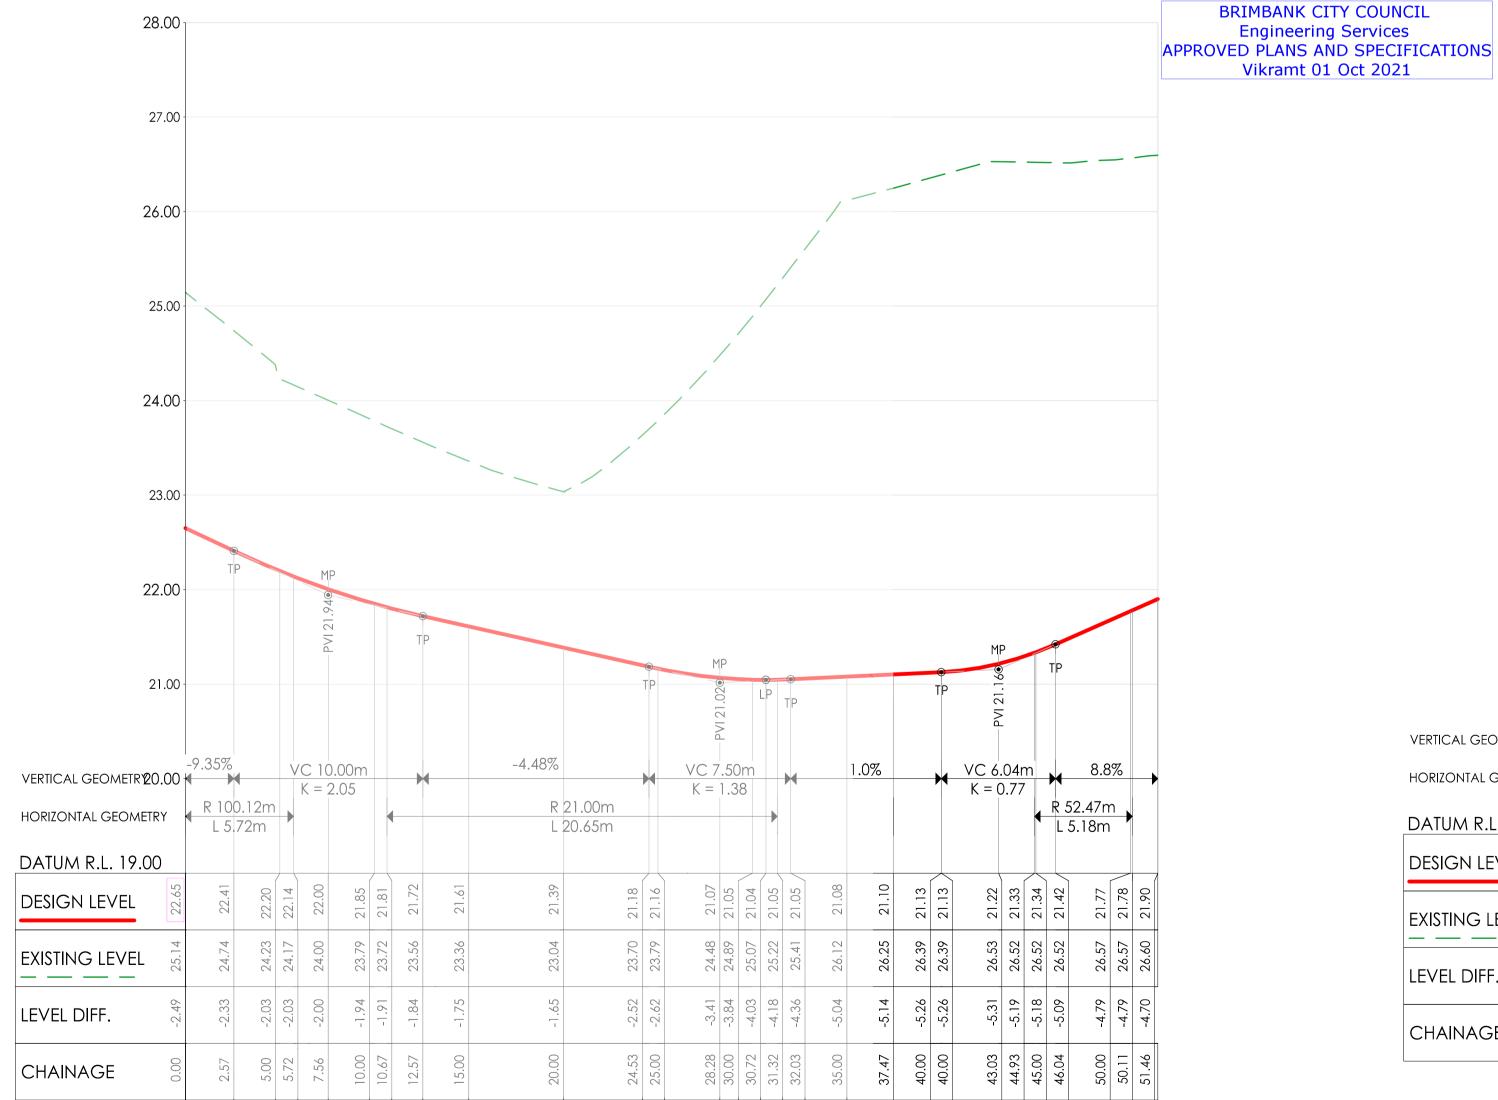



AL - RBT - NE KERB RETURN - HA - LONG SECTION SCALES: HORIZONAL 1:100 VERTICAL 1:20 (5x)

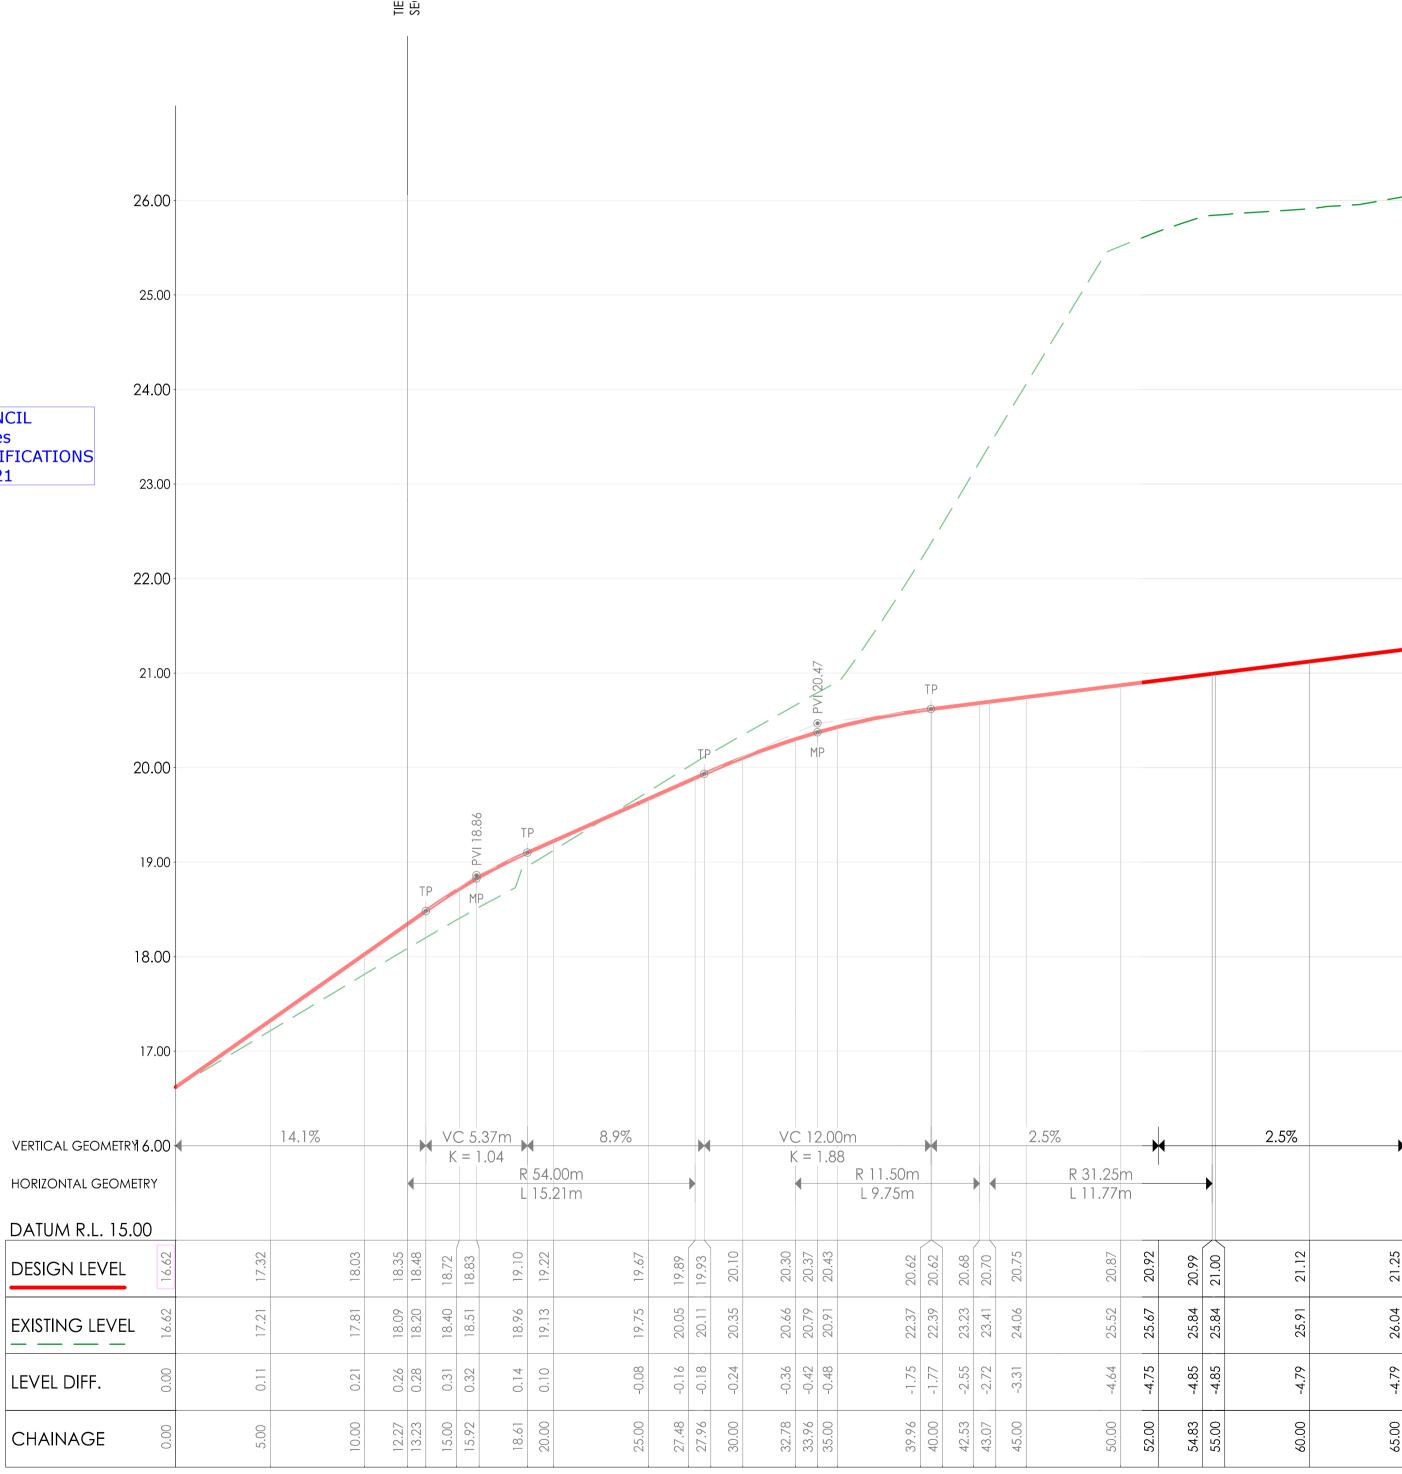

Note for Contractors

The works described on this drawing must be undertaken by competent Contractors with an appropriate level of experience who have prepared appropriate Safe Work Method Statements (SWMS) relating to these works. The contractor is responsible for the management of all risks associated with the construction activities stated on this drawing.

AL - RBT - NW KERB RETURN - HA - LONG SECTION SCALES: HORIZONAL 1:100 VERTICAL 1:20 (5x)

This drawing should not be issued in part and must be read in conjunction with all appropriate specifications, notes pages, details and authority drawings as appropriate.

Dial before you dig. BEWARE OF UNDERGROUND SERVICES. The location of underground services are approximate only and their exact position should be proven on site. No guarantee is given that existing services are shown.

NOTE : CONTRACTOR SHALL SEQUENCE WORKS ON SITE WITH STAGE 7B ROUNDABOUT. ROUNDABOUT SUBJECT TO SEPARATE APPROVAL.

BRIMBANK CITY COUNCIL

**Engineering Services** 

Vikramt 01 Oct 2021





15019 CJA 7C

T: (03) 9285 2800 | E: info@cjarms.com | W: www.cjarms.com Project RIVER VALLEY - STAGE 7C Drawing Title
DETAILS & SET OUT - ROUNDABOUT YOURLAND ISSUED FOR CONSTRUCTION 1:250 @ A1

DR

5202

A1 File Reference 15019-CJA-7C-00-DR-C-6100 - PROPOSED STORMWATER LONG SECTIONS.dwg Plot Date 5-Oct-20

0 30.09.21 ISSUED FOR CONSTRUCTION
Revision Date Reason




Drawing Title
LONG SECTIONS - STORMWATER

H1:500 V 1:50 @ A1 20.08.20


Number 6100

SHEET (1 OF 3)


DR

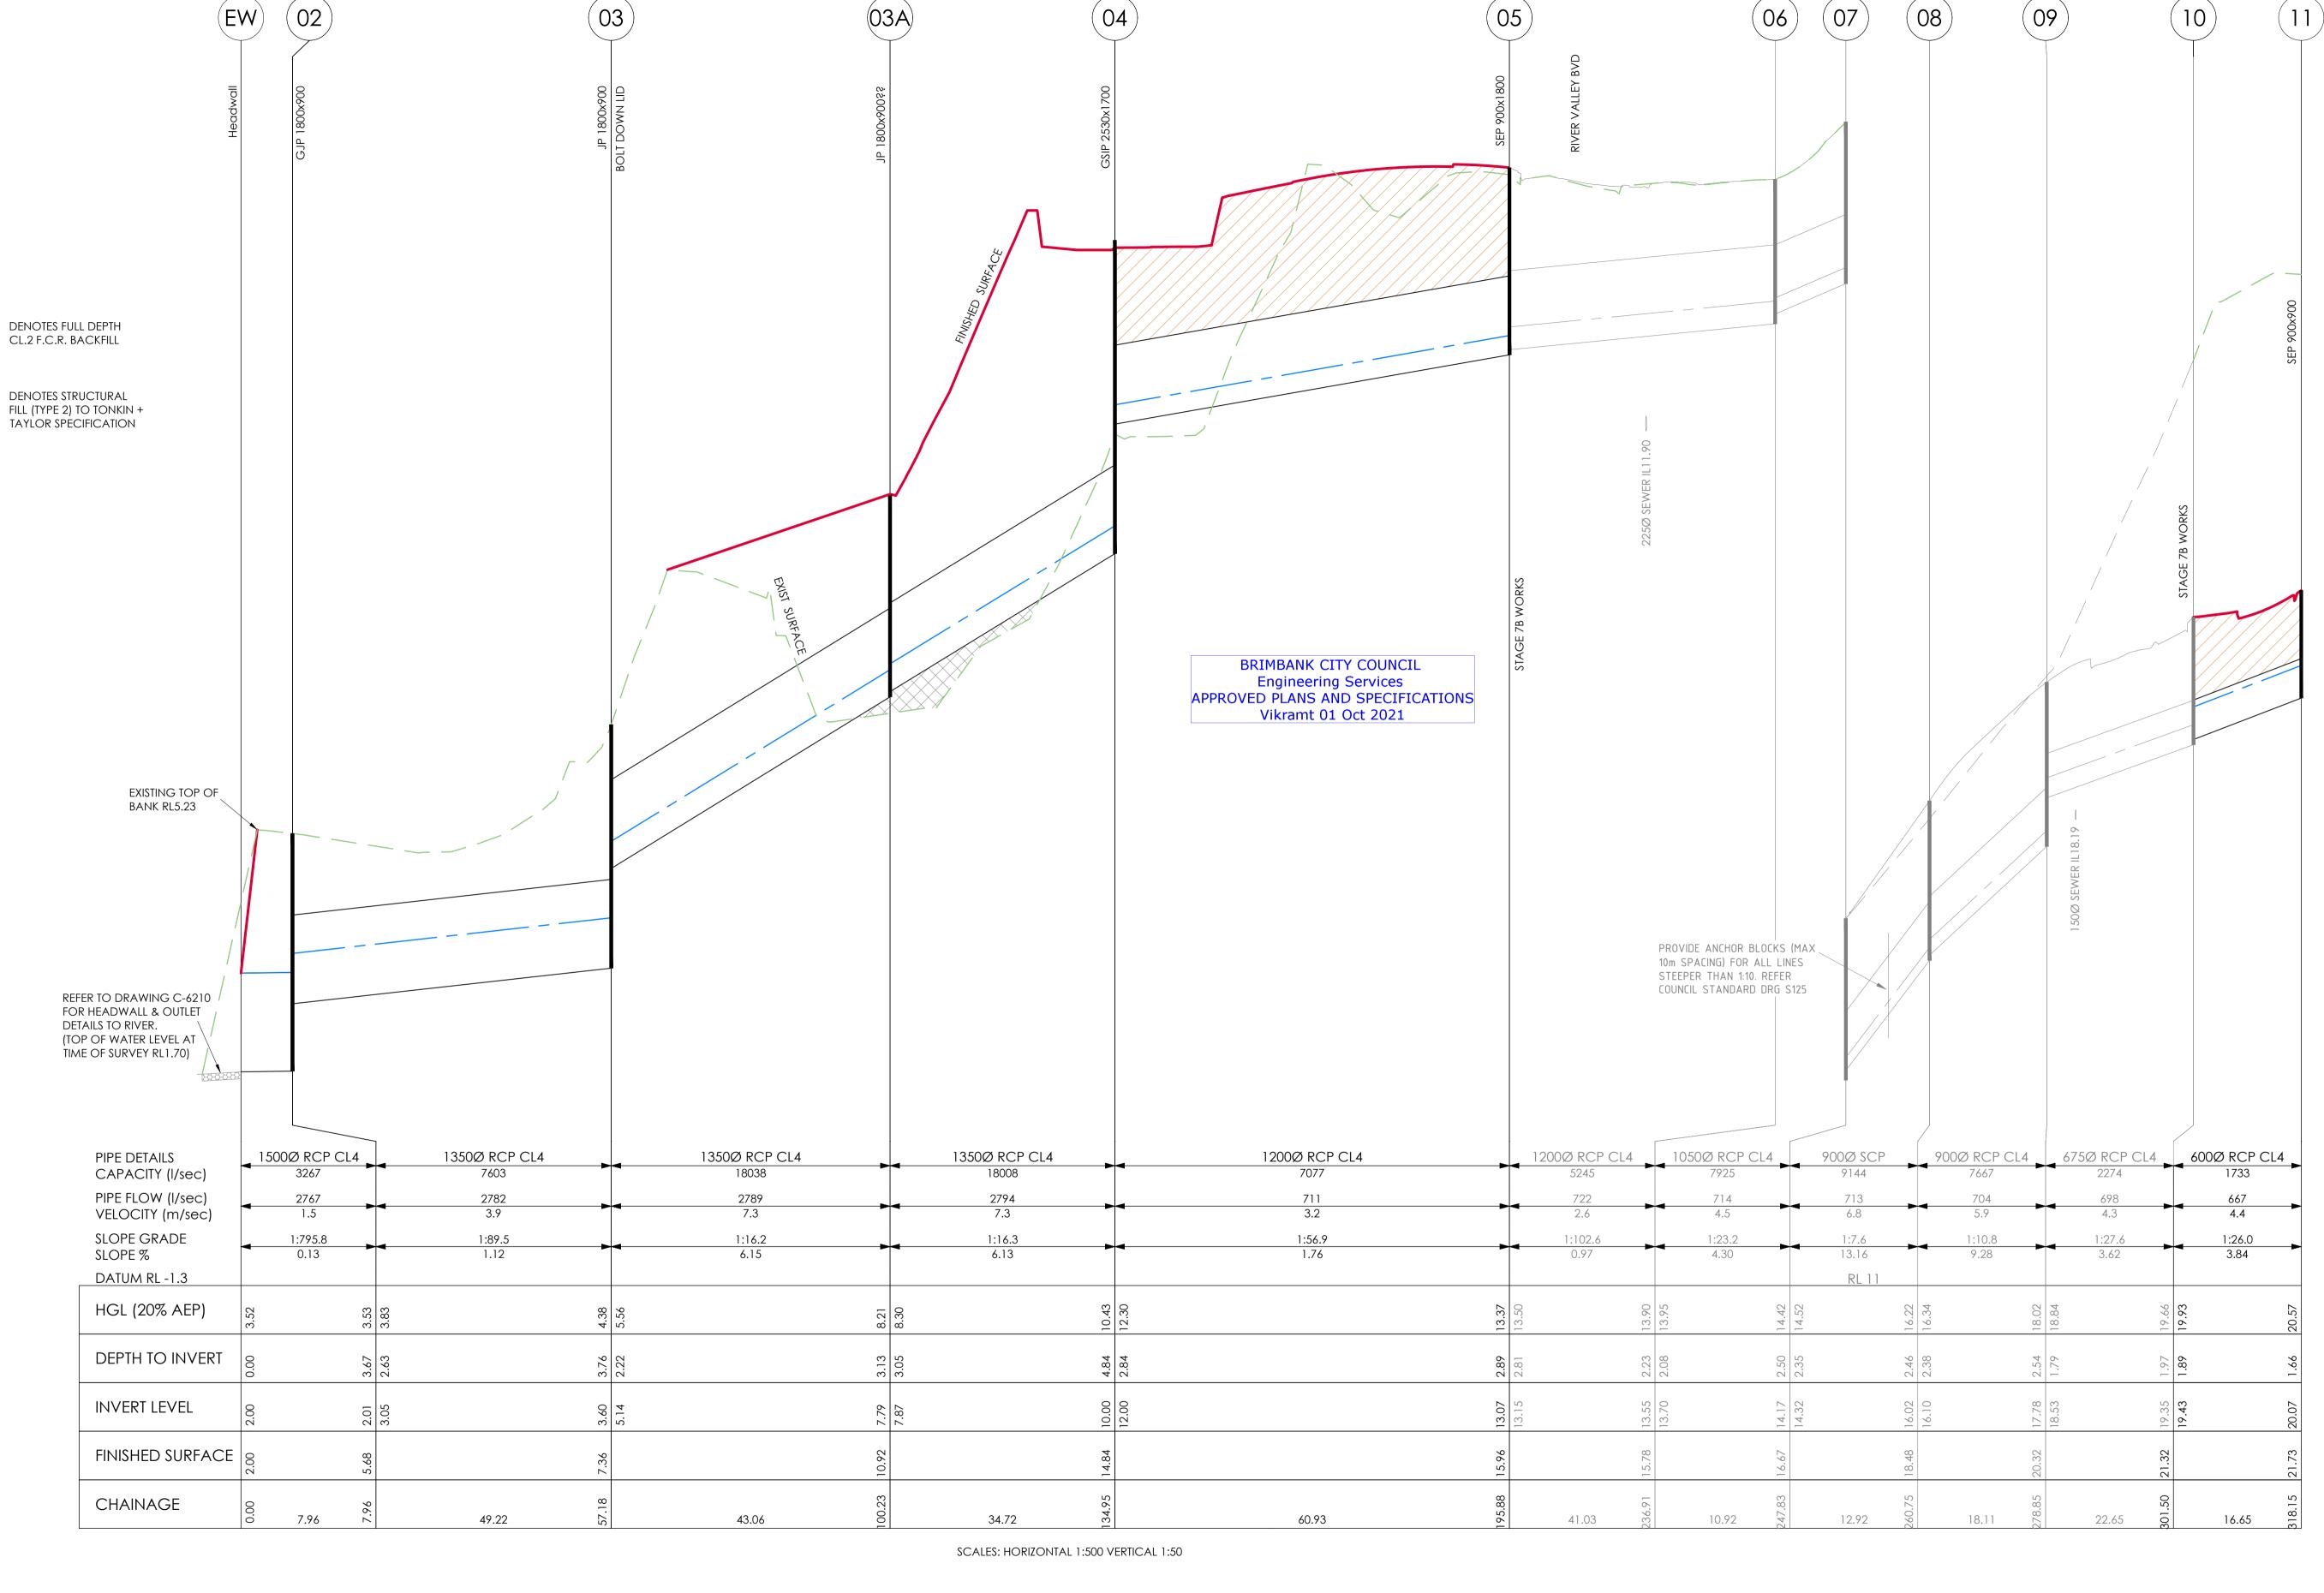


ISSUED FOR CONSTRUCTION www.cjarms.com 15019 CJA 7C XX

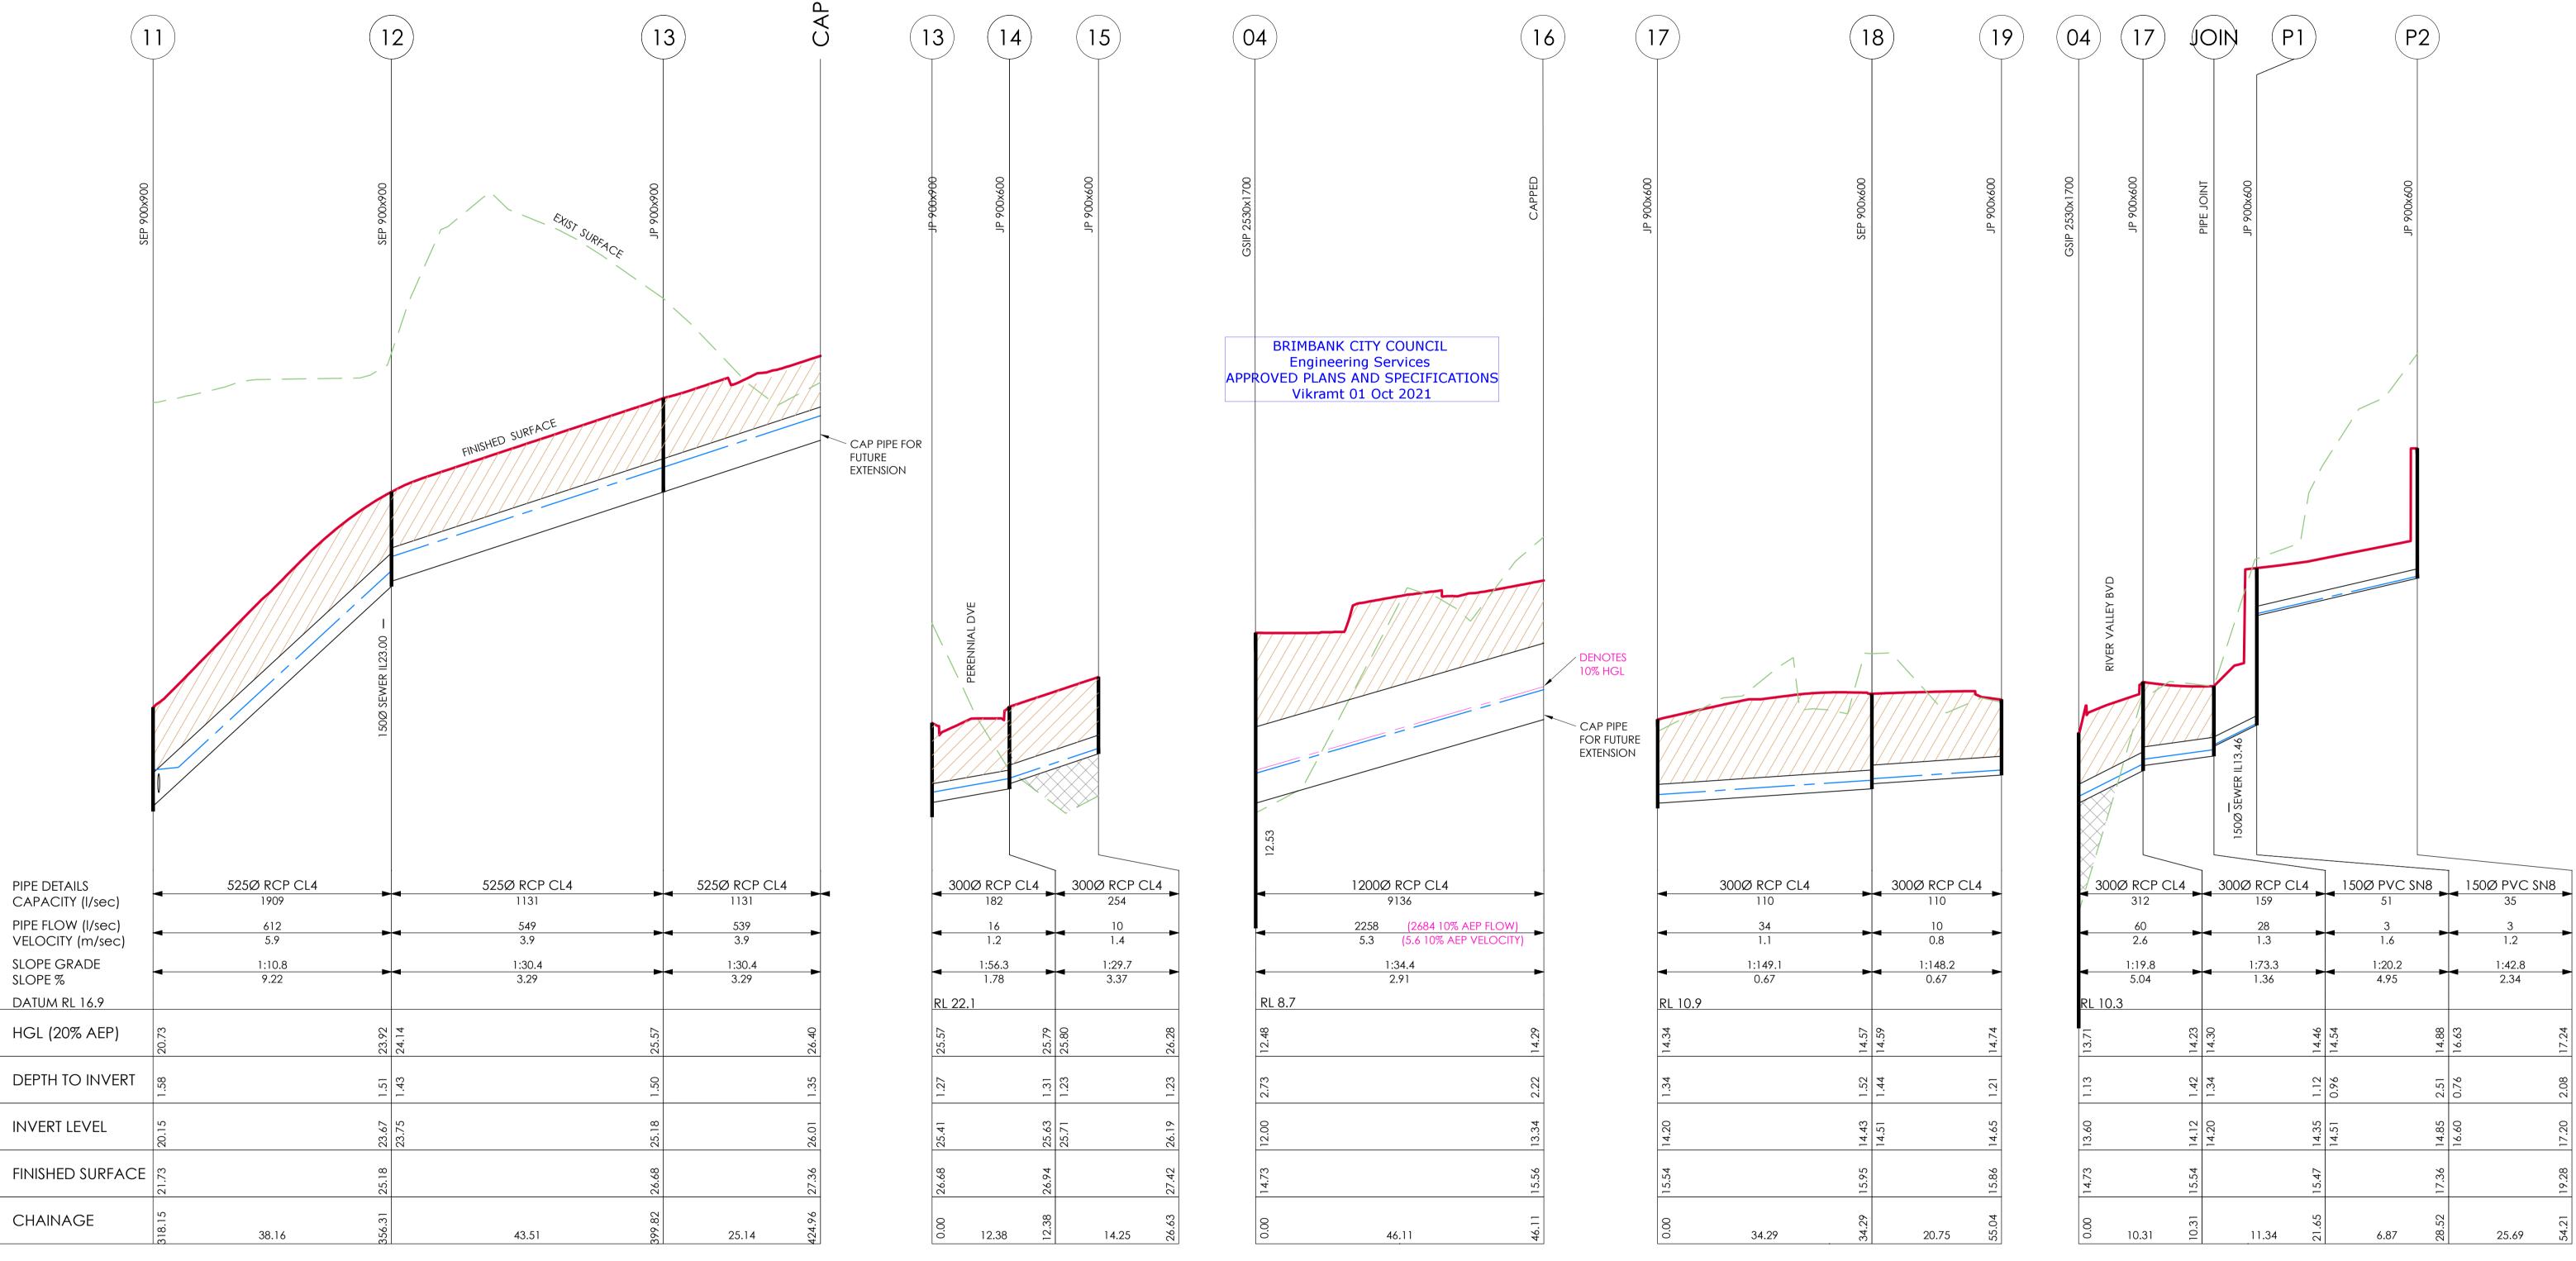

SCALES: HORIZONTAL 1:500 VERTICAL 1:50

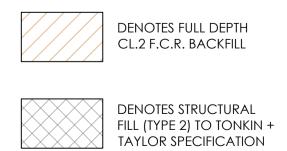

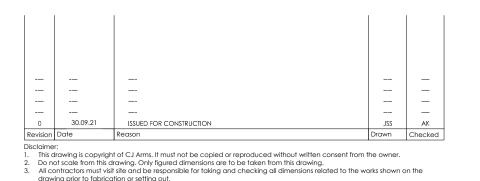





0 2 5	10	15 2	20 25	35		50m			
1:500									
N N	MELBOURNE	SITEW(	ORKS	cjarms.com					
Project RIVER VAL	LEY - ST	AGE 7C			Drawing Title LONG SECTIONS - STORMWATER				
Client YOURLANI	D				SHEET (2 OF	3)			
Purpose of Issue				Drawn By	Checked By	Drawn Scale	Date of First Issue		
ISSUED FO	r cons	TRUCTION	l	PS	AK	H1:500 V1:50 @ A1	20.08.20		
Project Number	Origin	Zone	Level	File Type	Role	Number	Revision		
15019	$\bigcap A$	70	YY	UB	$\subset$	6101	$\cap$		

300Ø RCP CL4

1:73.3 1.36

45.43

DENOTES FULL DEPTH CL.2 F.C.R. BACKFILL

DENOTES STRUCTURAL FILL (TYPE 2) TO TONKIN + TAYLOR SPECIFICATION

> PIPE DETAILS CAPACITY (I/sec)

PIPE FLOW (I/sec) VELOCITY (m/sec)

SLOPE GRADE

DATUM RL 10.9

HGL (20% AEP)

DEPTH TO INVERT


FINISHED SURFACE

INVERT LEVEL

CHAINAGE

SLOPE %



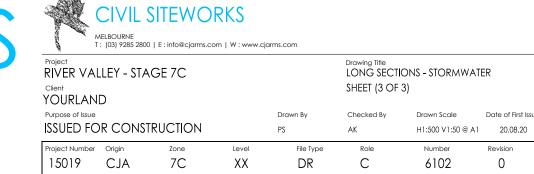

PRIVATE PIT - PIT DETAIL TO BCC \$205

5	CIVIL SITEWORKS  MELBOURNE T: (03) 9285 2800   E: info@cjarms.com   W: www.cjarms.com										
	Project RIVER VALLEY - STAGE 7C Client YOURLAND		Drawing Title LONG SECTI SHEET (3 OF	ions - stormwati 3)	ER						
	Purpose of Issue ISSUED FOR CONSTRUCTION	Drawn By PS	Checked By AK	Drawn Scale H1:500 V1:50 @ A1	Date o						

S

5	//	5	
	•		Project RIVER V
			Client

AR	$\langle \rangle$	MELBOURNE T: (03) 9285 2800   E: info@cjarms.com   W: www.cjarms.com						
/ \ \ \ \ \ \ \ \ \ \ \ \ \ \ \ \ \ \ \	V 10	Project RIVER VALLEY - STAGE 7C	Drawing Title LONG SECTIONS - STORM					
		Client YOURLAND		SHEET (3 OF	3)			
		Purpose of Issue	Drawn By	Checked By	Drawn Scale			
		ISSUED FOR CONSTRUCTION	PS	AK	H1:500 V1:50			

	150Ø SEWER IL22.88 —		
300Ø RCP CL4 183	300Ø RCP CL4 417	300Ø RCP CL4 257	
61	50 3.1	17	
1:55.7 1.79	1:11.2 8.92	1:28.9 3.46	
RL 17.1			
20.73	20.81	24.21	
1.36	1.24	1.20	
20.37	20.61	23.97	

8.92

36.79

SCALES: HORIZONTAL 1:500 VERTICAL 1:50

ISSUED FOR CONSTRUCTION

32.35

(22)

BRIMBANK CITY COUNCIL

Engineering Services
APPROVED PLANS AND SPECIFICATIONS

Vikramt 01 Oct 2021

LIP OF KERB

BACK OF KERB

(23)

DRAINAGE DESIGN LINE -LIP OF KERB BACK OF KERB REFERENCE POINT (CENTRE OF BASE) VARIES REFER TO

REFERENCE POINT

1800 x 900 PIT (CENTRE OF BASE)

DETAIL C ENDWALL SET-OUT POINT SCALE 1:100

REFERENCE POINT

- 1800 x 900 PIT (CENTRE OF BASE)

REFERENCE POINT PIPE BASE CENTRE

- DRAINAGE DESIGN LINE

PIT 03

PIPE SET-OUT

SCALE 1:100

REFERENCE POINT - 1800 x 900 PIT (CENTRE OF BASE)

PIPE SET-OUT SCALE 1:100

PIT 05 PIPE SET-OUT SCALE 1:100

REFERENCE POINT (CENTRE OF BASE) ☐ DRAINAGE DESIGN LINE

				>	, 100	' PI	T SCHEDUL	E				
DETAIL												
PIT SET-OU					HAU	JNCHED P	CHED PIT SET-OUT POINT					
PITS TO BE HAUNCHED BEHIND BACK OF KERB UNLESS NOTED OTHERWISE. SCALE 1:100												
								Р	it Sch	_		
	ر	ç	dth	gth	leter	. RL	eter	RL				

	Pit Schedule													
Pit No.	Pit Type	Lid Width	Lid Length	Base Width	Base Length	Outlet Diameter	Outlet Invert RL	Inlet Diameter	Inlet Invert RL	Pit Depth	Pit Lid Level	Easting	Northing	Comment
		(mm)	(mm)	(mm)	(mm)	(mm)	(m)	(mm)	(m)	(m)	(m)	(m)	(m)	
EW	HWALL							1500	2.00	0.00	2.00	310555.49	5819197.64	MELBOURNE WATER OUTLET. REFER DRAWING C-6210
02	GJP	600	900	1800	900	1500	2.01	1350	3.05	3.67	5.68	310547.54	5819197.95	PIT DETAIL TO BCC \$205. HAUNCH TO VICROADS \$D1023
03	JP	600	900	1800	900	1350	3.75	1350	5.14	3.61	7.36	310498.36	5819199.98	PIT DETAIL TO BCC \$205. HAUNCH TO VICROADS \$D1023 BOLT DOWN LID
03A	JP	600	900	1800	900	1350	7.79	1350	7.87	3.13	10.92	310464.05	5819225.99	PIT DETAIL TO BCC \$205. HAUNCH TO VICROADS \$D1023
04	GSIP	900	2530	1700	2530	1350	10.00	300	13.60	4.84	14.84	310436.12	5819246.62	MAJOR FLOW COLLECTION PIT. REFER DRAWING C-6200
								1200	12.00					
								1200	12.00					
05	JP	600	900	1800	900	1200	13.07	1200	13.15	2.89	15.96	310436.16	5819185.73	PIT DETAIL TO BCC \$205. HAUNCH TO VICROADS \$D1023
11	SEP	600	900	900	900	600	20.07	300	20.37	1.66	21.73	310344.72	5819186.99	PIT DETAIL TO BCC \$200. HAUNCH TO BCC \$255
								525	20.15					
12	SEP	600	900	900	900	525	23.67	525	23.75	1.51	25.18	310344.57	5819225.15	PIT DETAIL TO BCC \$200. HAUNCH TO BCC \$255
13	JP	600	900	900	900	525	25.18	525	25.26	1.50	26.68	310341.81	5819268.58	PIT DETAIL TO BCC \$205. HAUNCH TO BCC \$255
								300	25.41					
14	JP	600	900	600	900	300	25.63	300	25.71	1.31	26.94	310351.24	5819276.60	PIT DETAIL TO BCC \$205
15	JP	600	900	600	900	300	26.19			1.23	27.42	310352.59	5819290.78	PIT DETAIL TO BCC \$205

						525	20.15					
600	900	900	900	525	23.67	525	23.75	1.51	25.18	310344.57	5819225.15	PIT DETAIL TO BCC \$200. HAUNCH TO BCC \$255
600	900	900	900	525	25.18	525	25.26	1.50	26.68	310341.81	5819268.58	PIT DETAIL TO BCC \$205. HAUNCH TO BCC \$255
						300	25.41					
600	900	600	900	300	25.63	300	25.71	1.31	26.94	310351.24	5819276.60	PIT DETAIL TO BCC \$205
600	900	600	900	300	26.19			1.23	27.42	310352.59	5819290.78	PIT DETAIL TO BCC \$205
				1200	13.34			2.22	15.56	310430.87	5819292.40	
600	900	600	900	300	14.12	300	14.20	1.42	15.54	310425.85	5819245.68	PIT DETAIL TO BCC \$205
						300	14.20					
600	900	600	900	300	14.43	300	14.51	1.52	15.95	310426.78	5819211.40	PIT DETAIL TO BCC \$200
600	900	600	600	300	14.65			1.21	15.86	310425.96	5819190.67	PIT DETAIL TO BCC \$205
600	900	600	900	300	14.82			1.14	15.96	310420.98	5819290.85	PIT DETAIL TO BCC \$205
600	900	600	900	300	20.53	300	20.61	1.32	21.85	310353.45	5819188.81	PIT DETAIL TO BCC \$200
600	900	600	900	300	23.89	300	23.97	1.28	25.17	310353.21	5819225.60	PIT DETAIL TO BCC \$200
600	900	600	900	300	25.09			1.21	26.30	310351.08	5819257.88	PIT DETAIL TO BCC \$205
600	900	600	900	150	14.85	150	16.60	2.51	17.36	310417.76	5819256.82	PRIVATE PIT - PIT DETAIL TO BCC \$205

2.08 19.28 310392.08 5819257.13

# PIT TYPE KEY

600 900

16

17

19 20

21

23

CAP

JP

18 SEP 600

SEP

SEP

JP = JUNCTION PIT
GJP = GRATED JUNCTION PIT
SEP = SIDE ENTRY PIT
GSEP= GRATED SIDE ENTRY PIT
GSIP = GRATED SURFACE INLET PIT

600 900


## NOTES:

150 17.20


- 1. ALL SETOUT POINTS (COORDINATES) ARE TO CENTRE OF PIT BASE OR AS SHOWN 2. PIPES ARE ALIGNED TO CENTER OF ALL PIT BASES EXCEPT PITS 01,02, 03 & 05
- 3. STEP IRONS REQUIRED FOR ALL PITS GREATER THAN 900mm DEEP. PROVIDE IN
- ACCORDANCE WITH BCC STANDARD DETAIL \$275
- 4. ALL DRAINAGE WORKS TO BE TO BRIMBANK CITY COUNCIL SPECIFICATIONS 5. ALL PIT COVERS IN ROAD RESERVE TO BE HEAVY DUTY GATIC (CLASS 'D')

PIPE BEDDING SPECIFICATION										
LAYER	MATERIAL SPECIFICATION	COMPACTION SPECIFICATION								
BACKFILL (TYPE 1)	SITE WON FILL MATERIAL.	COMPACTED TO ACHIEVE A MINIMUM DENSITY OF ADJACENT MATERIAL. TO BE COMPACTED IN MAX 150mm LAYERS.								
BACKFILL (TYPE 2)		COMPACTED TO ACHIEVE A MINIMUM 98% (MODIFIED) IN ACCORDANCE WITH AS1289.5.2.1. TO BE COMPACTED IN MAX 150mm LAYERS.								
BASE LAYER	SIZE 20mm CLASS 2 CRUSHED ROCK COMPLYING WITH VICROADS SPECIFICATION SECTION 812.	COMPACTED TO ACHIEVE A MINIMUM 98% (MODIFIED) IN ACCORDANCE WITH AS1289.5.2.1. TO BE COMPACTED IN MAX 150mm LAYERS.								


BRIMBANK CITY COUNCIL **Engineering Services** APPROVED PLANS AND SPECIFICATIONS
Vikramt 01 Oct 2021

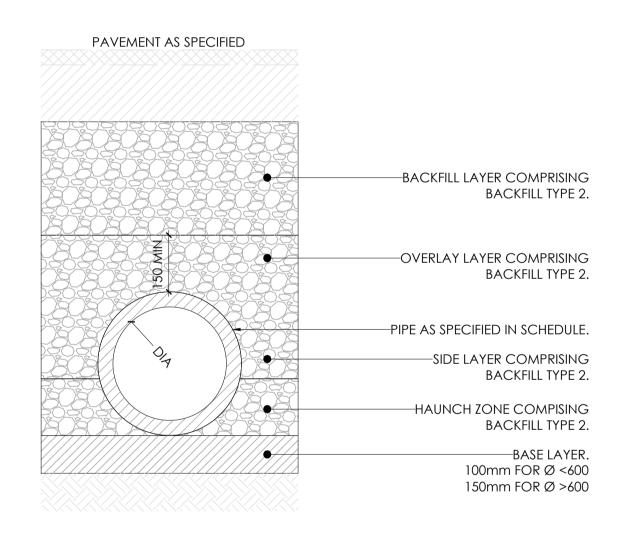

PT.01 TYPICAL PIPE TRENCH (UNDER PAVEMENTS) SCALE 1:10

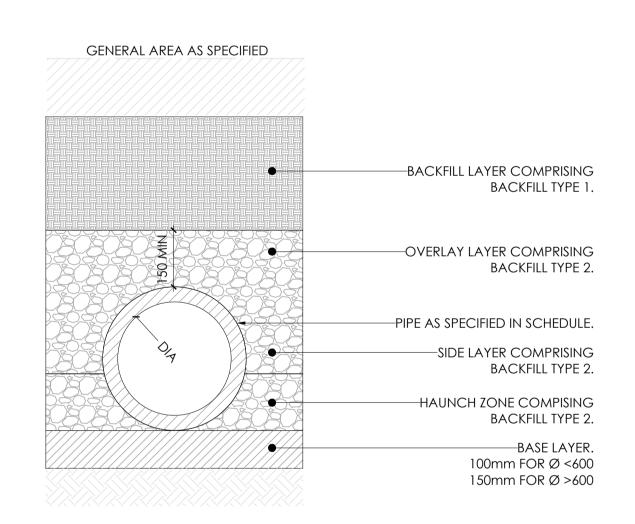

PT.02 TYPICAL PIPE TRENCH (GENERAL AREAS) SCALE 1:10

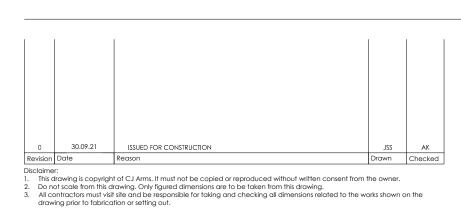



DR

0 2 5 10 15 20 25 35

GRATED COVER TO COUNCIL  $\mathbin{\smallfrown}$ 

1200Ø

SPECIFICATIONS

3.18 2.53

0.82

SETOUT POINT (CENTRE OF LID)

SCALE 1:25

<u> 0.0</u> INV 12.00

0.35

-0.35

PROVIDE 2 OF 'FRANKSTON CONCRETE PRODUCTS 1200 x —

900 HEAVY DUTY GALVANISED 2 PART GRATE & FRAME' OR

EQUIVALENT SUBJECT TO THE APPROVAL OF COUNCIL.

1200Ø

- STEP IRONS LOCATED CENTRAL UNDER 1200W GRATE OPENING.

LIP OF KERB

INVERT OF KERB BACK OF KERB

1200Ø

REFER BCC STD DRG \$275

0.25

0.36

- 150 x 150 PRECAST CONCRETE

- 75mm

1200Ø

LINTEL (OR CAST IN-SITU)

INV 12.00 v

0.35


1350Ø

3.23


RIVER VALLEY BOULEVARD SAG PIT 04 - PLAN VIEW

NOTE: REFER TO MELBOURNE WATER STANDARD DRAWINGS 7251/08/410 & 411 FOR REINFORCEMENT AND BENCHING REQUIREMENTS.

BRIMBANK CITY COUNCIL **Engineering Services** APPROVED PLANS AND SPECIFICATIONS Vikramt 01 Oct 2021

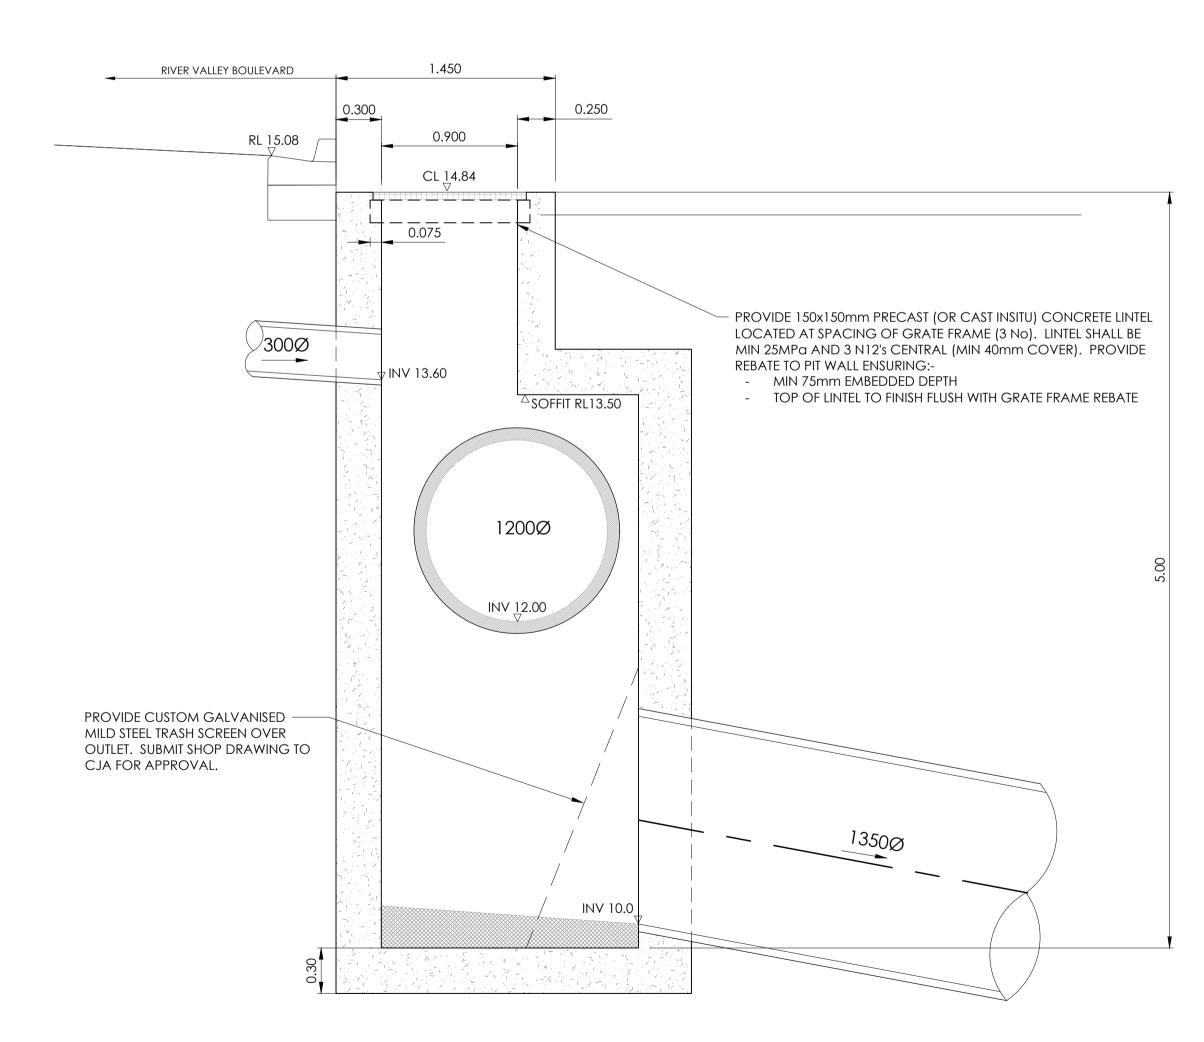

S.02 RIVER VALLEY BOULEVARD SAG PIT - SECTION VIEW SCALE 1:25

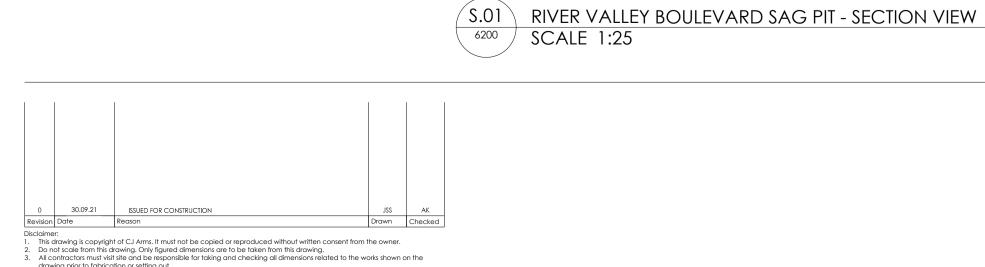






www.cjarms.com

TABLE.01 - WATERCOURSE OUTLET DIMENSIONS										
ITEM	DIMENSION (LENGTH)	MATERIAL SPECIFICATION								
PRIMARY ROCK CHUTE	6.0m (MINIMUM)	400ø (D50/D90 = 0.8) ROCK IN 50-150mm GRADED SHOT ROCK BEDDING (MIN 150mm DEPTH) ON 150mm MIN COMPACTED THICKNESS CLASS 3 CRUSHED ROCK, COMPACTED TO ACHIEVE A MINIMUM 98% (MODIFIED) IN ACCORDANCE WITH AS1289.5.2.1.								
ROCK APRON	to suit site conditions	400ø (D50/D90 = 0.8) ROCK IN 50-150mm GRADED SHOT ROCK BEDDING (MIN 150mm DEPTH) ON 150mm MIN COMPACTED THICKNESS CLASS 3 CRUSHED ROCK, COMPACTED TO ACHIEVE A MINIMUM 98% (MODIFIED) IN ACCORDANCE WITH AS1289.5.2.1.								


## **NOTES**

PRIOR TO THE COMMENCEMENT OF WORKS ON MELBOURNE VATER'S ASSET, THE CONTRACTOR MUST APPLY FOR INSPECTION VIA THE LINK BELOW FOR APPROVAL/PERMITS TO WORK ON LIVE ASSET(S). PENALTIES APPLY FOR UNAUTHORISED WORKS. TTPS://WWW.MELBOURNEWATER.COM.AU/PLANNING-AND-UILDING/APPLY-TO-BUILD-OR-DEVELOP/INSPECTION-WORK

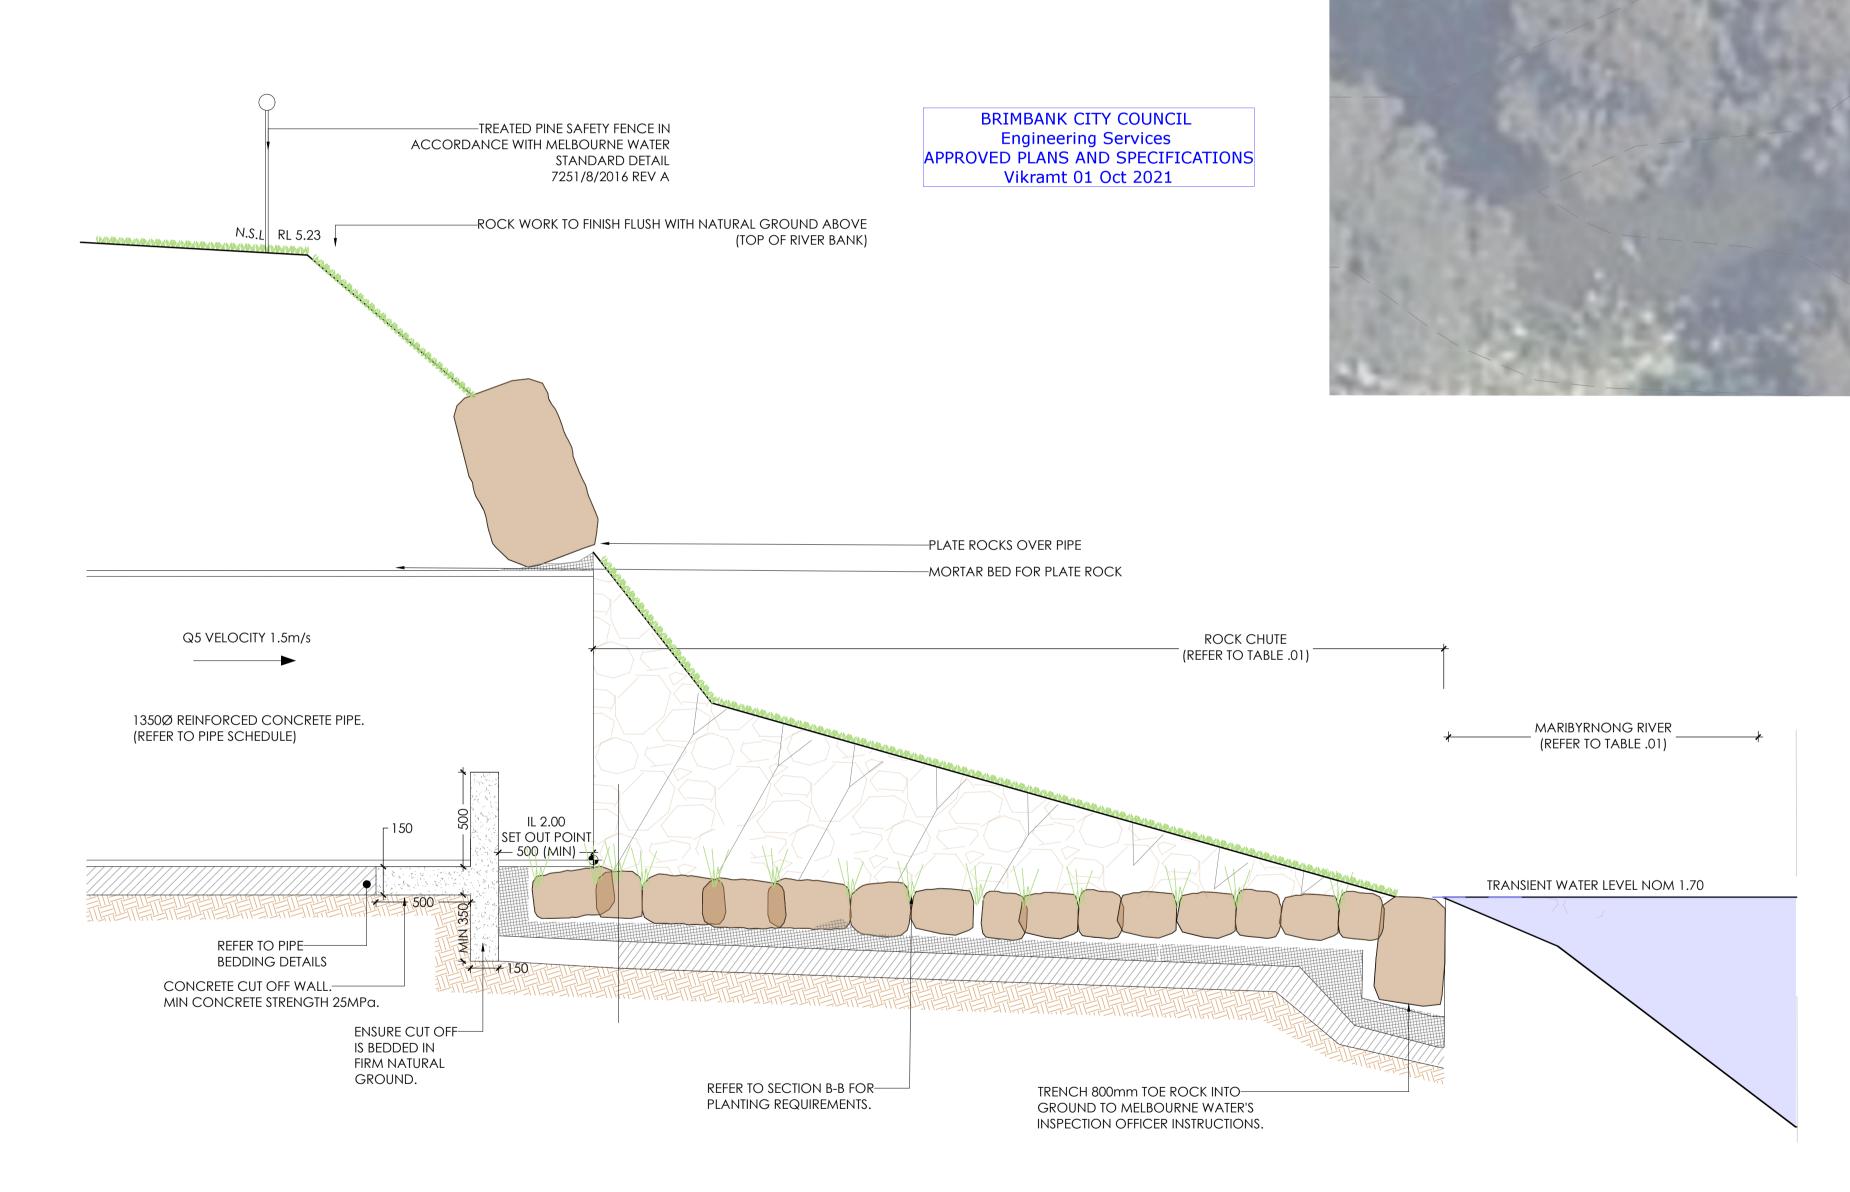

SO.01 SO.01 - WATERCOURSE OUTLET DETAIL- L/S C-C SCALE 1:20

• CONTRACTOR TO PROVIDE ROCKWORK SAMPLES FOR CJA APPROVAL PRIOR TO INSTALLATION.

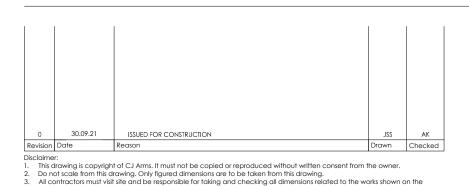





TREATED PINE SAFETY BARRIER FENCE REFER TO MW STD.-

TITLE BOUNDARY

MARIBYRNONG RIVER

DIRECTION OF FLOW

0 0.5 1 2 3 4 5

TOP OF BANK

DRG. 7251/08/206




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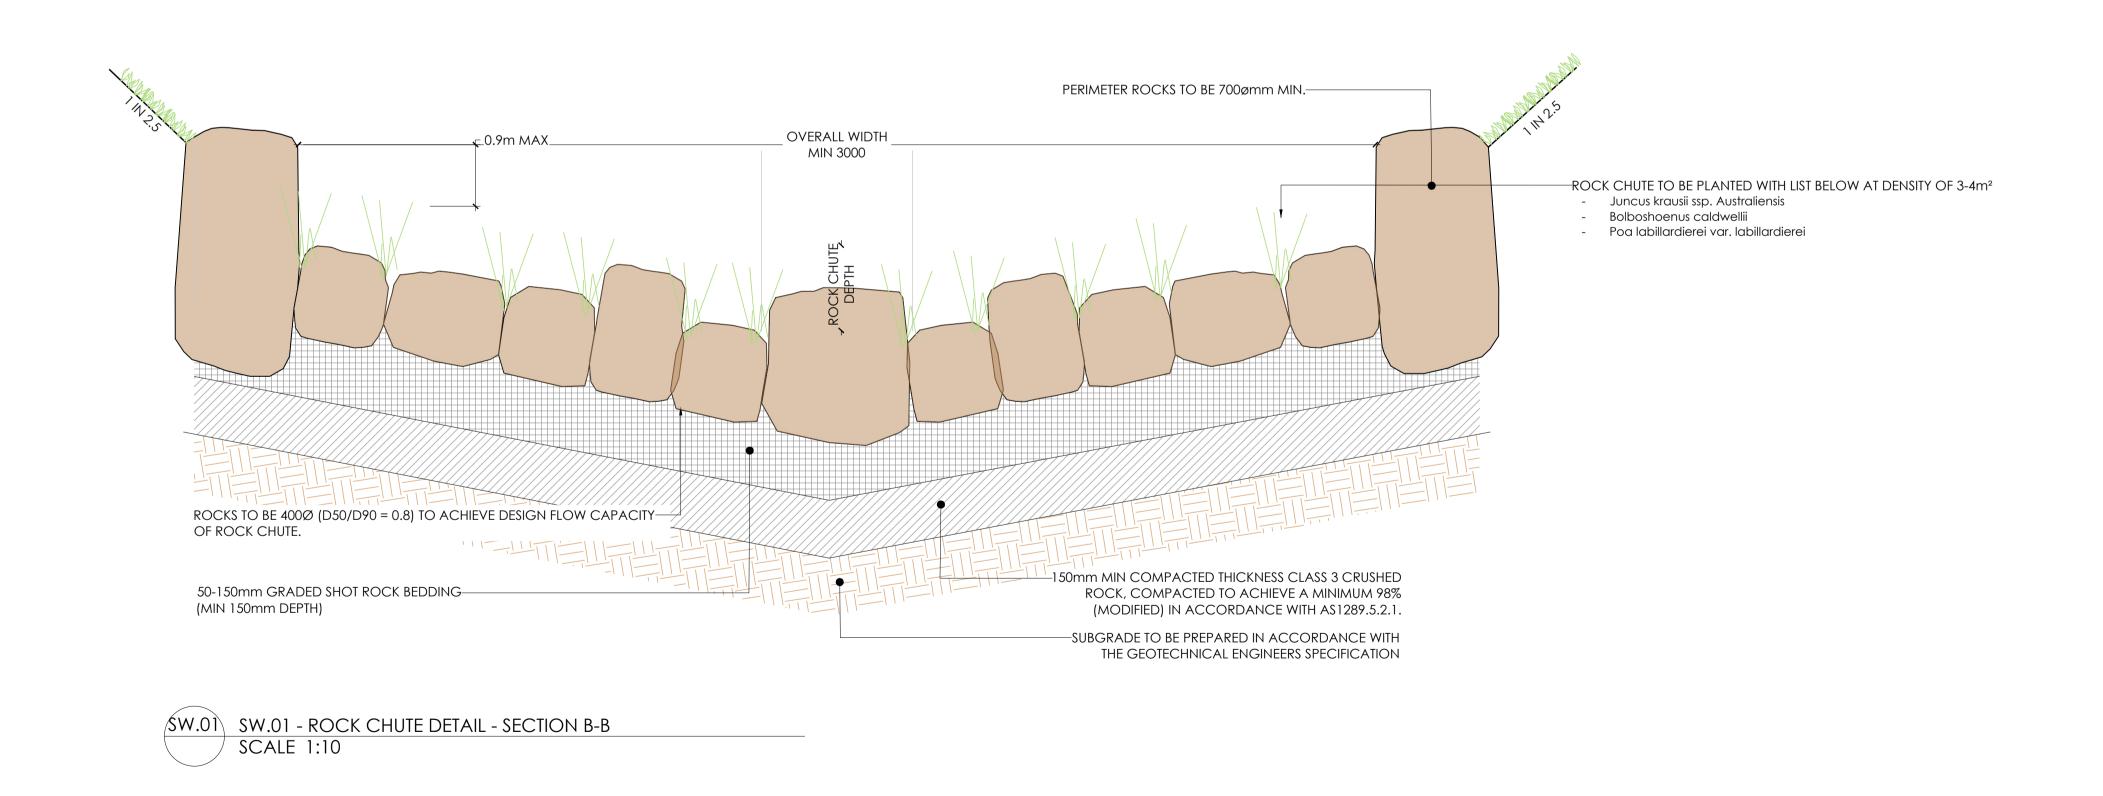
AS SHOWN @ A1 26.02.21


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SO.02 SO.02 - WATERCOURSE OUTLET DETAIL - SECTION A-A SCALE 1:50 CONTRACTOR TO PROVIDE ROCKWORK SAMPLES FOR CJA APPROVAL PRIOR TO INSTALLATION.


BRIMBANK CITY COUNCIL **Engineering Services** APPROVED PLANS AND SPECIFICATIONS Vikramt 01 Oct 2021



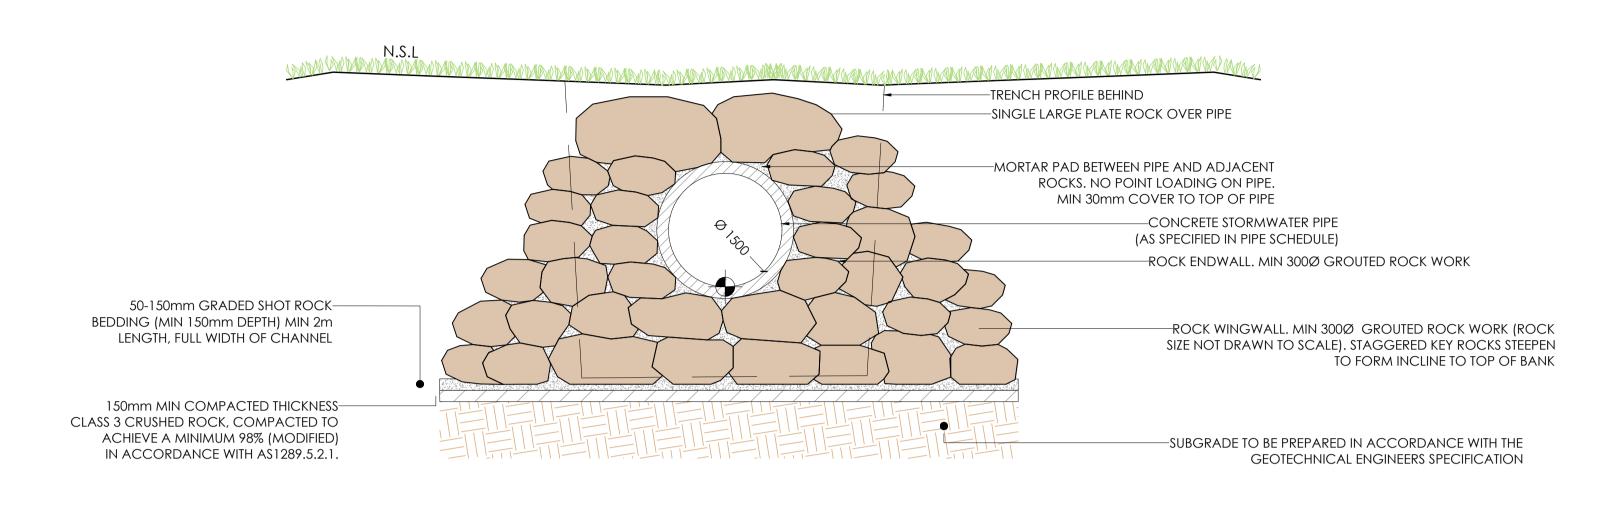



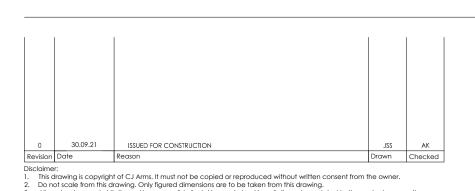

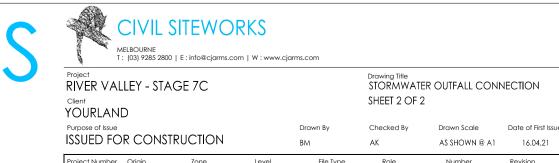


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BGRADE TO BE PROOF ROLLED AND CBR TEST RESU

BE SUBMITTED TO BCC SURVEILLANCE OFFICER FO

AP.02 - PERENNIAL DRIVE - ASPHALT TRAFFICKABLE PAVEMENT DETAIL 01

PAVEMENT DESIGN IS BASED ON THE THE GEOTECHNICAL ENGINEERS DESIGN:

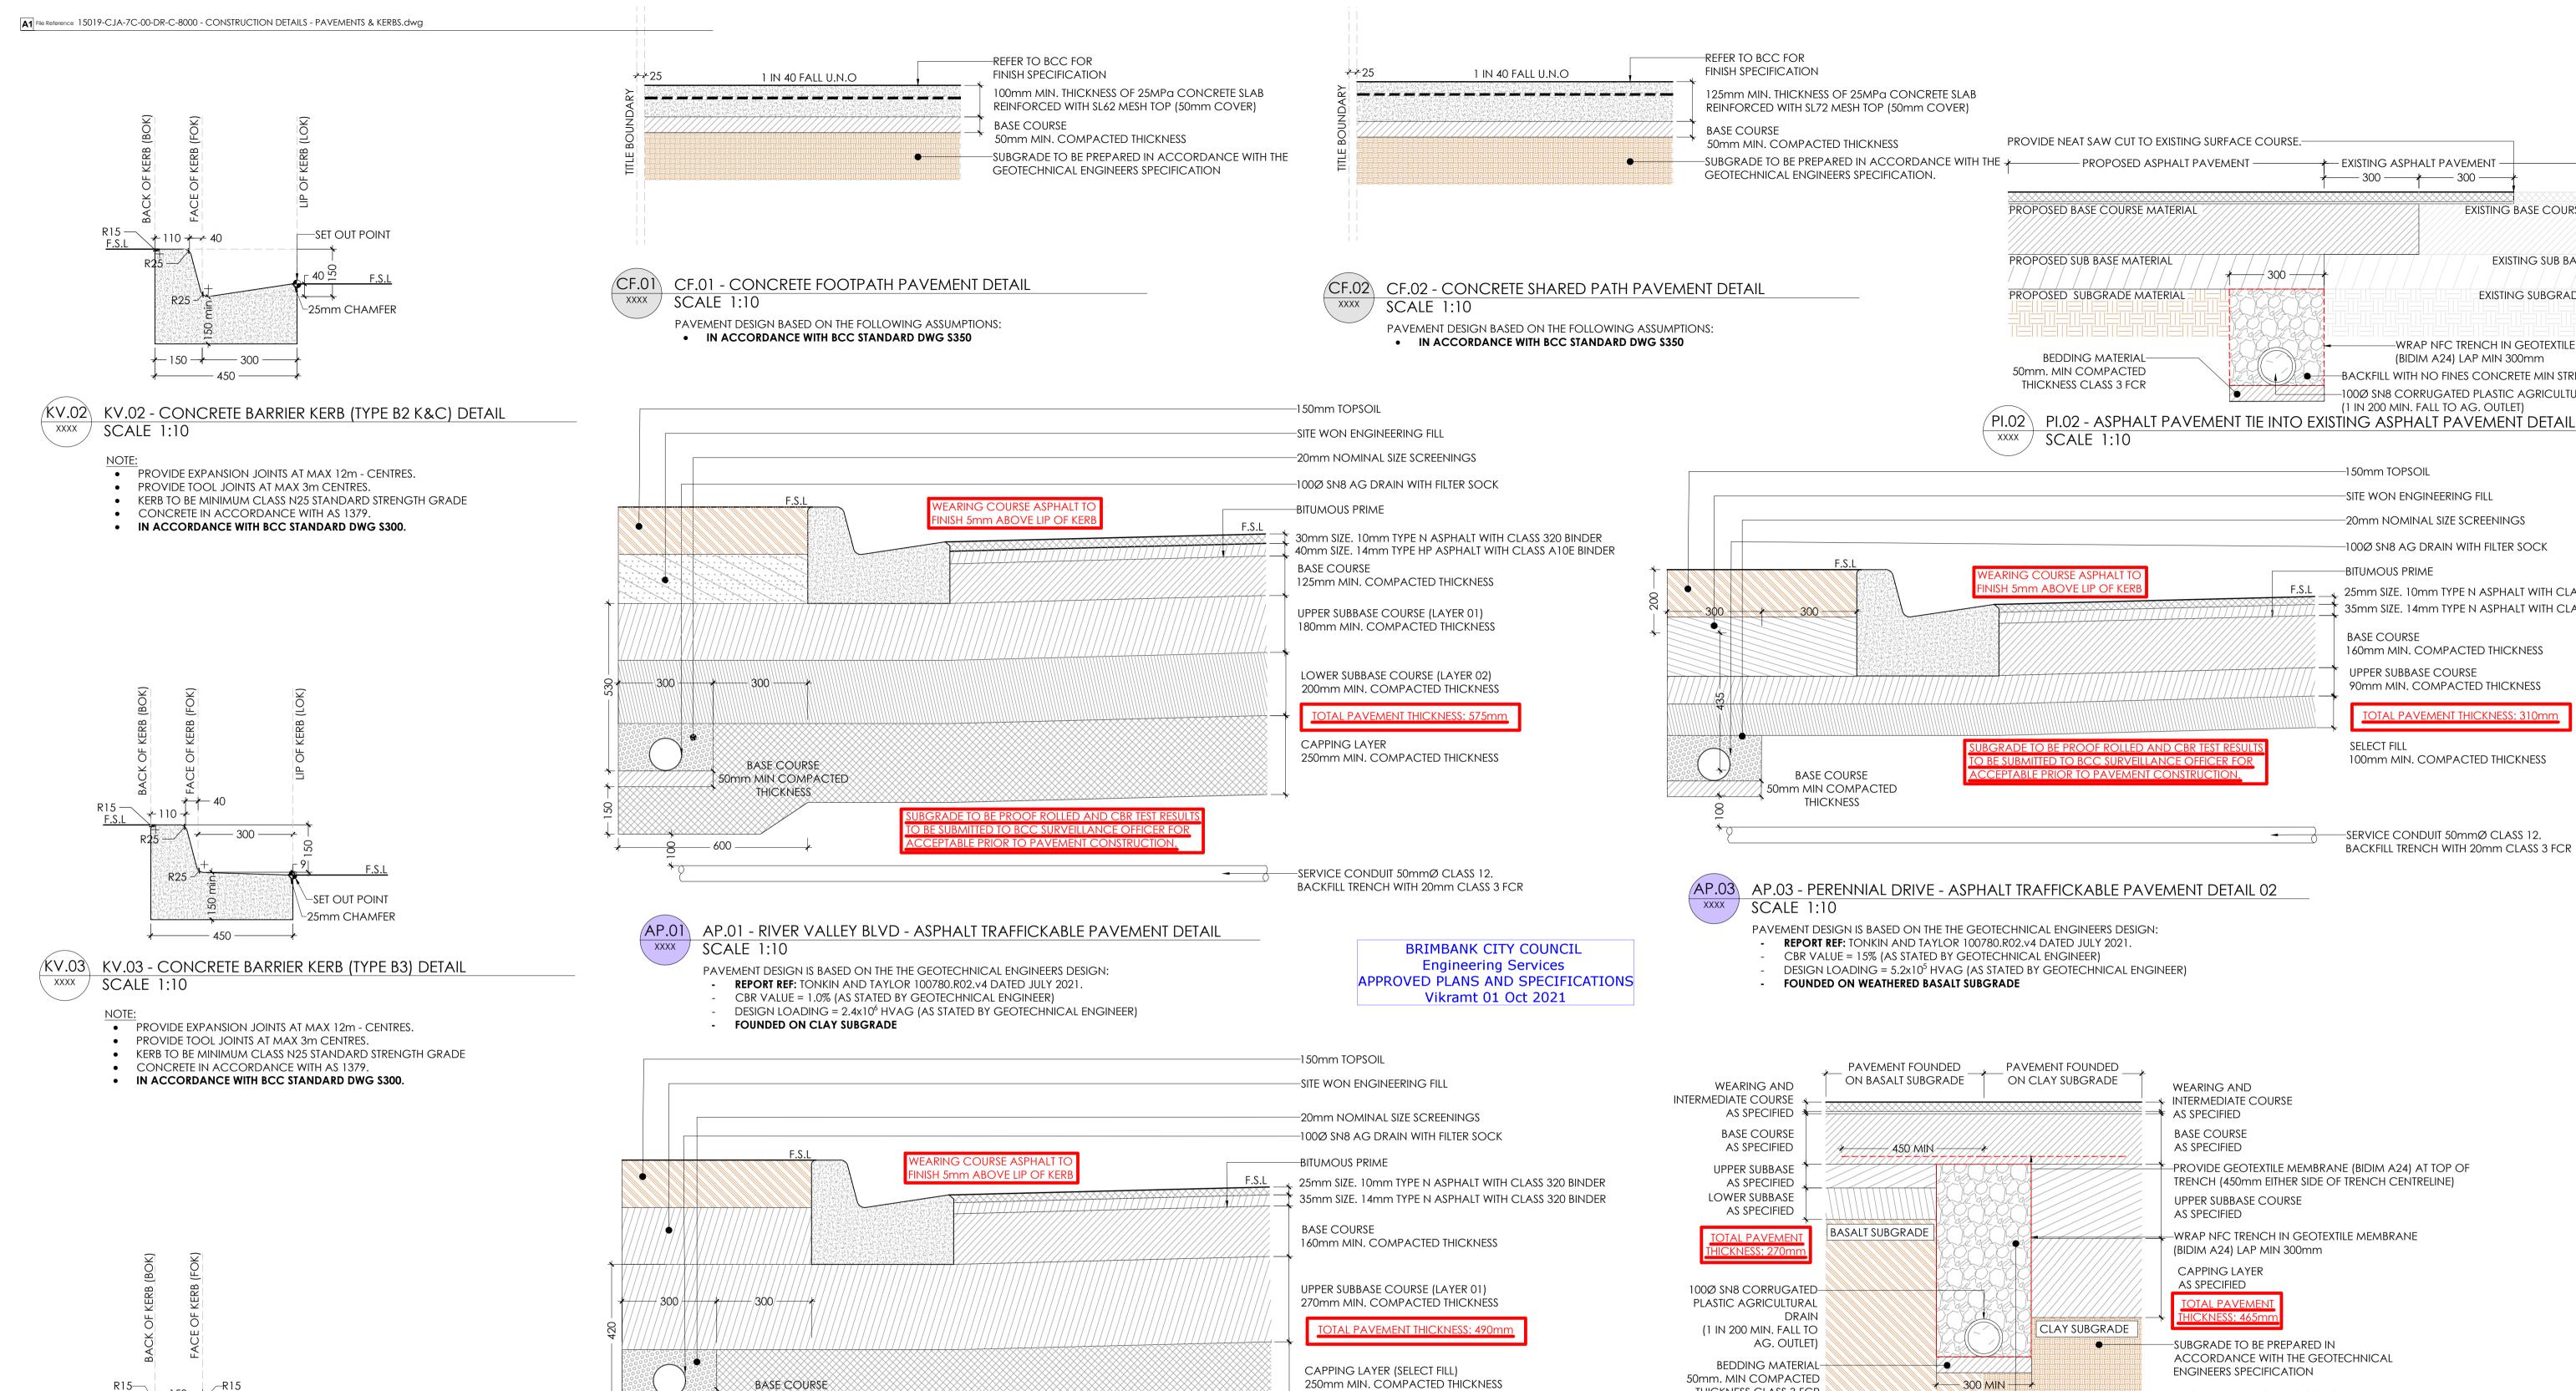
- DESIGN LOADING =  $5.2 \times 10^5$  HVAG (AS STATED BY GEOTECHNICAL ENGINEER)

- REPORT REF: TONKIN AND TAYLOR 100780.R02.v4 DATED JULY 2021.

- CBR VALUE = 1% (AS STATED BY GEOTECHNICAL ENGINEER)

**WEARING AND** ★ INTERMEDIATE COURSE \* AS SPECIFIED BASE COURSE **AS SPECIFIED** -PROVIDE GEOTEXTILE MEMBRANE (BIDIM A24) AT TOP OF TRENCH (450mm EITHER SIDE OF TRENCH CENTRELINE) **UPPER SUBBASE COURSE** AS SPECIFIED -WRAP NFC TRENCH IN GEOTEXTILE MEMBRANE (BIDIM A24) LAP MIN 300mm CAPPING LAYER AS SPECIFIED TOTAL PAVEMEN HCKNESS: 465m -SUBGRADE TO BE PREPARED IN ACCORDANCE WITH THE GEOTECHNICAL **ENGINEERS SPECIFICATION** \* 300 MIN \* THICKNESS CLASS 3 FCR BACKFILL WITH NO FINES CONCRETE MIN STRENGTH 15MPa PI.01 - ASPHALT PAVEMENT TRANSITION DETAIL SCALE 1:10

TABLE.01 - VICTORIA ASPHALT PAVEMENT SPECIFICATION LAYER MATERIAL SPECIFICATION COMPACTION SPECIFICATION SIZE 20mm CLASS 2 CRUSHED ROCK COMPLYING WITH VICROADS COMPACTED TO ACHIEVE A MINIMUM 98% (MODIFIED) IN **BASE COURSE** SPECIFICATION SECTION 812. ACCORDANCE WITH AS1289.5.2.1. SIZE 20mm CLASS 3 CRUSHED ROCK COMPLYING WITH VICROADS COMPACTED TO ACHIEVE A MINIMUM 98% (MODIFIED) IN **UPPER & LOWER SUBBASE COURSE** SPECIFICATION SECTION 812. ACCORDANCE WITH AS1289.5.2.1. SIZE 40mm CLASS 4 CRUSHED ROCK COMPLYING WITH VICROADS COMPACTED TO ACHIEVE A MINIMUM 98% (STANDARD) IN SELECT FILL SPECIFICATION SECTION 812. ACCORDANCE WITH AS1289.5.1.1. 250mm SELECT FILL OR STABILISED CLAY MEETING THE FOLLOWING COMPACTED TO ACHIEVE A MINIMUM 98% (STANDARD) IN MATERIAL PROPERTIES: CBR >7%, SWELL <1.5%, PERMEABILITY K < 5x10<sup>-9</sup>m/s CAPPING LAYER ACCORDANCE WITH AS1289.5.1.1. (5x10<sup>-7</sup> cm/s)

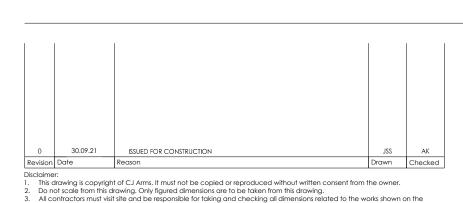

SCALE 1:10

-SET OUT POINT

/KV.04\ KV.04 - CONCRETE EDGING KERB (TYPE ES) DETAIL

PROVIDE EXPANSION JOINTS AT MAX 12m - CENTRES.

IN ACCORDANCE WITH BCC STANDARD DWG \$300.

KERB TO BE MINIMUM CLASS N25 STANDARD STRENGTH GRADE

PROVIDE TOOL JOINTS AT MAX 3m CENTRES.

CONCRETE IN ACCORDANCE WITH AS 1379.

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50mm MIN COMPACTED

THICKNESS

- FOUNDED ON CLAY SUBGRADE

**SCALE 1:10** 

This drawing should not be issued in part and must be read in conjunction with all appropriate specifications, notes pages, details and authority drawings as appropriate.

Dial before you dig. BEWARE OF UNDERGROUND SERVICES. The location of underground services are approximate only and their exact position should be proven on site. No guarantee is given that existing services are shown.

T&T GEOTECHNICAL ENGINEER TO BE NOTIFIED FOR INSPECTION AND ADVICE ON PAVEMENT WHEN BASALT ROCK LAYER OR OULDER IS ENCOUNTERED AT THE SUBGRADE

-SERVICE CONDUIT 50mmØ CLASS 12.

BACKFILL TRENCH WITH 20mm CLASS 3 FCR

NOTE: PAVEMENT DESIGN IN ACCORDANCE WITH TONKIN & TAYLOR GEOTECHNICAL REPORT #100780.R02.v4 (JULY 2021)







CONSTRUCTION DETAILS

AS SHOWN @ A1

8000

PAVEMENT AND KERBS

★ EXISTING ASPHALT PAVEMENT

<del>\* / /</del> 300 <del>/ </del>

—— 300 <del>→</del> 300 —

EXISTING BASE COURSE MATERIAL

EXISTING SUB BASE MATERIAL

EXISTING SUBGRADE MATERIAL

-WRAP NFC TRENCH IN GEOTEXTILE MEMBRANE

(BIDIM A24) LAP MIN 300mm

(1 IN 200 MIN. FALL TO AG. OUTLET)

-SITE WON ENGINEERING FILL

–20mm NOMINAL SIZE SCREENINGS

-100Ø SN8 AG DRAIN WITH FILTER SOCK

160mm MIN. COMPACTED THICKNESS

90mm MIN. COMPACTED THICKNESS

100mm MIN. COMPACTED THICKNESS

BACKFILL TRENCH WITH 20mm CLASS 3 FCR

UPPER SUBBASE COURSE

SERVICE CONDUIT 50mm@ CLASS 12.

–1*5*0mm TOPSOIL

-BITUMOUS PRIME

BASE COURSE


—BACKFILL WITH NO FINES CONCRETE MIN STRENGTH 15MPc

-100Ø SN8 CORRUGATED PLASTIC AGRICULTURAL DRAIN

25mm SIZE. 10mm TYPE N ASPHALT WITH CLASS 320 BINDER 35mm SIZE. 14mm TYPE N ASPHALT WITH CLASS 320 BINDER

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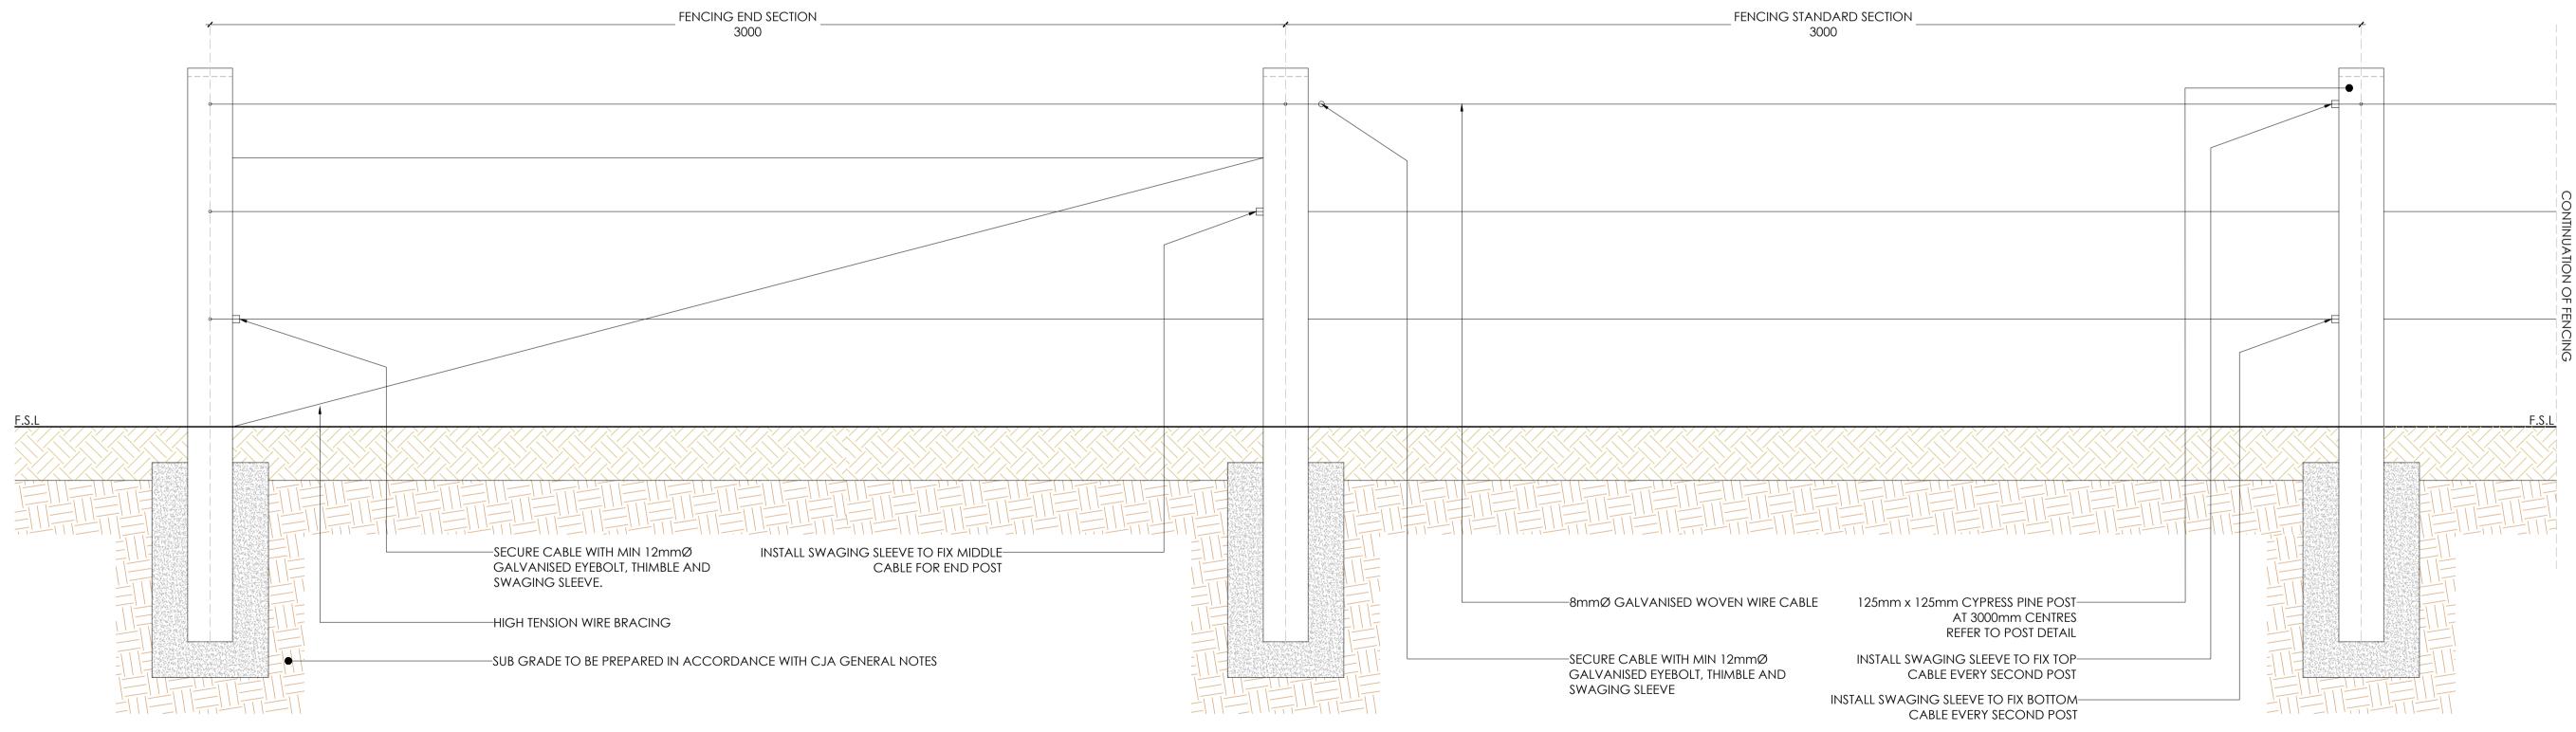
FE.01a FE.01a - VEHICLE EXCLUSION (POST & WIRE) FENCE POST DETAIL SCALE 1:10

FINISHED SPECIFICATION:

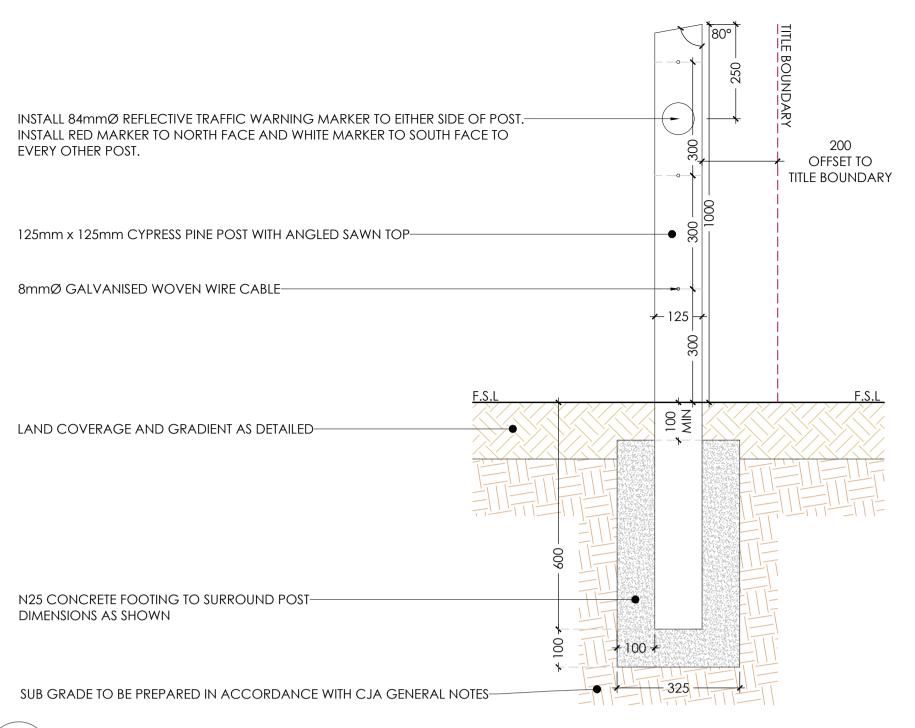TIBER STAIN FINISH TO BE CABOT'S 'TIMBER SHADES' EBONY N.

CONTRACTOR NOTES:

PRIOR TO STAINING, CONTRACTOR TO PROVIDE 3mm CHAMFER TO ALL POSTS.



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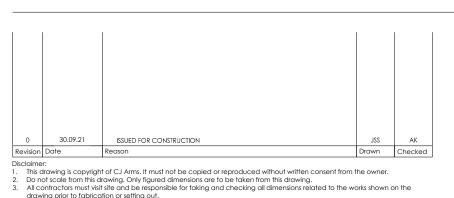
FE.01b - VEHICLE EXCLUSION (POST & WIRE) FENCE POST DETAIL SCALE 1:10

FINISHED SPECIFICATION:

TIBER STAIN FINISH TO BE CABOT'S 'TIMBER SHADES' EBONY N.

CONTRACTOR NOTES:

PRIOR TO STAINING, CONTRACTOR TO PROVIDE 3mm CHAMFER TO ALL POSTS.



Note for Contractors

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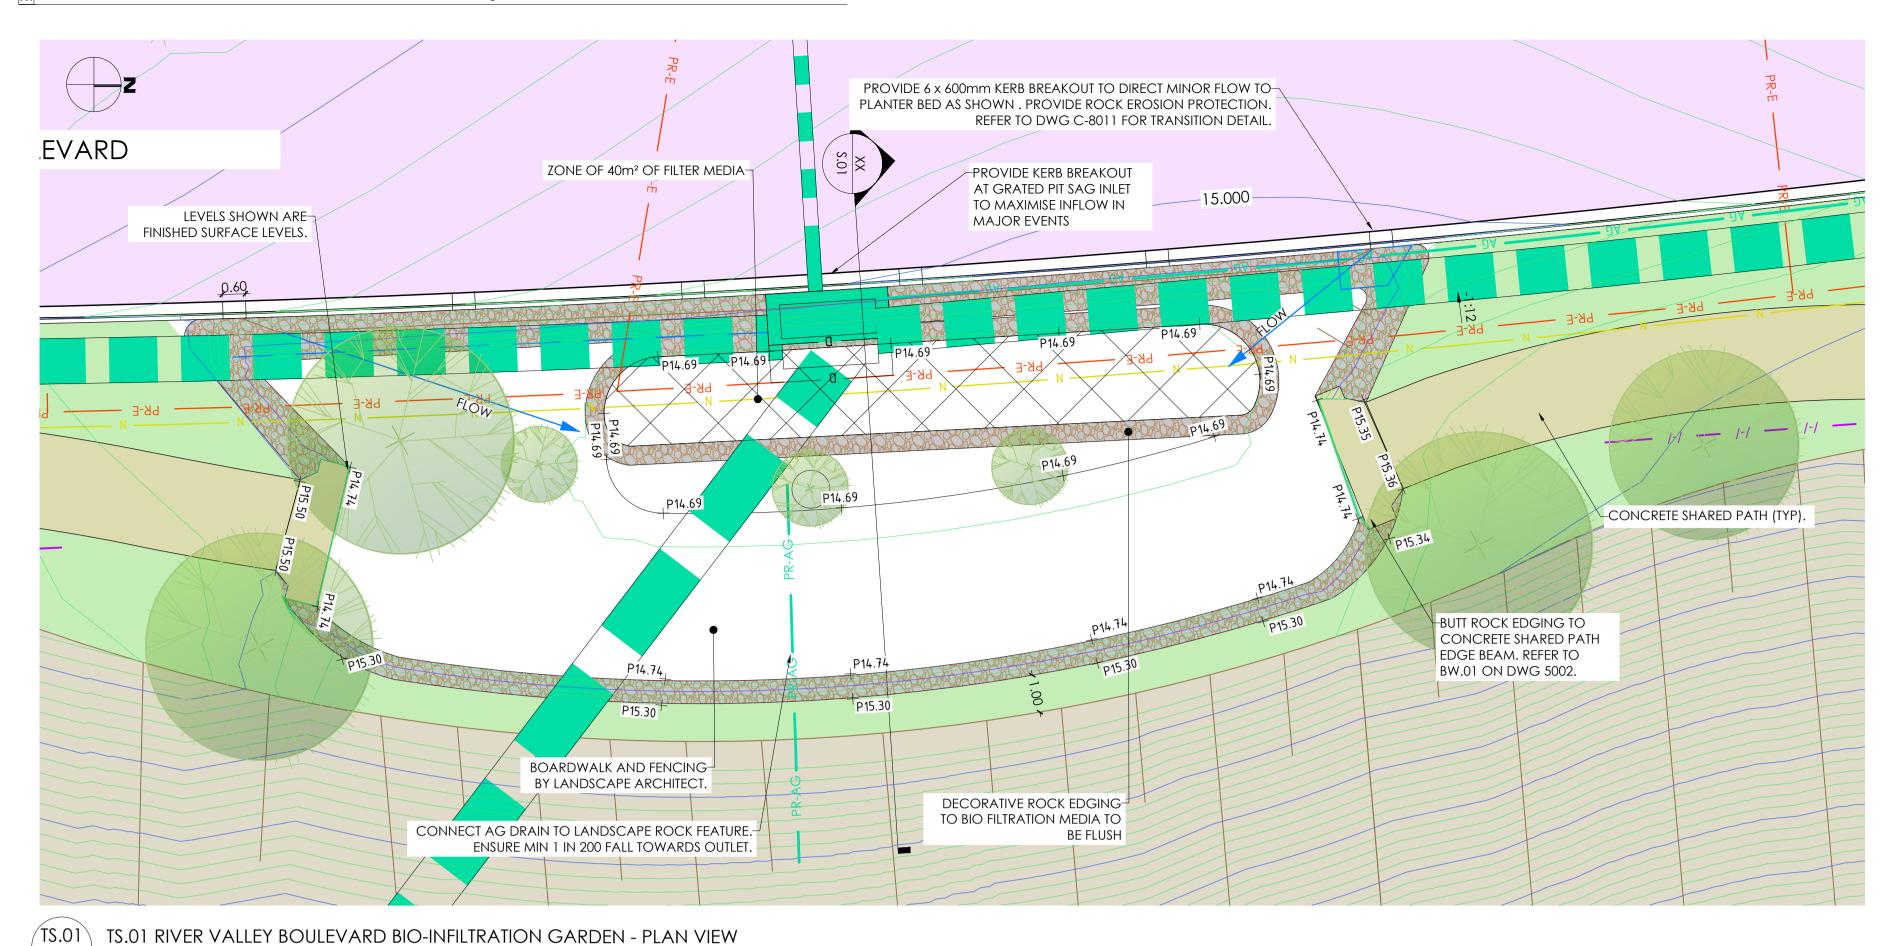
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AS SHOWN @ A1 31.03.21

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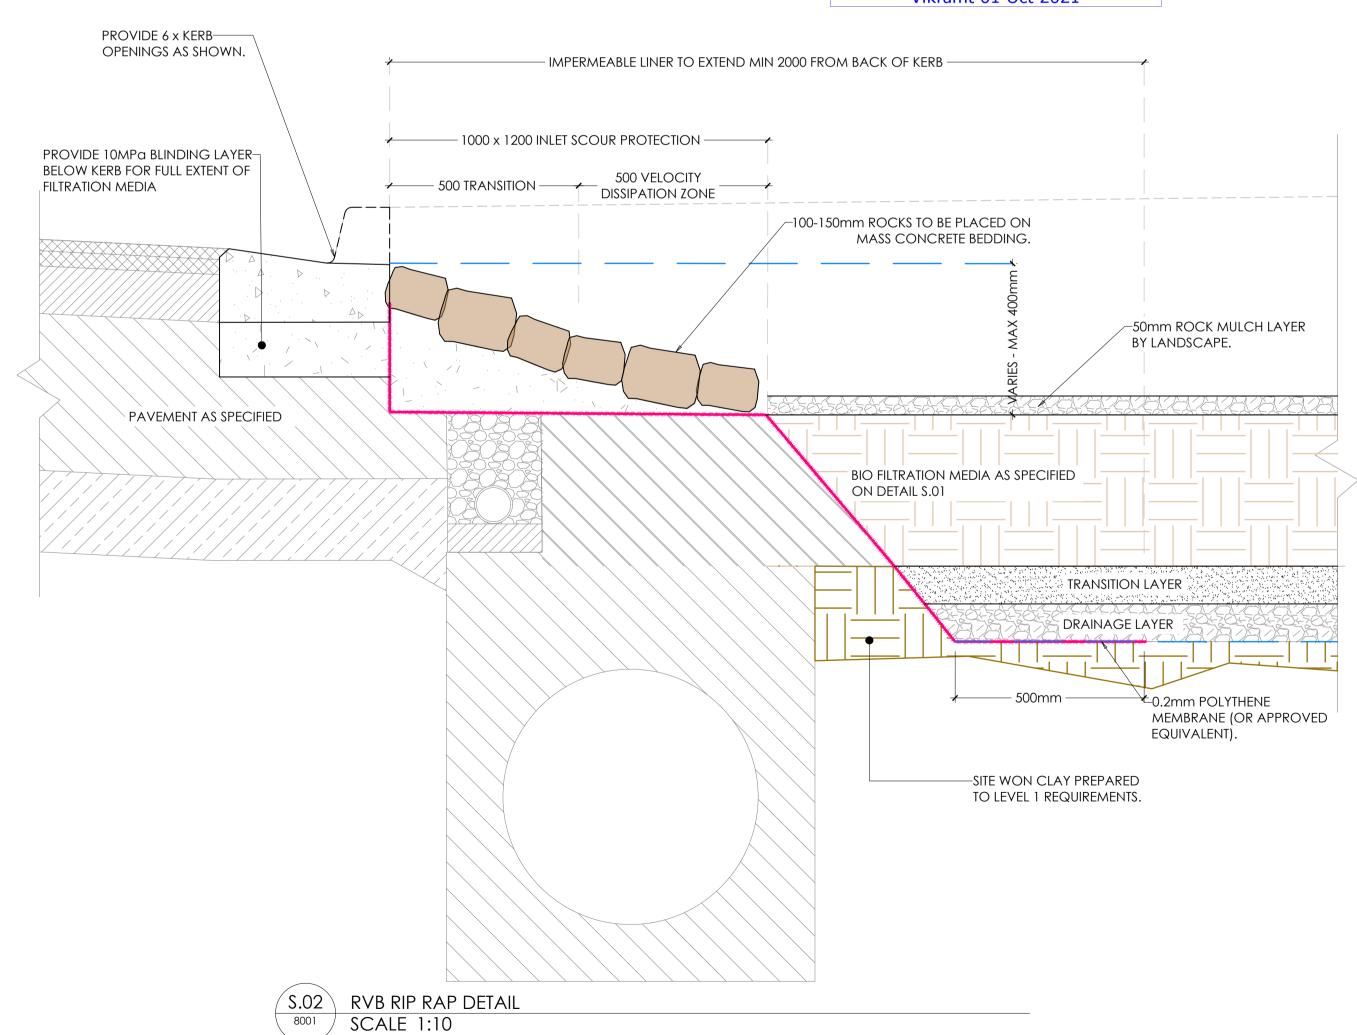


BOARDWALK CONCRETE (BY LANDSCAPE ARCH) SHARED FOOTPATH <del>∤</del> 300 − CONCRETE SHARED FOOTPATH AS SPECIFIED BASE COURSE AS SPECIFIED -SUB GRADE TO BE PREPARED IN ACCORDANCE WITH CJA GENERAL NOTES -25MPA CONCRETE EDGE BEAM -REINFORCEMENT TO BE L11TM4 TRENCH MESH AT BOTTOM (50mm COVER) WITH CROSS WIRES AT 300mm CENTRES AND LONGITUDINAL WIRES AT 100mm CENTRES. <del>/</del>--150 -- <del>/</del>

> (BW.01) BW.01 - BOARDWALK TIE IN DETAIL SCALE 1:10

> > **BRIMBANK CITY COUNCIL Engineering Services** APPROVED PLANS AND SPECIFICATIONS Vikramt 01 Oct 2021

#### SCALE 1:100 ROAD RESERVE -BIO-INFILTRATION GARDEN BED 1V:3.1H LANDSCAPE BATTER BERM ★ TRAFFIC LANE (WIDTH VARIES) 1.00 (WIDTH VARIES) \_ STORMWATER \_\_\_\_\_\_\_ BIO-FILTRATION \_ RAISED BOARDWALK (WIDTH VARIES - MIN 3100) REFER TO LANDSCAPE PACKAGE SPLAY (VARIES) -→ → 0.15 OFFSET TO RAIL Nom 150mm EXTENDED DETENTION DEPTH \* \* 0.32 CLEARANCE 14<u>.</u>84 -CONTRACTOR TO PROVIDE 200mm TOPSOIL + 50mm ROCK MULCH. -SITE WON TOPSOIL TO LANDSCAPE BATTER. REFER TO LANDSCAPE SPECIFICATION FOR PROVIDE 10mPa BLINDING LAYER— -CONTRACTOR TO SHAPE CLAY SUBGRADE REQUIREMENTS. BELOW KERB FOR FULL EXTENT TOWARDS TREE AT LOW POINT. OF RAINGARDEN -300-500Ø SITE WON BASALT BOULDERS PROVIDE 90mmØ SOCKED AG-PLACED TO EDGE OF GARDEN BED. ELECTRIC SERVICES TO BE LOCALLY DRAIN CONNECTING TREE PIT FILTER PLACE ON COMPACTED SUBGRADE & DIVERTED AROUND STORMWATER MEDIA TO LANDSCAPE ROCK PLACE IN AN INTERLOCKING MANNER. FEATURE. MAX 800mm HIGH. LOCALLY OFFSET AG ALONG-RIVER VALLEY BLVD 200mm TO -REFER TO DETAIL S.02 ON DWG C-6200 FOR DETAILS OF SAG PIT. ALLOW CONNECTION INTO PIT RIVER VALLEY BOULEVARD BIO-INFILTRATION GARDEN - SECTION VIEW 8001 SCALE 1:50 • FILTER MEDIA - 400mm DEPTH COMPRISING A SANDY LOAM CONTAINING 10% LEAF COMPOST & 10% MULCH BY VOLUME, ACHIEVING A SATURATED HYDRAULIC CONDUCTIVITY









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# • REFER TO LANDSCAPE PLANS FOR PLANTING SPECIFICATION. 30.09.21 ISSUED FOR CONSTRUCTION ate Reason \_\_\_\_\_

Note for Contractors

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• 1.0mm HDPE IMPERMEABLE LINER IS TO BE APPLIED TO THE CARRIAGEWAY SIDE. REFER TO SECTION S.02 FOR EXTENT.

• SUBSOIL DRAINAGE IS TO DISCHARGE TO THE PROPOSED OUTFALL ROCK CREEK BED. REFER TO LANDSCAPE PLANS.

• TRANSITION LAYER - 100mm SAND LAYER WITH <2% FINES & 90% PARTICLE SIZE ABOVE 0.25mm (E.G VIC ROADS WASHED A3 FILTER SAND)

• PROVIDE SACRIFICIAL LAYER OF BIDIM A24 TO SURFACE OF MEDIA, PRIOR TO LANDSCAPING, TO PROTECT MEDIA FROM CLOGGING. PLANTING TO OCCUR ONCE CATCHMENT IS

OF 180mm/hr, TN CONTENT OF <1200mg/kg & <92mg/kg OF ORTHOPHOSPHATE CONTENT.


• DRAINAGE LAYER - 100mm CLEAN WASHED 5mm GRAVEL LAYER.

90% STABILISED


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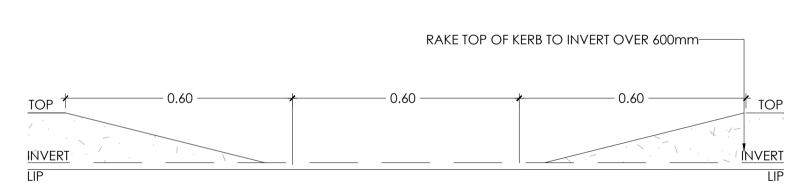
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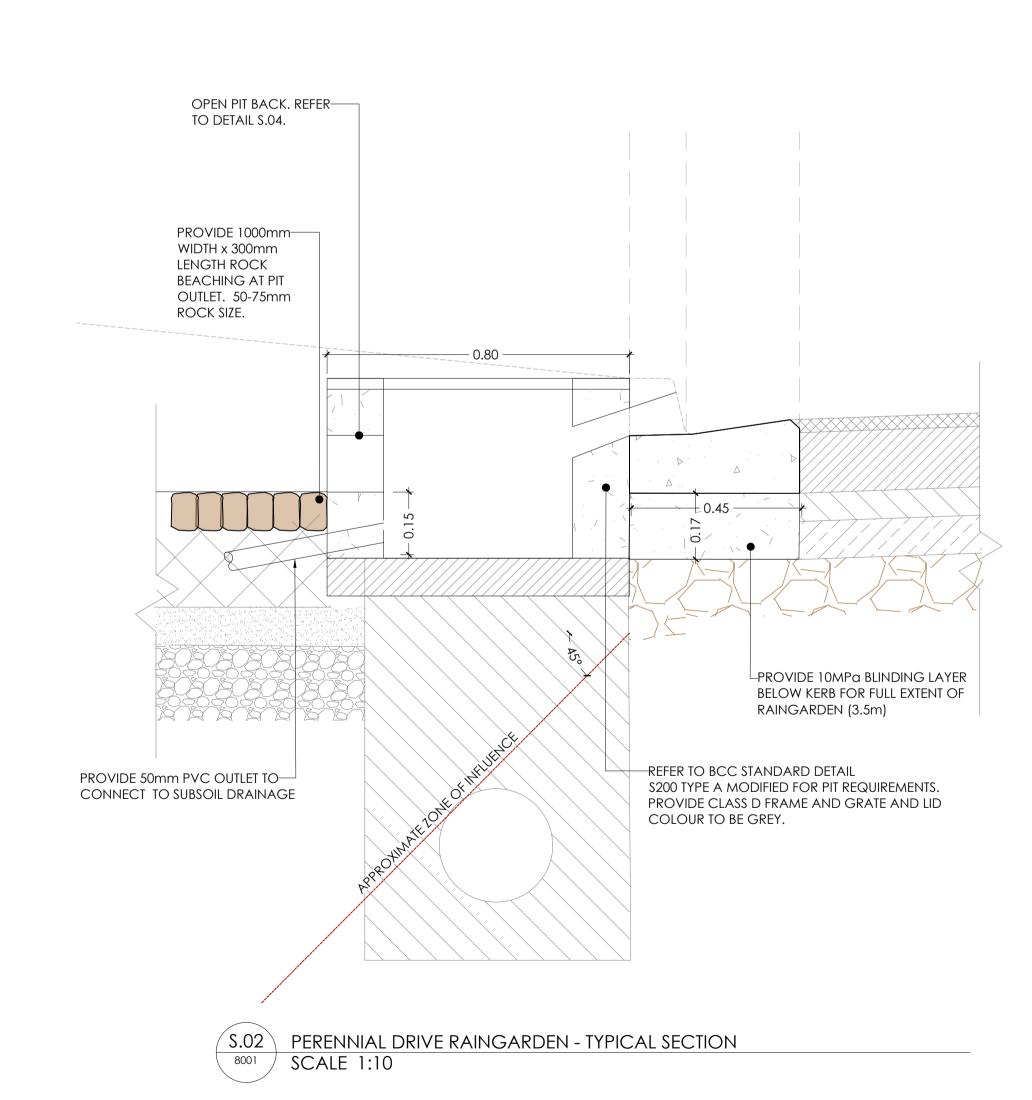
PERENNIAL DRIVE RAINGARDEN - TYPICAL PLAN VIEW

S.04 \ PIT BACK OPEN 8001 SCALE 1:10

SCALE 1:50

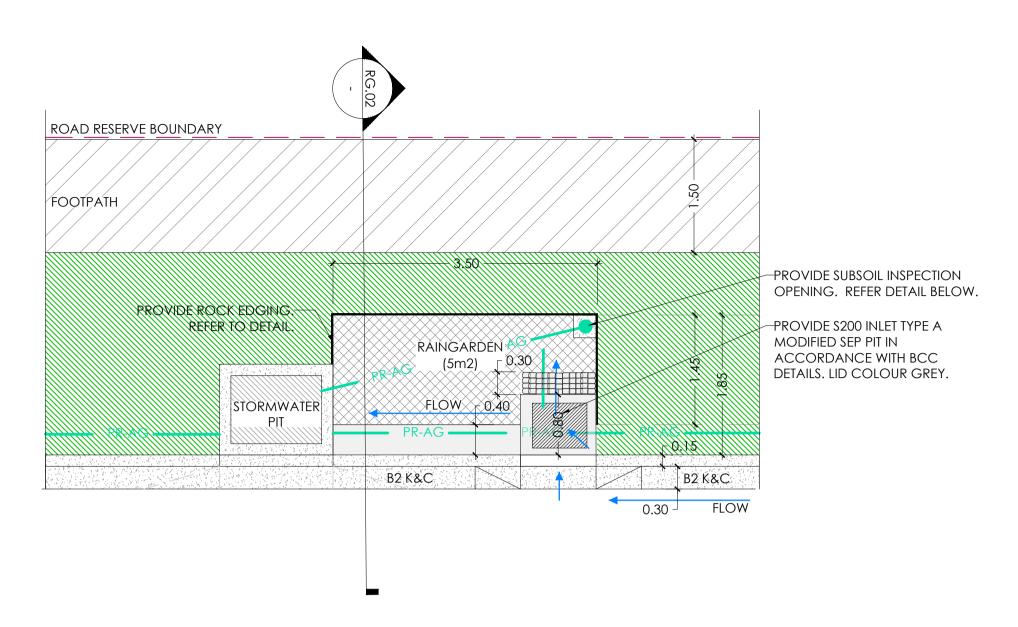



KERB TRANSITION DETAIL SCALE 1:10

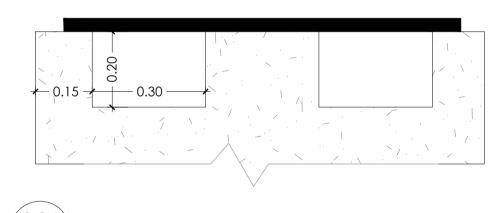

1.50 TRAFFIC LANE FOOTPATH VERGE/RAIN GARDEN **←** 0.40 **←** PLACE MIN 300mmØ - MAX— 500Ømm BASALT BOULDER AT TOP OF WEATHERED BASALT CUT PROFILE. PLACE ON 5:1 SAND TO CEMENT RATIO MORTAR BED. ALLOW FOR EXCAVATION FOR-BOULDER AND MORTAR BED. -50mm ROCK MULCH REFER TO DETAIL S.02 TO BE PROVIDED BY FOR DIMENSIONS. FOOTPATH AS— LANDSCAPE ARCH. SPECIFIED ADJACENT VERGE LEVELS -PAVEMENT AS **SPECIFIED** • • FILTRATION MEDIA LAYER PROVIDE 1.0mm HDPE LINER TO SAND TRANSITION LAYER INTERFACE WITH ROAD GRAVEL DRAINAGE LAYER PAVEMENT/STORWATER TRENCH -STORMWATER DRAINAGE 90mmØ SOCKED AG DRAIN LAID AT MIN 0.5%-(MIN 1100 COVER) LONGITUDINAL GRADE, CONNECTION TO DOWNSTREAM SIDE ENTRY PIT. PROVIDE INSPECTION OPENING AT UPSTREAM END. -WEATHERED **BASALT LAYER** (RG.02) RAINGARDEN - TYPICAL SECTION (IN ROCK) SCALE 1:25 • FILTER LAYER - 400mm DEPTH OF FILTER MEDIA WITH MAX 5% ORGANIC CONTENT, ACHIEVING A SATURATED HYDRAULIC CONDUCTIVITY OF 200mm/hr, TN CONTENT OF <730mg/kg & <54mg/kg OF ORTHOPHOSPHATE CONTENT. • TRANSITION LAYER - 100mm SAND LAYER WITH <2% FINES & 90% PARTICLE SIZE ABOVE 0.25mm (E.G VIC ROADS WASHED A3 FILTER SAND) DRAINAGE LAYER - 150mm CLEAN WASHED 5mm GRAVEL LAYER. • 1.0mm HDPE IMPERMEABLE LINER IS TO BE APPLIED TO THE CARRIAGEWAY SIDE. REFER TO DETAIL. SUBSOIL DRAINAGE IS TO DISCHARGE TO THE PROPOSED OUTFALL ROCK CREEK BED. REFER TO LANDSCAPE PLANS. BASE OF TRENCH SHALL BE GRADED TO THE SOCKED AG DRAIN AT MIN 0.5% GRADE THE SUBSOIL DRAINAGE IS TO DISCHARGE TO THE PROPOSED PIT & PIPE NETWORK.

- PROVIDE SACRIFICIAL LAYER OF BIDIM A24 TO SURFACE OF MEDIA, PRIOR TO LANDSCAPING, TO PROTECT MEDIA FROM CLOGGING.
- PLANTING TO OCCUR ONCE CATCHMENT IS 90% STABILISED
- REFER TO LANDSCAPE PLANS FOR PLANTING SPECIFICATION.

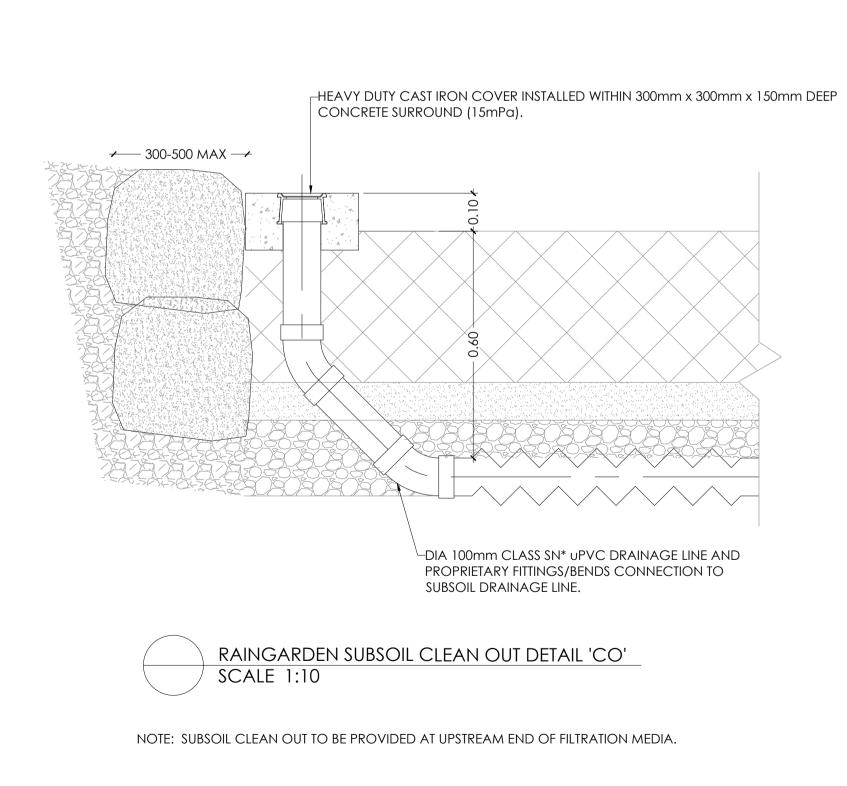

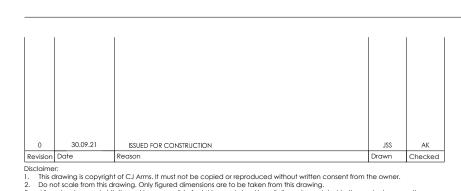

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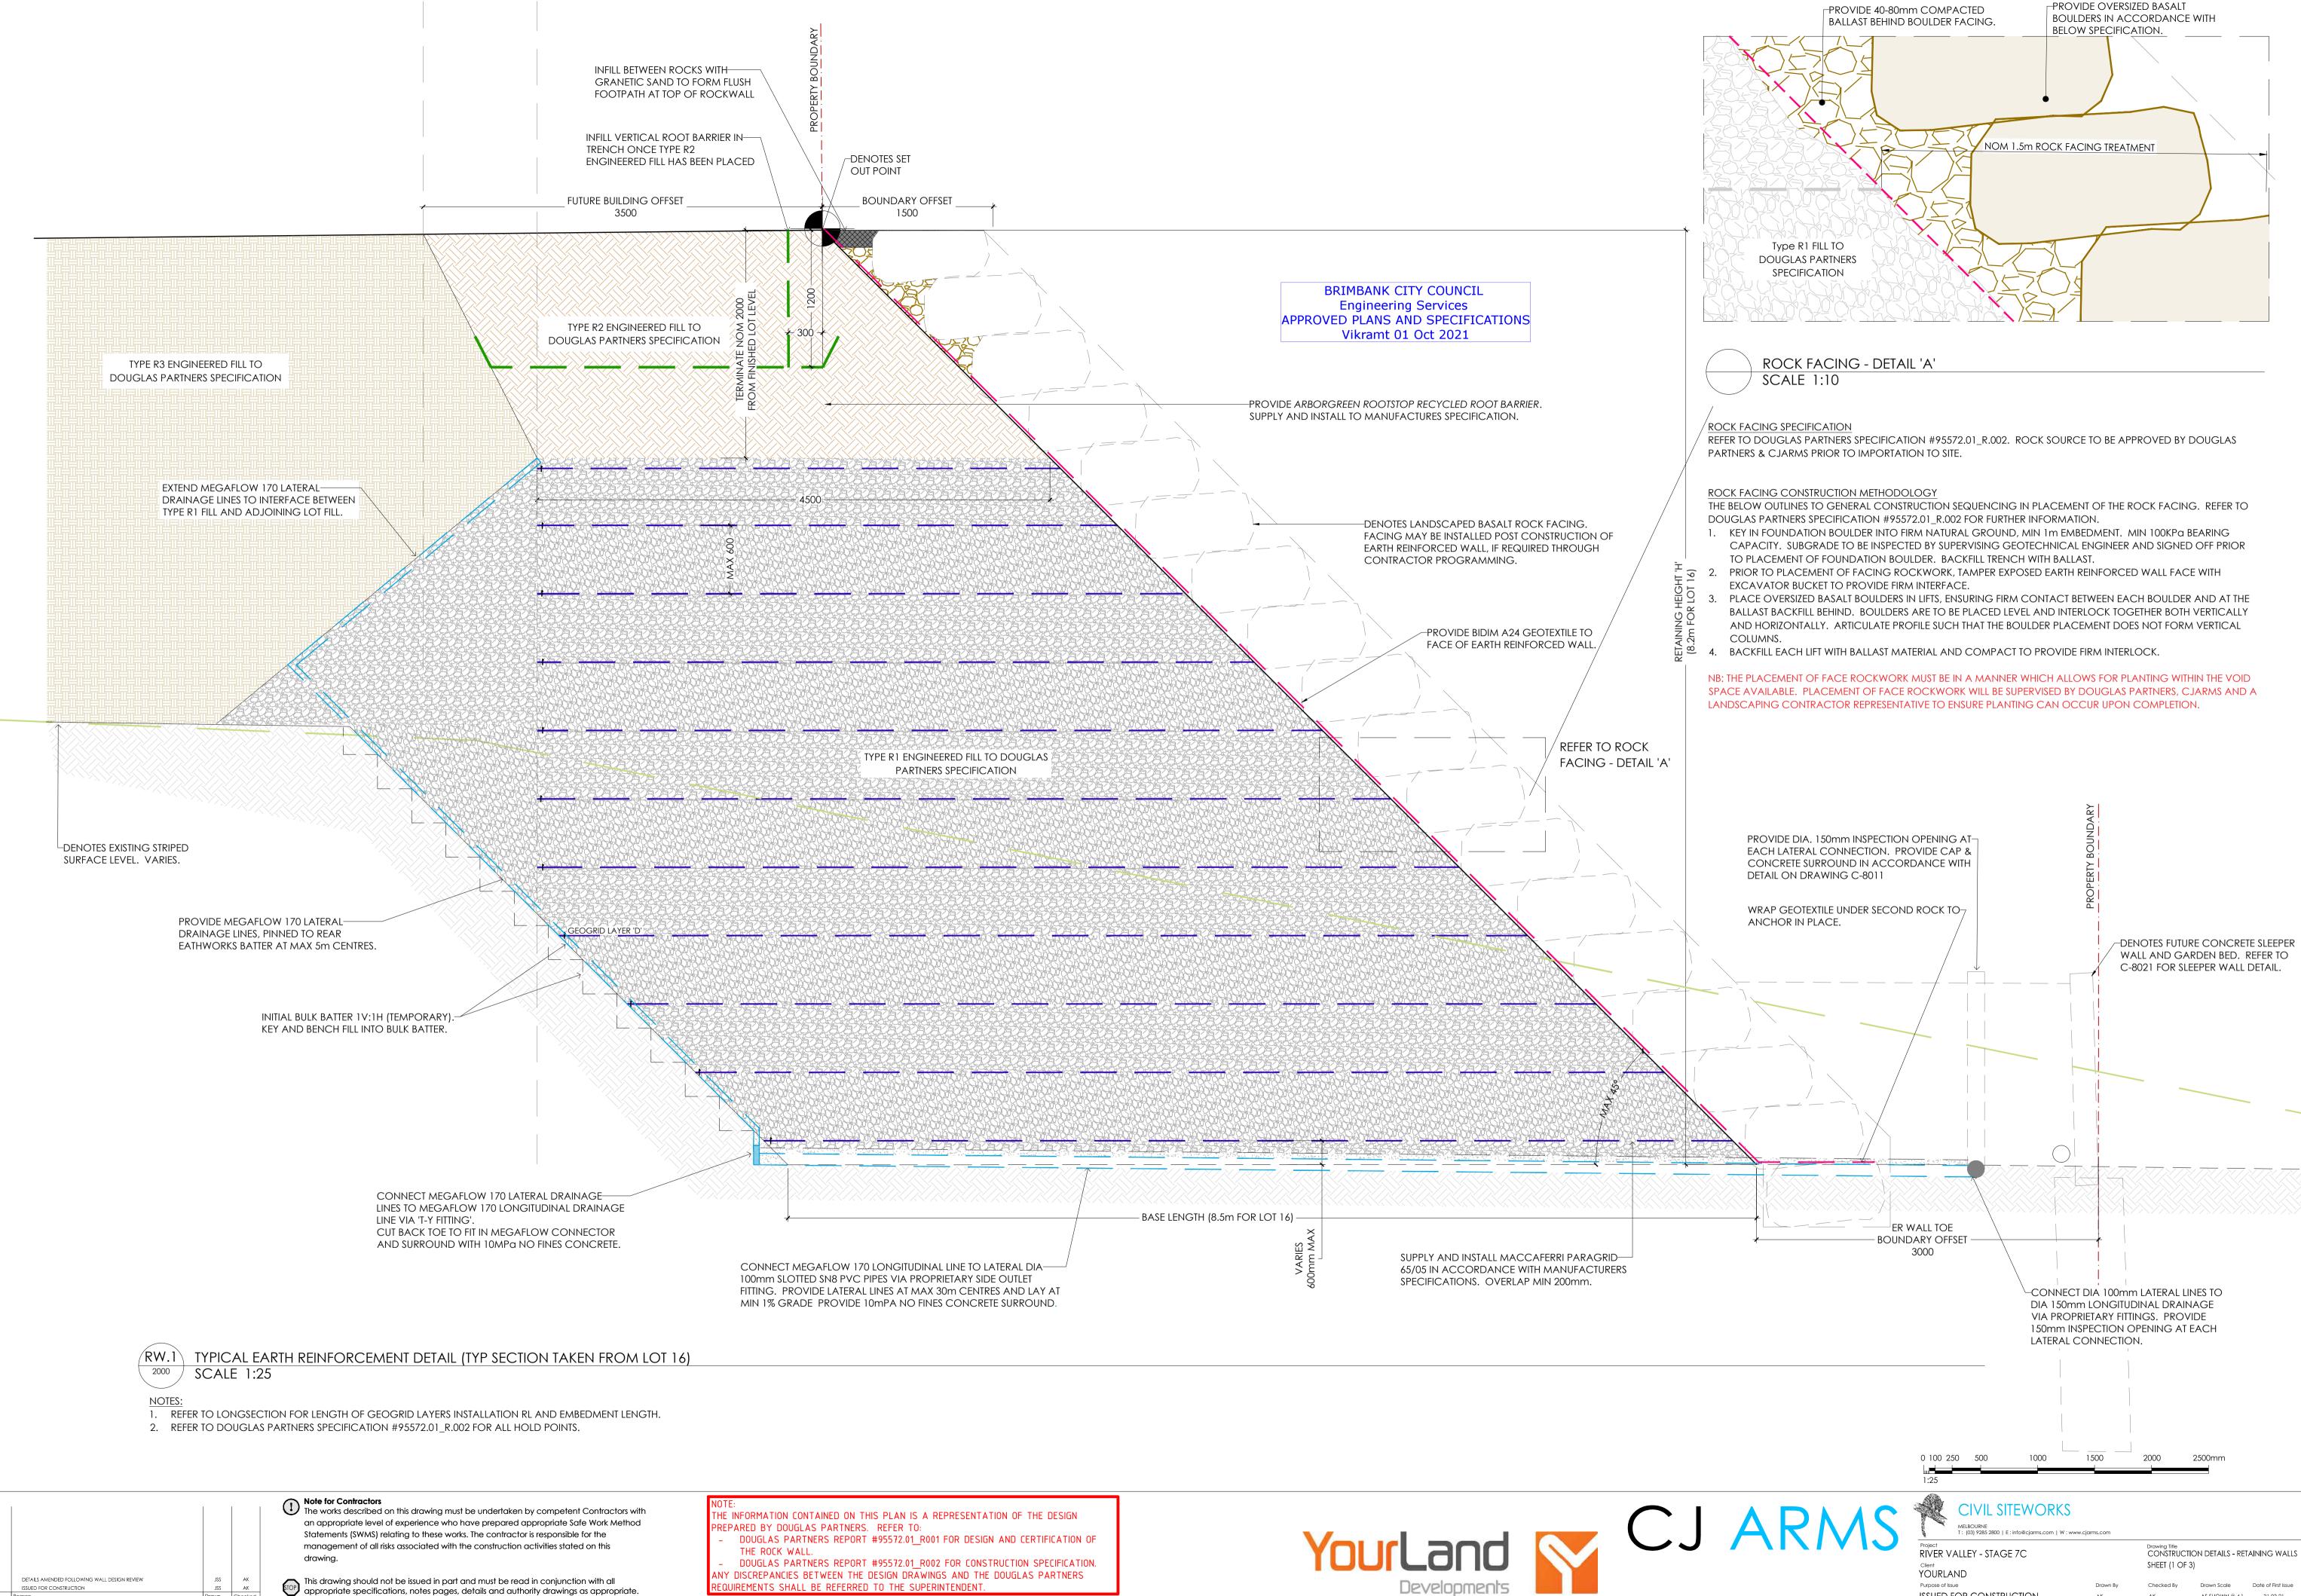




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DETAILS AMENDED FOLLOWING WALL DESIGN REVIEW 03.09.2021 ISSUED FOR CONSTRUCTION
ate Reason

This drawing should not be issued in part and must be read in conjunction with all appropriate specifications, notes pages, details and authority drawings as appropriate.

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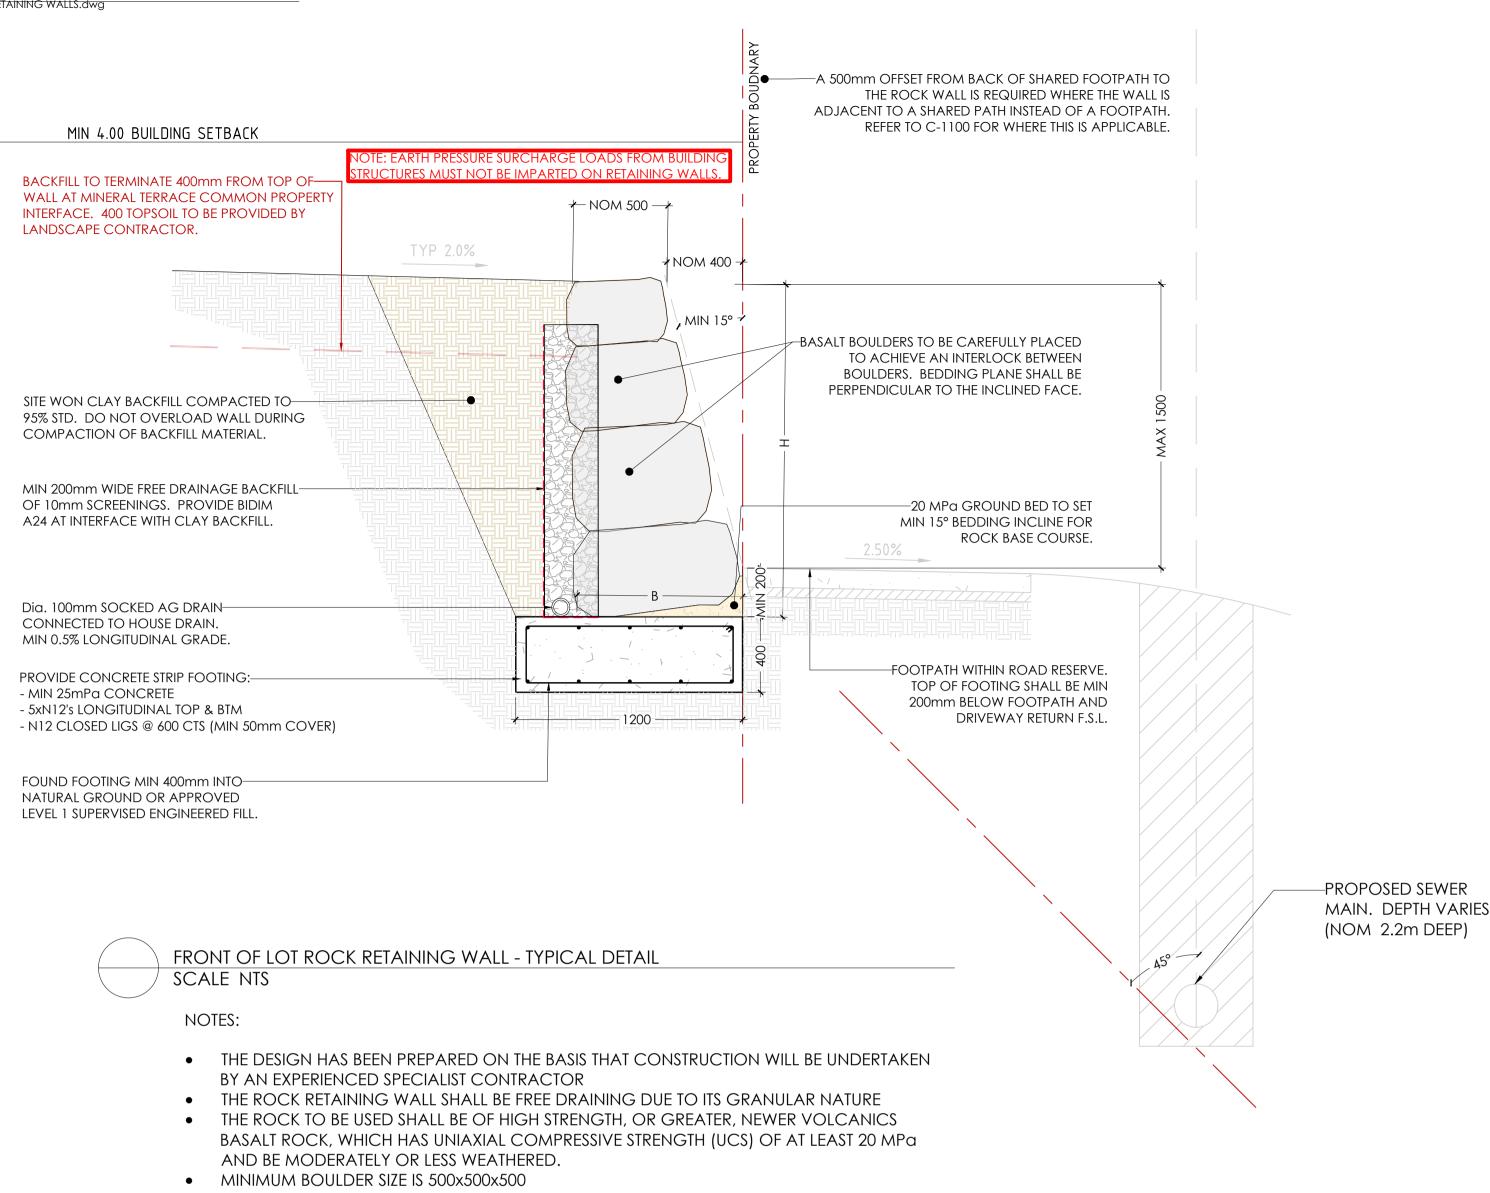
ANY DISCREPANCIES BETWEEN THE DESIGN DRAWINGS AND THE DOUGLAS PARTNERS REQUIREMENTS SHALL BE REFERRED TO THE SUPERINTENDENT.

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Drawn Scale ISSUED FOR CONSTRUCTION AS SHOWN @ A1 31.03.21 8020 15019 CJA 7C XX DR





- BOULDERS, AND THEIR BED JOINTS, ARE TO BE ANGLED BACK INTO THE FACE AND PLACED TO INTERLOCK TOGETHER BOTH HORIZONTALLY AND VERTICALLY (i.e STRETCHER BOND)
- BOULDERS SHALL BE PLACED OFFSET SO AS TO AVOID FORMING VERTICAL COLUMNS (i.e. STRETCHER BOND)
- BALLAST SHOULD BE PLACED IN THE BOULDER RETAINING WALL TO FILL VOIDS AS REQUIRED BALLAST SHALL BE MODERATELY WEATHERED OR LESS WEATHERED BASALT OR STRONGER
- APPROVED ALTERNATIVE ROCK TYPE
- ALL WORKS SHALL BE CARRIED OUT IN ACCORDANCE WITH THE CONSTRUCTION DRAWINGS AND SPECIFICATION
- WHERE COMPACTION OF THE BACKFILL EXCEEDS THE ABOVE DESIGN LOADS, CONTRACTOR SHALL ALLOW FOR TEMPORARY PROPPING OF THE FACE OF THE WALL.

TABLE.01 - ROCKWORK - RETAINING WALL SCHEDULE - 5kPa SURCHARGE								
RETAINED HEIGHT (H) SLANT OF FACE TOP ROCK WIDTH BASE ROCK WIDTH (B)								
0mm - 1700mm         15 DEGREES         500mm (MIN)         0.6 x WALL HEIGHT (H)								

#### ASSUMPTIONS:

- ROCK DENSITY MIN 2700kg/m³ WITH MAX 15% VOID RATIO.
- SITE WON BACKFILL Ka = 0.45, SOIL UNIT WEIGHT 20kN/m³.
- RETAINING WALL TO BE FOUNDED ON SUBGRADE COMPACTED TO ACHIEVE MIN 98%
- STANDARD AND ACHIEVE MIN 100KPa BEARING CAPACITY.
- ASSUMED SURCHARGE LOADING OF 5KPa ON WALL.

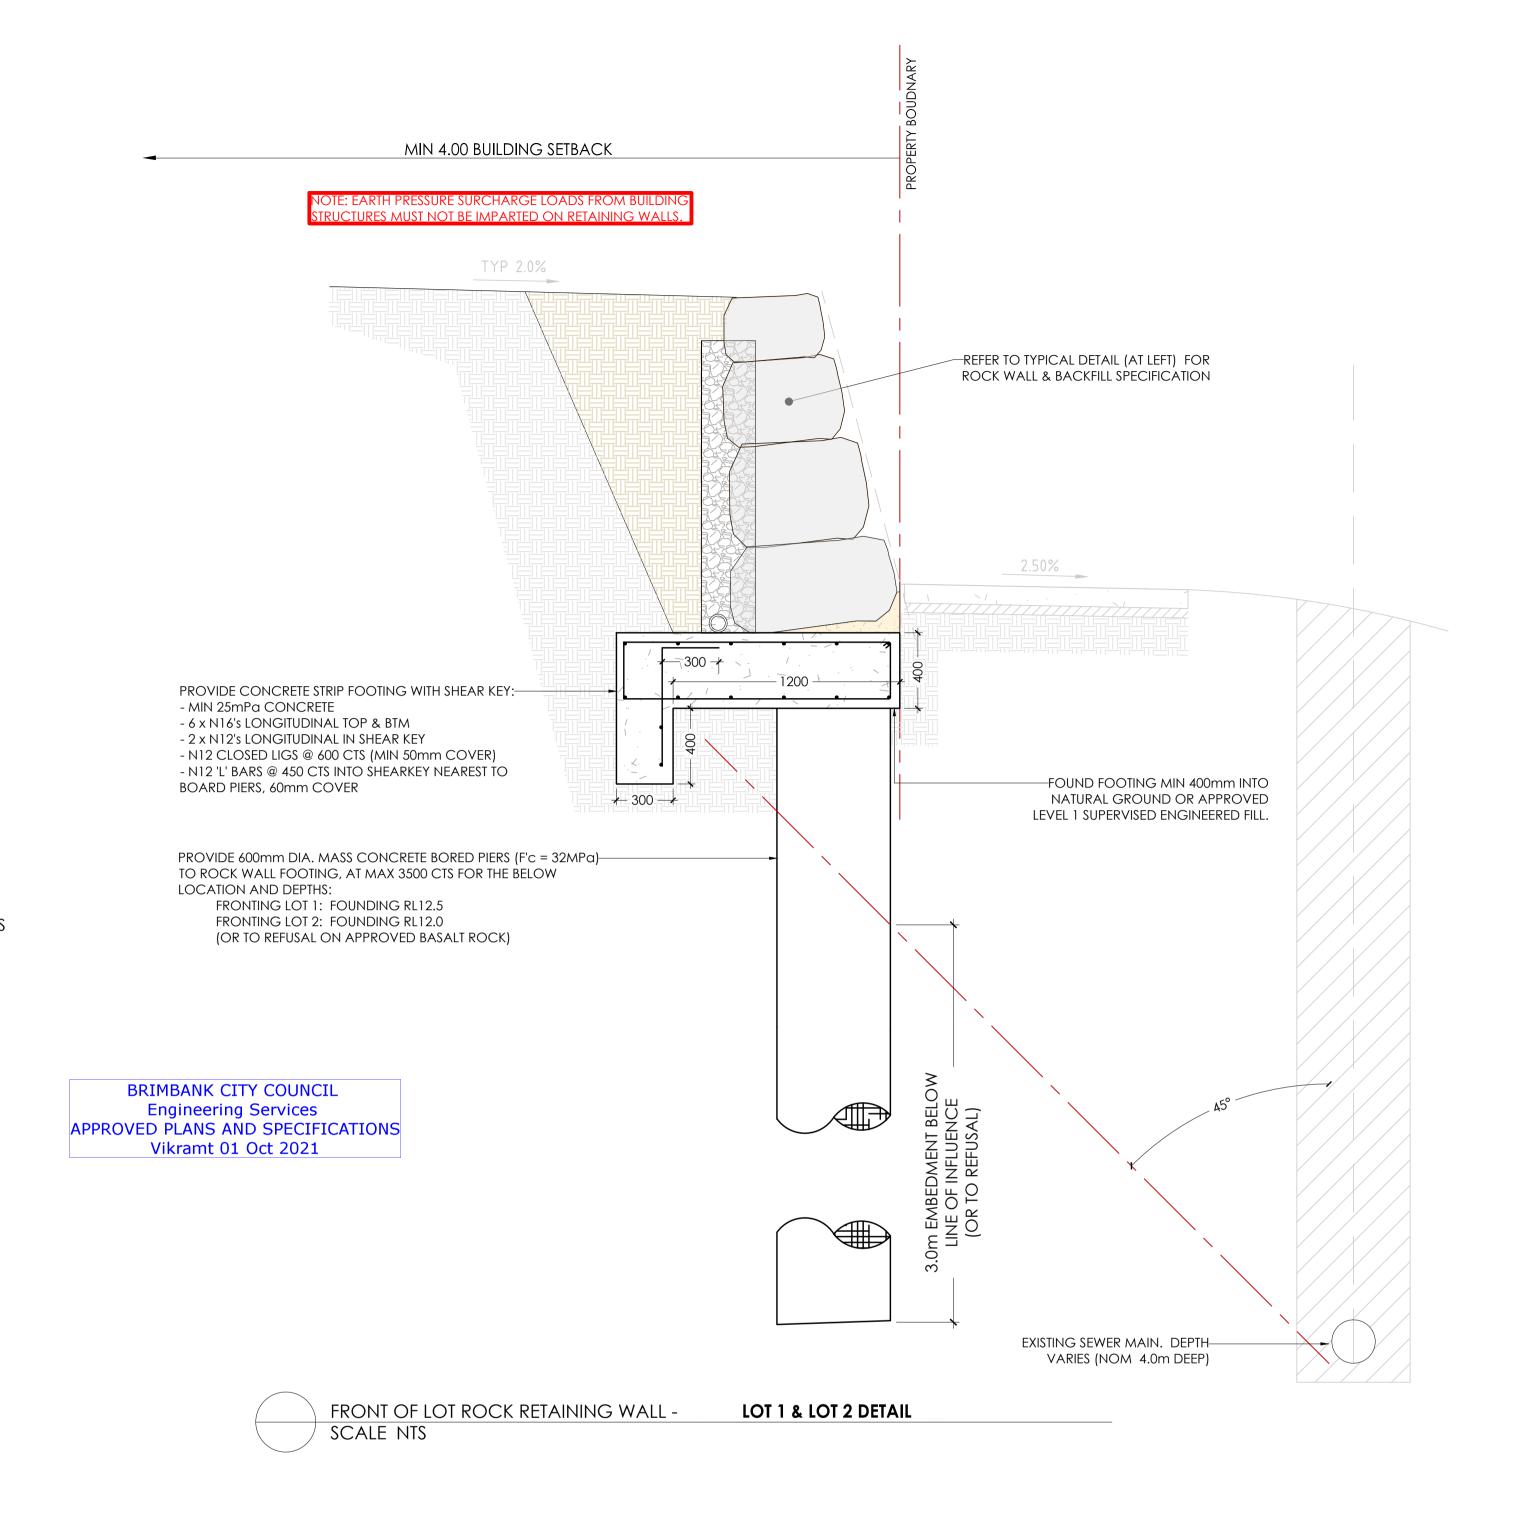

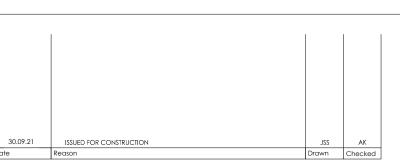


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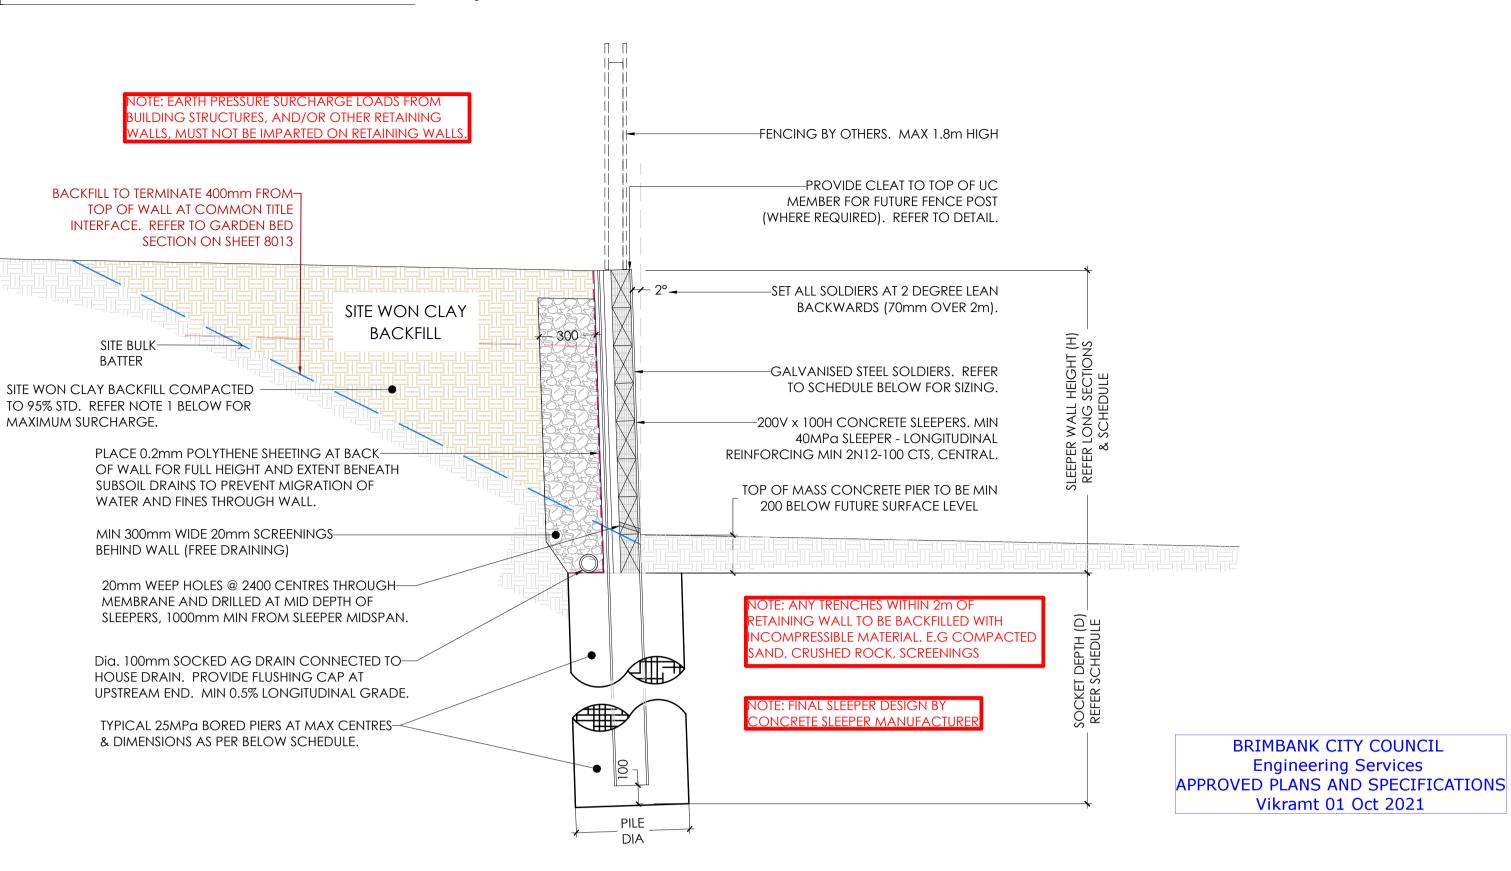
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RW.03 RW.03a - PRE-CAST SLEEPER RETAINING WALL - FOOTING TYPE 1 SCALE NTS

- DESIGN LOADS ARE:
- 1.1. 5KPa WHERE RETAINING LOTS/LANDSCAPING RESERVES
- 1.2. 10KPa WHERE RETAINING ROADS
- WHERE COMPACTION EQUIPMENT LOADS EXCEEDS THE ABOVE DESIGN LOADS, ALLOW TO TEMPORARILY PROP THE FACE OF THE WALL. 2. SOCKET DEPTH IS DEPTH INTO APPROVED NATURAL GROUND OR APPROVED SUPERVISED ENGINEERED FILL. TABULATED SOCKET DEPTHS ARE
- BASED ON THE GROUND ON THE HIGH SIDE OF THE WALL BEING HORIZONTAL. SHOULD THERE BE AN INCLINE BEHIND THE TOP OF WALL OF UP TO 1V:4H MAX: ADOPT THE DESIGN FOR HEIGHT (H) = 1.2 x ACTUAL WALL HEIGHT. WHERE THE SOCKET DEPTH EXTENDS INTO APPROVED BASALT ROCK, SOCKET DEPTH SHALL BE THE LESSER OF THE DEPTH NOTED IN THE BELOW
- SCHEDULE AND MIN 1.2m INTO THE APPROVED HIGH STRENGTH BASALT PROFILE.
- BORE HOLES FOR PIERS SHALL BE CLEAN OF LOOSE SOIL AND DEBRIS. DO NOT BORE HOLES WHEN RAIN IS EXPECTED.
- 5. ALL SLEEPERS ARE TO BE SLEEPER DIRECT RUSTIC WOODGRAIN SLEEPER CHARCOAL

TABLE.01 - PRE CAST SLEEPER WALL SCHEDULE - 5kPa SURCHARGE						
RETAINED HEIGHT	H.D GALV. SOLDERS	max. solder spacing	PIER DIAMETER (PØ)	SOCKET DEPTH (D)		
0mm - 600mm	150 UC 23	2400mm	600mm	1500mm		
601mm - 900mm	150 UC 23	2400mm	600mm	1800mm		
901mm - 1200mm	150 UC 23	2400mm	600mm	2100mm		
1201mm - 1500mm	150 UC 23	2400mm	600mm	2400mm		
1501mm - 1800mm	150 UC 23	2400mm	600mm	2800mm		
1801mm - 2100mm	150 UC 23	1800mm	600mm	2800mm		
2101mm - 2400mm	150 UC 30	1800mm	600mm	3100mm		
2401mm - 2700mm	150 UC 37	1800mm	600mm	3500mm		
2701mm - 3000mm	200 UC 46	1800mm	600mm	3800mm		
3001mm - 3300mm	200 UC 52	1800mm	600mm	4100mm		

TABLE	TABLE.02 - PRE CAST SLEEPER WALL SCHEDULE - 10kPa SURCHARGE							
RETAINED HEIGHT	H.D GALV. SOLDERS	MAX. SOLDER SPACING	PIER DIAMETER (PØ)	SOCKET DEPTH (D)				
0mm - 600mm	150 UC 23	1800mm	600mm	1500mm				
601mm - 900mm	150 UC 23	1800mm	600mm	1800mm				
901mm - 1200mm	150 UC 23	1800mm	600mm	2100mm				
1201mm - 1500mm	150 UC 23	1800mm	600mm	2400mm				
1501mm - 1800mm	150 UC 23	1200mm	600mm	2400mm				
1801mm - 2100mm	150 UC 23	1200mm	600mm	2700mm				
2101mm - 2400mm	150 UC 30	1200mm	600mm	3000mm				
2401mm - 2700mm	150 UC 37	1200mm	600mm	3300mm				
2701mm - 3000mm	200 UC 46	1200mm	600mm	3500mm				
3001mm - 3300mm	200 UC 52	1200mm	600mm	3800mm				


JILDING STRUCTURES, AND/OR OTHER RETAINING ALLS, MUST NOT BE IMPARTED ON RETAINING WAL -FENCING BY OTHERS. MAX 1.8m HIGH **FUTURE BUILDING OFFSET** —PROVIDE CLEAT TO TOP OF UC MEMBER FOR FUTURE FENCE POST (WHERE REQUIRED). REFER TO DETAIL. SITE WON CLAY BACKFILL REFER RW.03a (AT LEFT) FOR SLEEPER WALL. SL82 MESH CONTINUOUS (MIN 50mm COVER) TOP OF CONCRETE FOOTING TO BE MIN 200 BELOW FUTURE 3 x N20 BARS @ 100mm CENTRES AT EVERY POST (MIN-SURFACE LEVEL 50mm COVER). PROVIDE 300mm COG BOTTOM. BARS TO EXTEND FULL WIDTH OF FOOTING. BASE PLATE. → 50mm COVER 250 x 250 SHEAR KEY CAST INTEGRALLY WITH FOOTING ¥ 250 ¥ EARTH REINFORCED WALL BELOW REFER DOUGLAS PARTNERS SPECIFICATION

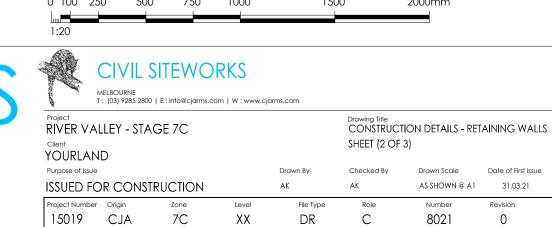RW.03 RW.03b - PRE-CAST SLEEPER RETAINING WALL - FOOTING TYPE 2

# SCALE NTS

#### 1. DESIGN LOADS ARE:


- 1.1. 5KPa WHERE RETAINING LOTS/LANDSCAPING RESERVES
- WHERE COMPACTION EQUIPMENT LOADS EXCEEDS THE ABOVE DESIGN LOAD, ALLOW TO TEMPORARILY PROP THE FACE OF THE WALL.
- 2. WIDTH (W) OF FOOTING TO EQUAL 0.8 x RETAINED HEIGHT (H). MIN WIDTH 600mm.
- MIN COVER TO ALL REINFORCEMENT (50mm).
- 4. SHEAR KEY TO BE CAST INTEGRALLY WITH FOOTING & MESH SHALL BE CAPPED (MIN 300mm).

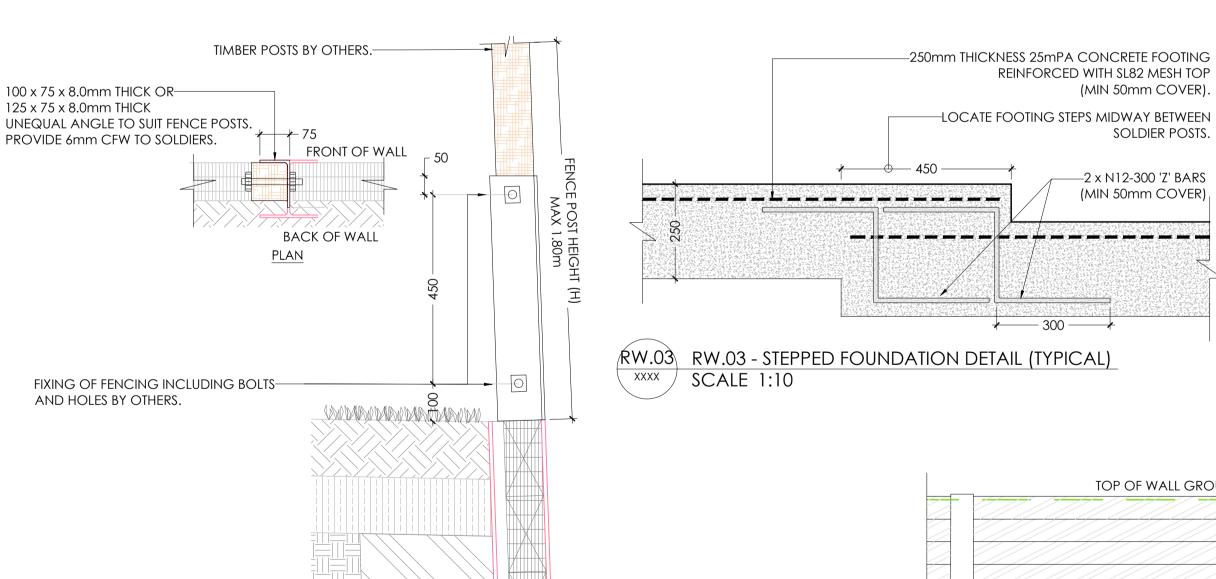

RW.04 RW.04 - PRE-CAST SLEEPER - FENCE CONNECTION DETAIL SCALE 1:10


ISSUED FOR CONSTRUCTION

Vikramt 01 Oct 2021

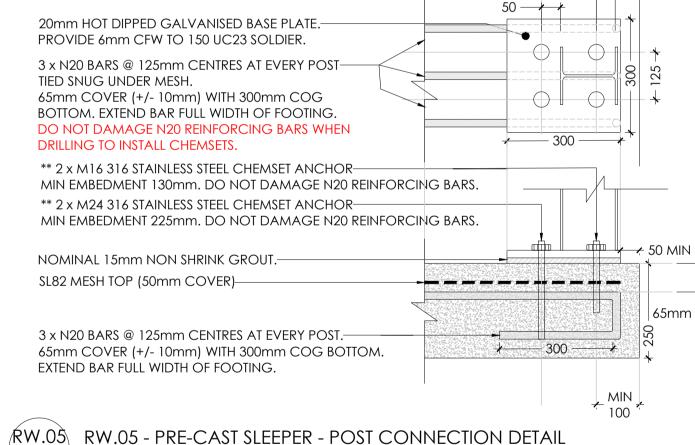


SCALE 1:10

\*\* EQUIVALENT CAST IN 316 S/S ANCHOR BOLTS ARE ACCEPTABLE AS ALTERNATIVE TO CHEMSET ANCHOR.

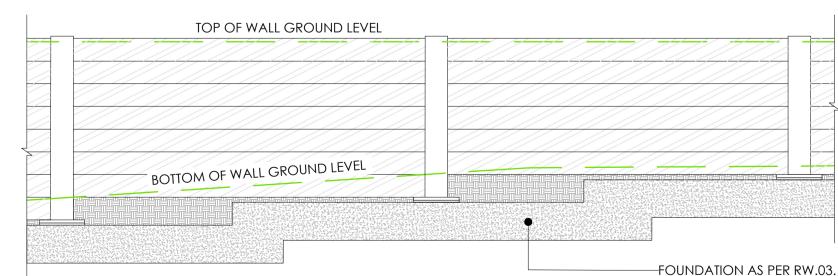

RW.04 RW.04 - STEPPED FOUNDATION - PLAN VIEW SCALE 1:10

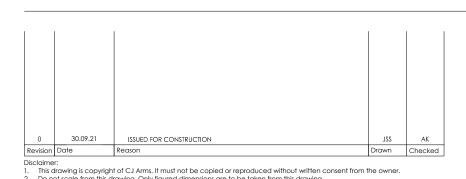

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Dial before you dig. BEWARE OF UNDERGROUND SERVICES. The location of underground services are approximate only and their exact position should be proven on site. No guarantee is given that existing services are shown.

T: (03) 9285 2800 | E:info@ciarms.com | W:www.ciarms.cor CONSTRUCTION DETAILS - RETAINING WALLS RIVER VALLEY - STAGE 7C SHEET (3 OF 3) YOURLAND Drawn Scale

DR

1:20 @ A1


8022


31.03.21

ISSUED FOR CONSTRUCTION


15019 CJA

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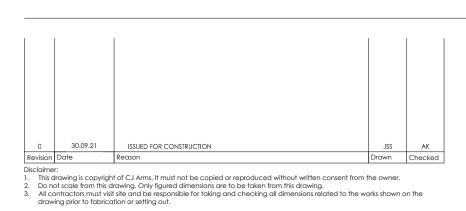


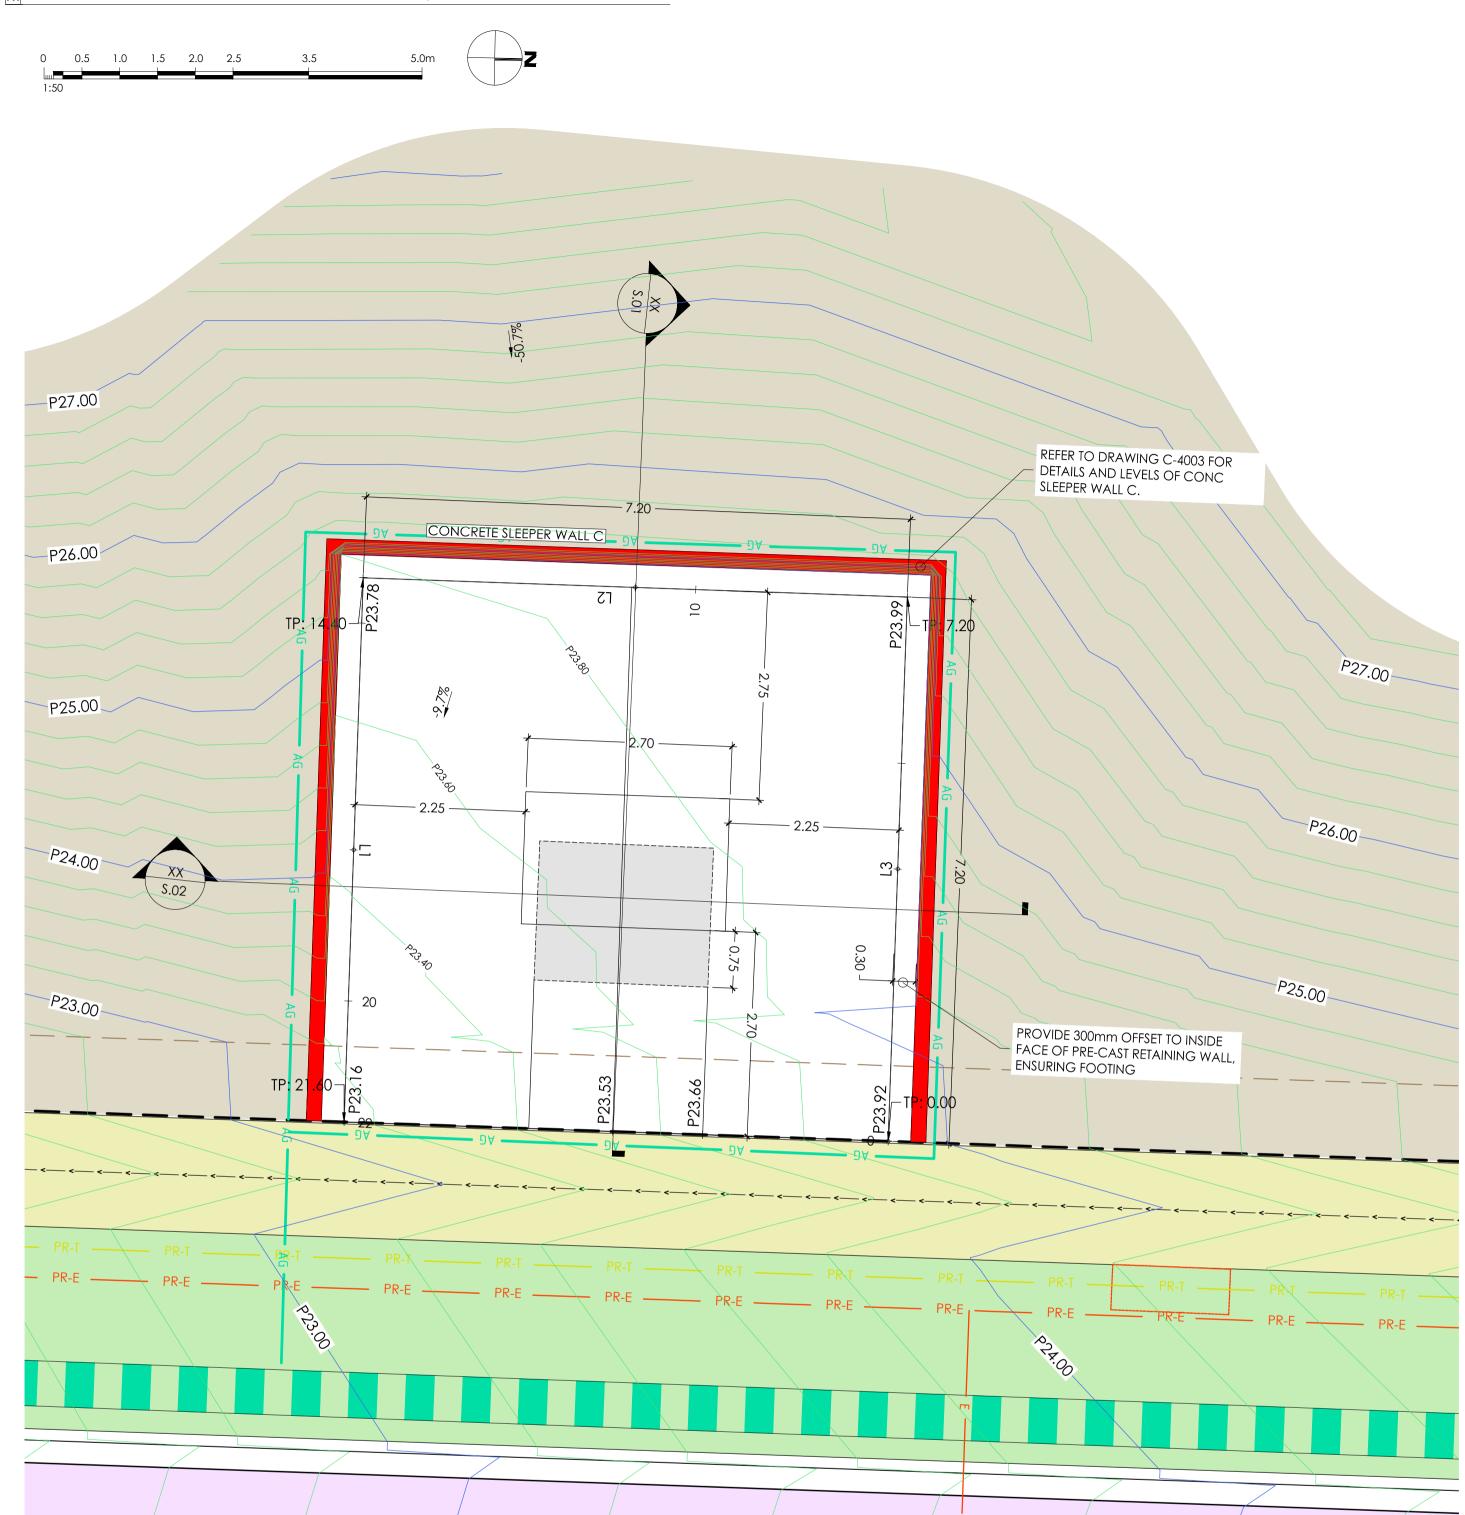HV KIOSK - SECTION VIEW SCALE 1:50

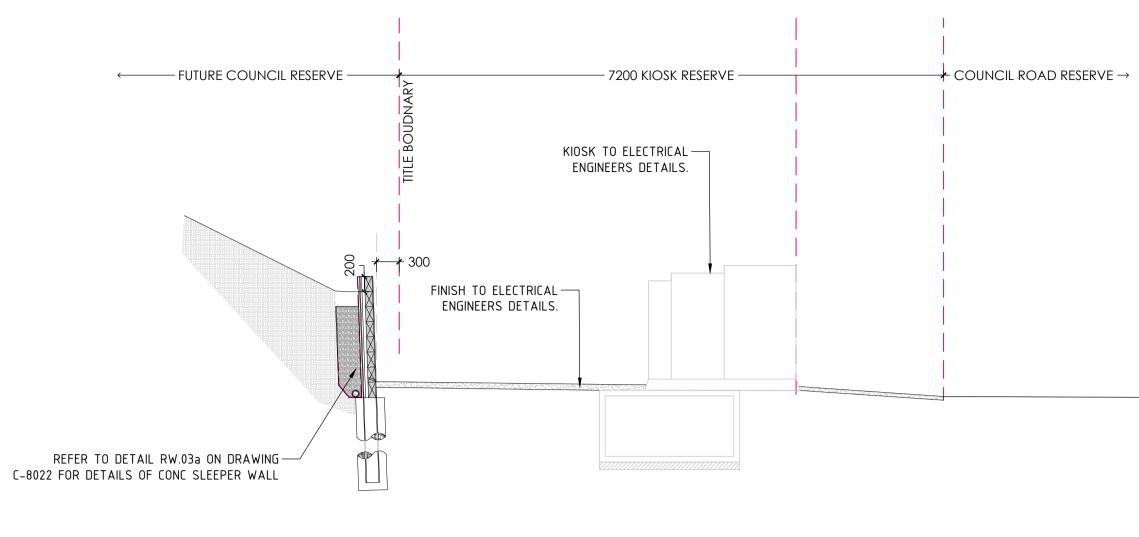

S.02 HV KIOSK - SECTION VIEW 8001 SCALE 1:50

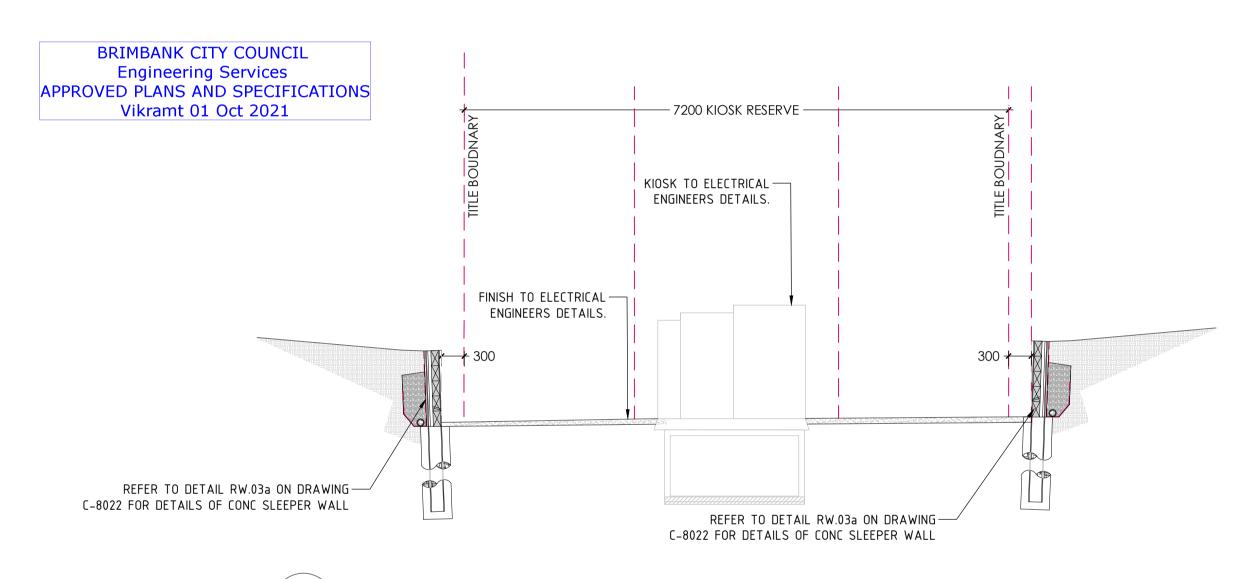	Set Out Table for EASEMENT SET-OUT								
TAG CHAINAGE EASTING NORTHING LENGTH RADIUS BEARING									
L3	START END	0.00 7.20	310341.089 310333.889	5819206.794 5819206.751	7.20		269° 39′ 1		
L2	START END	7.20 14.40	310333.889 310333.932	5819206.751 5819199.551	7.20		179° 39′ 15		
L1	START END	14.40 21.60	310333.932 310341.132	5819199.551 5819199.595	7.20		089° 39′ 1		



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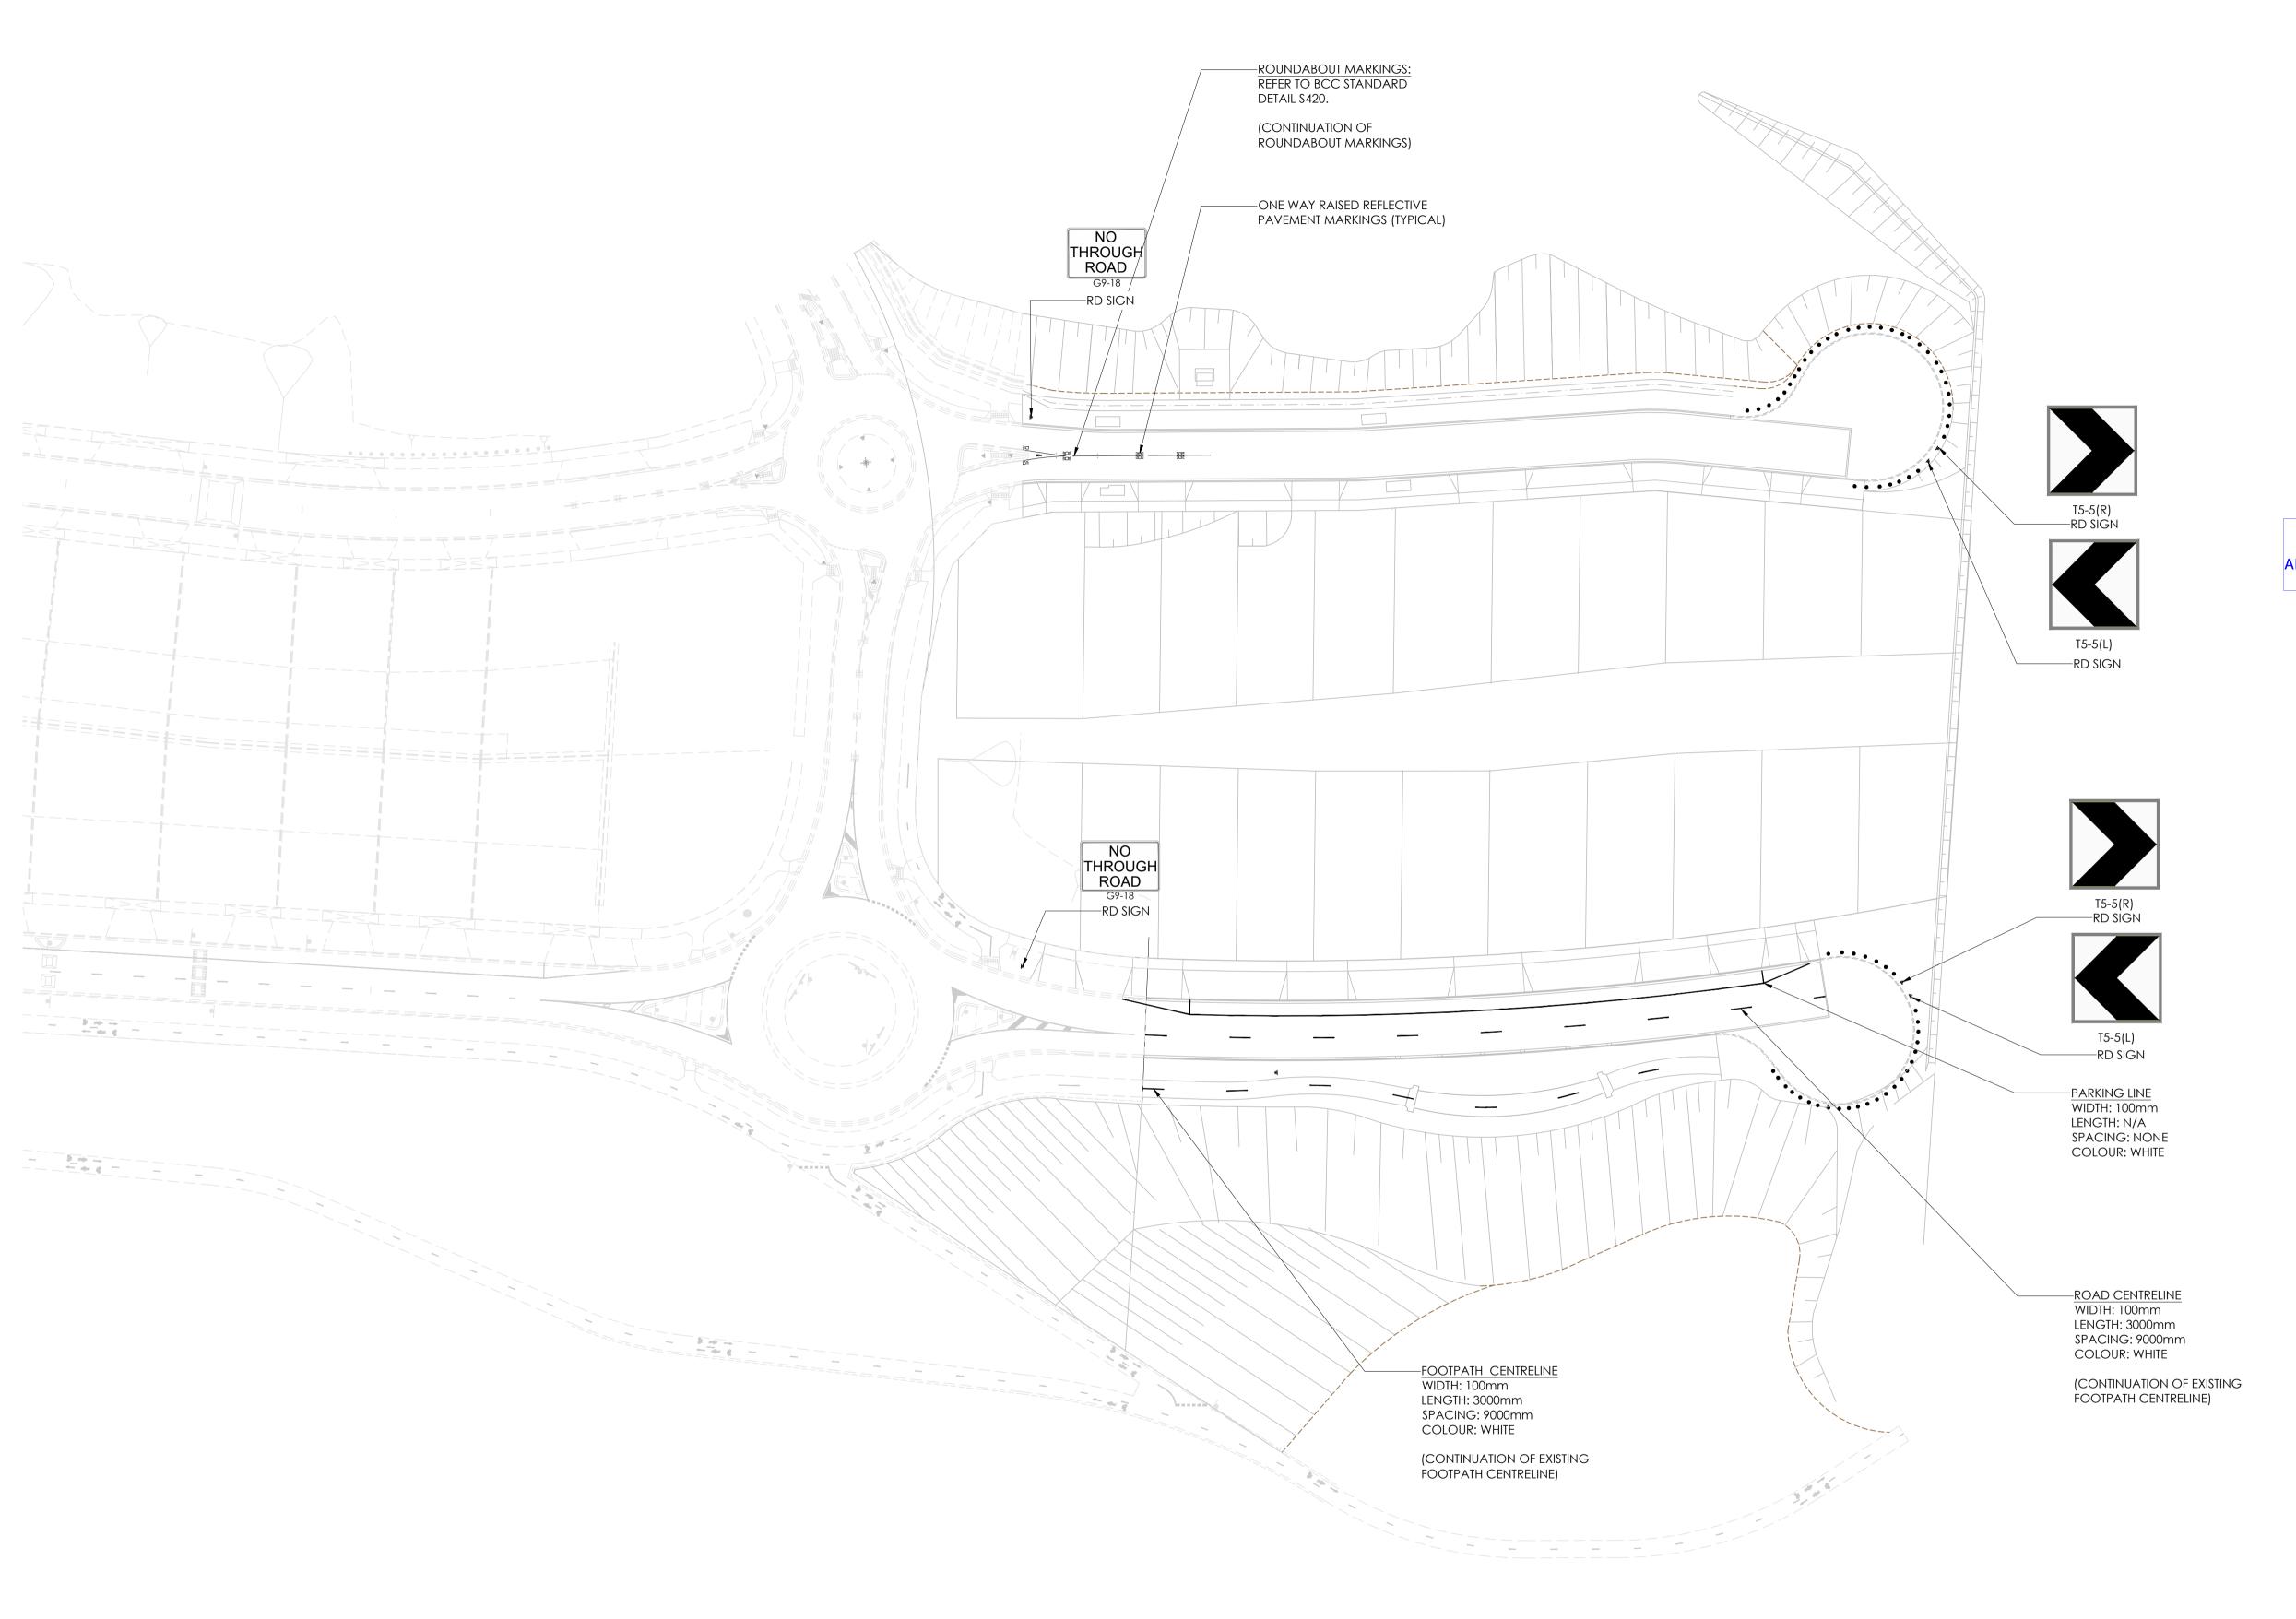
Dial before you dig. BEWARE OF UNDERGROUND SERVICES. The location of underground services are approximate only and their exact position should be proven on site. No guarantee is given that existing services are shown.







Project RIVER VALLEY - STAGE 7C Drawing Title
CONSTRUCTION SETOUT HV KIOSK Client YOURLAND Drawn Scale ISSUED FOR CONSTRUCTION 1:50 @ A1 15019 CJA 7C DR 8100



BRIMBANK CITY COUNCIL **Engineering Services** APPROVED PLANS AND SPECIFICATIONS Vikramt 01 Oct 2021

#### DRAWING NOTES:

- ALL WORKS TO BE IN ACCORDANCE WITH AS 1742. ALL LINEMARKING AND SIGNAGE TO BE IN ACCORDANCE WITH VICROADS AND TRAFFIC
- 2. LINEMARKING SET-OUT SHALL BE INSPECTED AND APPROVED PRIOR TO FINAL LINEMARKING IS UNDERTAKEN.
- 3. ALL LINEMARKING TO LONG LIFE MATERIAL (DEGADUE).
- 4. ANY OBSOLETE LINEMARKING IS TO BE REMOVED BY GRINDING STRIPPING OR THE APPLICATION OF BITUMEN BINDER AND GRIT PRIOR TO 'NEW' LINEMARKING BEING PLACED.
- RAISED PAVEMENT MARKERS ARE TO BE PROVIDED IN ACCORDANCE WITH AS 1742.

- 6. ALL SIGNAGE TO BE INSTALLED AS PER BRIMBANK CITY COUNCIL DETAIL





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15019 CJA 7C

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T: (03) 9285 2800 | E: info@cjarms.com | W: www.cjarms.com Project RIVER VALLEY - STAGE 7C Drawing Title SIGNAGE AND LINEMARKING PLAN Client YOURLAND ISSUED FOR CONSTRUCTION 1:500 @ A1

DR

С

8500

ISSUED FOR CONSTRUCTION

PLAN OF SUBDIVISION				EDITION 1	PS81	17489J
LOCATION OF LAND			COUNCIL NAME: BRII	MBANK CITY COU	NCIL	
PARISH: CUT PAW PAW						
SECTION:	22					
CROWN ALLOTMENT:	A (PART)					
SECTION:	В					
CROWN ALLOTMENT:	1 (PART), 2 (PAR	T) & 3 (PART)				
TITLE REFERENCE:	Vol. Fol.	, , ,				
LAST PLAN REFEREN	CE: Lot BR on PS8392	289T				
POSTAL ADDRESS: (at time of subdivision)	Halong Drive SUNSHINE NORT	TH 3020				
MGA 94 CO-ORDINATE (of approx centre of land in plan)	ES: E: 310 380 N: 5 819 230	ZONE: 55	5			
	OF ROADS AND/OR	RESERVES			NOTATIONS	
IDENTIFIER		ODY/PERSON		Lots 1 - 20 (both inclusive) an		
Road R1 Road R2 Reserve No. 1	Brimbank	City Council City Council Australia Ltd		Refer to Creation of Restrictions A B & C on Sheets 9 & 10 of this plan for details.		
	NOTATIONS			OWNERS CORPORATIONS		
	5.24 metres below the surface sown in Vol. 11151 Fol.184.	applied to land as		& liability see owners corpora information and if applicable,	tion search report, owr	
been adopted in accordance deducted from title. STAGING:						
been adopted in accordance deducted from title.  STAGING: This is not a staged subdivisi Planning Permit No. P186/20  RIVER VALLEY ES Area of Release: 1.39	ion. STATE - Release 7C	ot E on this plan has	s been			
been adopted in accordance deducted from title.  STAGING: This is not a staged subdivisi Planning Permit No. P186/20  RIVER VALLEY ES Area of Release: 1.39	ion. 017 STATE - Release 7C	s) and Balance Lo	ots E & F	IFORMATION		
been adopted in accordance deducted from title.  STAGING: This is not a staged subdivisi Planning Permit No. P186/20  RIVER VALLEY ES Area of Release: 1.39 No. of Lots: 20 L	ion. 017 STATE - Release 7C	s) and Balance Lo	ots E & F			
been adopted in accordance deducted from title.  STAGING: This is not a staged subdivisi Planning Permit No. P186/20  RIVER VALLEY ES Area of Release: 1.39 No. of Lots: 20 L	ion. 017 STATE - Release 7C 99ha Lots, Superlot AA (2 Parts	s) and Balance Lo	ots E & F EMENT IN		Land Benefited	I/In Favour Of
been adopted in accordance deducted from title.  STAGING: This is not a staged subdivisi Planning Permit No. P186/20  RIVER VALLEY ES Area of Release: 1.39 No. of Lots: 20 L  LEGEND: A - Appurtenant	ion. OTATE - Release 7C 99ha Lots, Superlot AA (2 Parts Easement E - Encumberi	s) and Balance Lo EASE ng Easement R -	ots E & F EMENT IN - Encumbering	g Easement (Road)	Land Benefited	I/In Favour Of
been adopted in accordance deducted from title.  STAGING: This is not a staged subdivisi Planning Permit No. P186/20  RIVER VALLEY ES Area of Release: 1.38 No. of Lots: 20 L  LEGEND: A - Appurtenant  Easement Reference	ion. OTATE - Release 7C 99ha Lots, Superlot AA (2 Parts Easement E - Encumberi	s) and Balance Lo EASE  ng Easement R -  Width (Metres)	ots E & F EMENT IN - Encumbering	g Easement (Road) rigin  Ref. 02044-7C	ORIGINAL SHEET	
been adopted in accordance deducted from title.  STAGING: This is not a staged subdivisi Planning Permit No. P186/20  RIVER VALLEY ES Area of Release: 1.38 No. of Lots: 20 L  LEGEND: A - Appurtenant  Easement Reference	ion. OTATE - Release 7C 99ha Lots, Superlot AA (2 Parts Easement E - Encumberi	s) and Balance Lo EASE  My Easement R -  Width (Metres)  SURVEYORS	ots E & F EMENT IN Encumbering Or	g Easement (Road)		l/In Favour Of SHEET 1 OF 10
been adopted in accordance deducted from title.  STAGING: This is not a staged subdivisi Planning Permit No. P186/20  RIVER VALLEY ES Area of Release: 1.38 No. of Lots: 20 L  LEGEND: A - Appurtenant  Easement Reference	ion. O17  STATE - Release 7C 99ha Lots, Superlot AA (2 Parts Easement E - Encumberi  Purpose  S Environments   Infrastructure	SURVEYORS Licensed Sur	ots E & F EMENT IN - Encumbering Or  S FILE REF:	g Easement (Road) rigin  Ref. 02044-7C	ORIGINAL SHEET	

PS817489J

### EASEMENT INFORMATION

Easement Reference	Purpose	Width (Metres)	Origin	Land Benefited/In Favour Of	
	Sewerage	_	PS512193G	City West Water Ltd.	
E-1	Sewerage	3	PS527948T	Lots on PS527948T	
	Sewerage			City West Water Ltd.	
E-2	Sewerage	3	PS527948T	Lots on PS527948T	
	Drainage	_	PS527948T	Lots on PS527948T	
E-3	Drainage	2	PS709369X	Brimbank City Council	
	Sewerage			City West Water Ltd.	
_,	Sewerage	See	PS527948T	Lots on PS527948T	
E-4	Drainage	Diagram			
	Drainage	1 1	PS709369X	Brimbank City Council	
E-5	Sewerage	3	PS826697A	City West Water Corporation	
E-6	Drainage	5	PS709369X	Brimbank City Council	
E-7	Drainage	See Diag.	This Plan	Brimbank City Council	
E-8	Supply of Water (through underground pipes)	6m	This Plan	City West Water Corporation.	
E-9	Power Line	2m	This Plan Section 88 Electricity Industry Act 2000	Powercor Australia Ltd	
E-10	Drainage	2	This Plan	Common Property No. 1 on this plan	
				BRIMBANK CITY COUNCIL Engineering Services APPROVED PLANS AND SPECIFICATIONS Vikramt 01 Oct 2021	

TAYLORS

Urban Development | Built Environments | Infrastructure 8 / 270 Ferntree Gully Road, Notting Hill, Victoria, 3168 Tel: 61 3 9501 2800 | Web: taylorsds.com.au

Licensed Surveyor:

MARK JAMES SOMMERVILLE / Version No 11

SIZE: A3 Ver. 11

ORIGINAL SHEET Ref. 02044-7C SHEET 2

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drawing.

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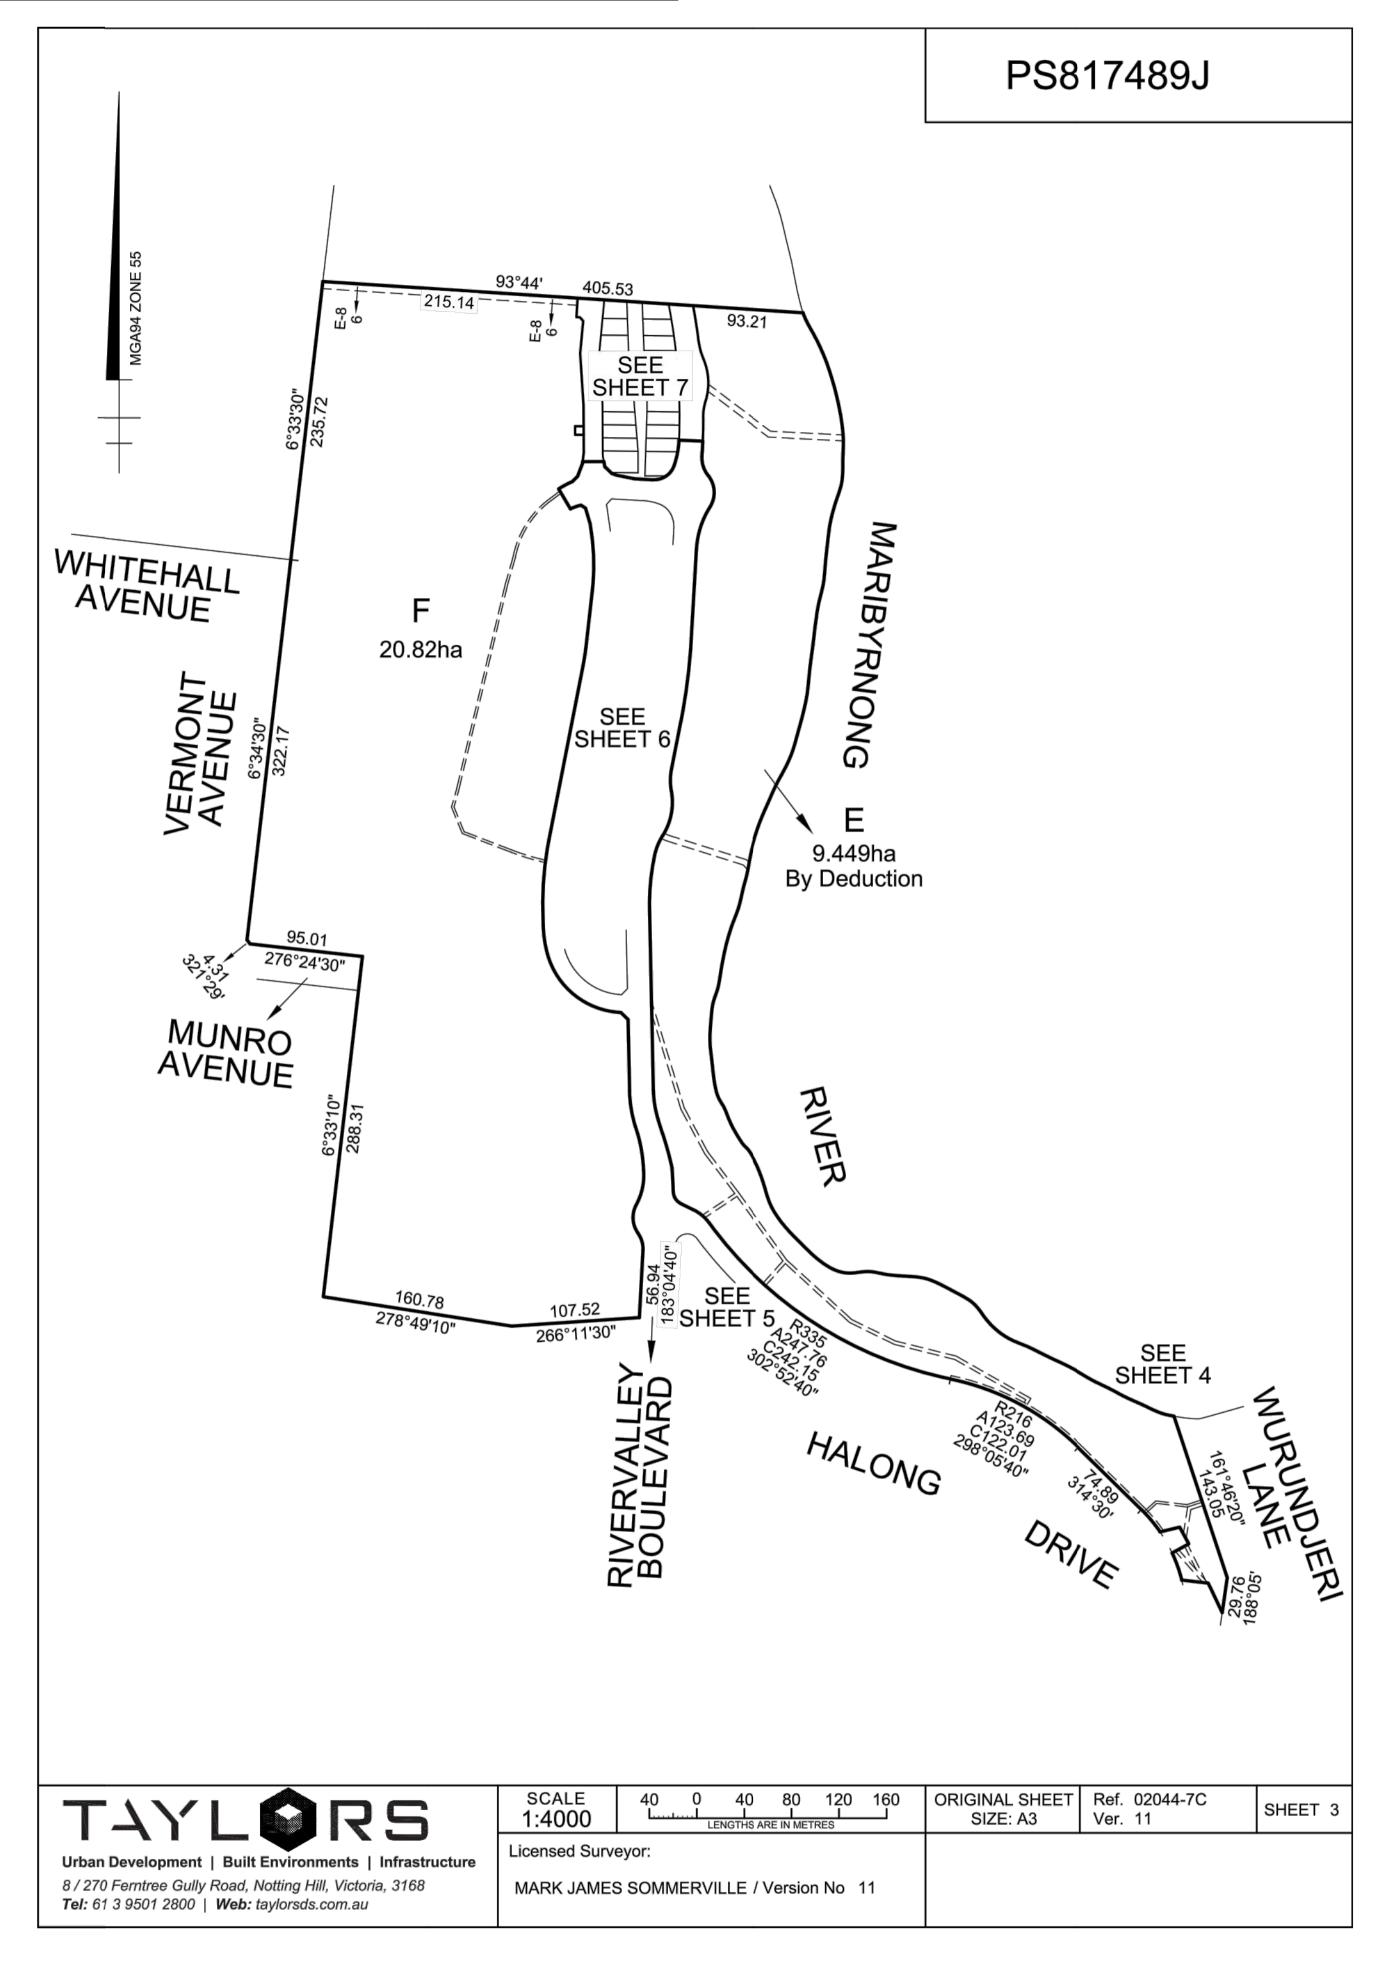
15019 CJA 7C XX


Project RIVER VALLEY - STAGE 7C Client YOURLAND ISSUED FOR CONSTRUCTION


Drawing Title SUB-DIVISION PLANS SHEET (1 OF 4) Checked By Drawn Scale Date of First Issue BW N/A @ A1 31.03.21

DR C

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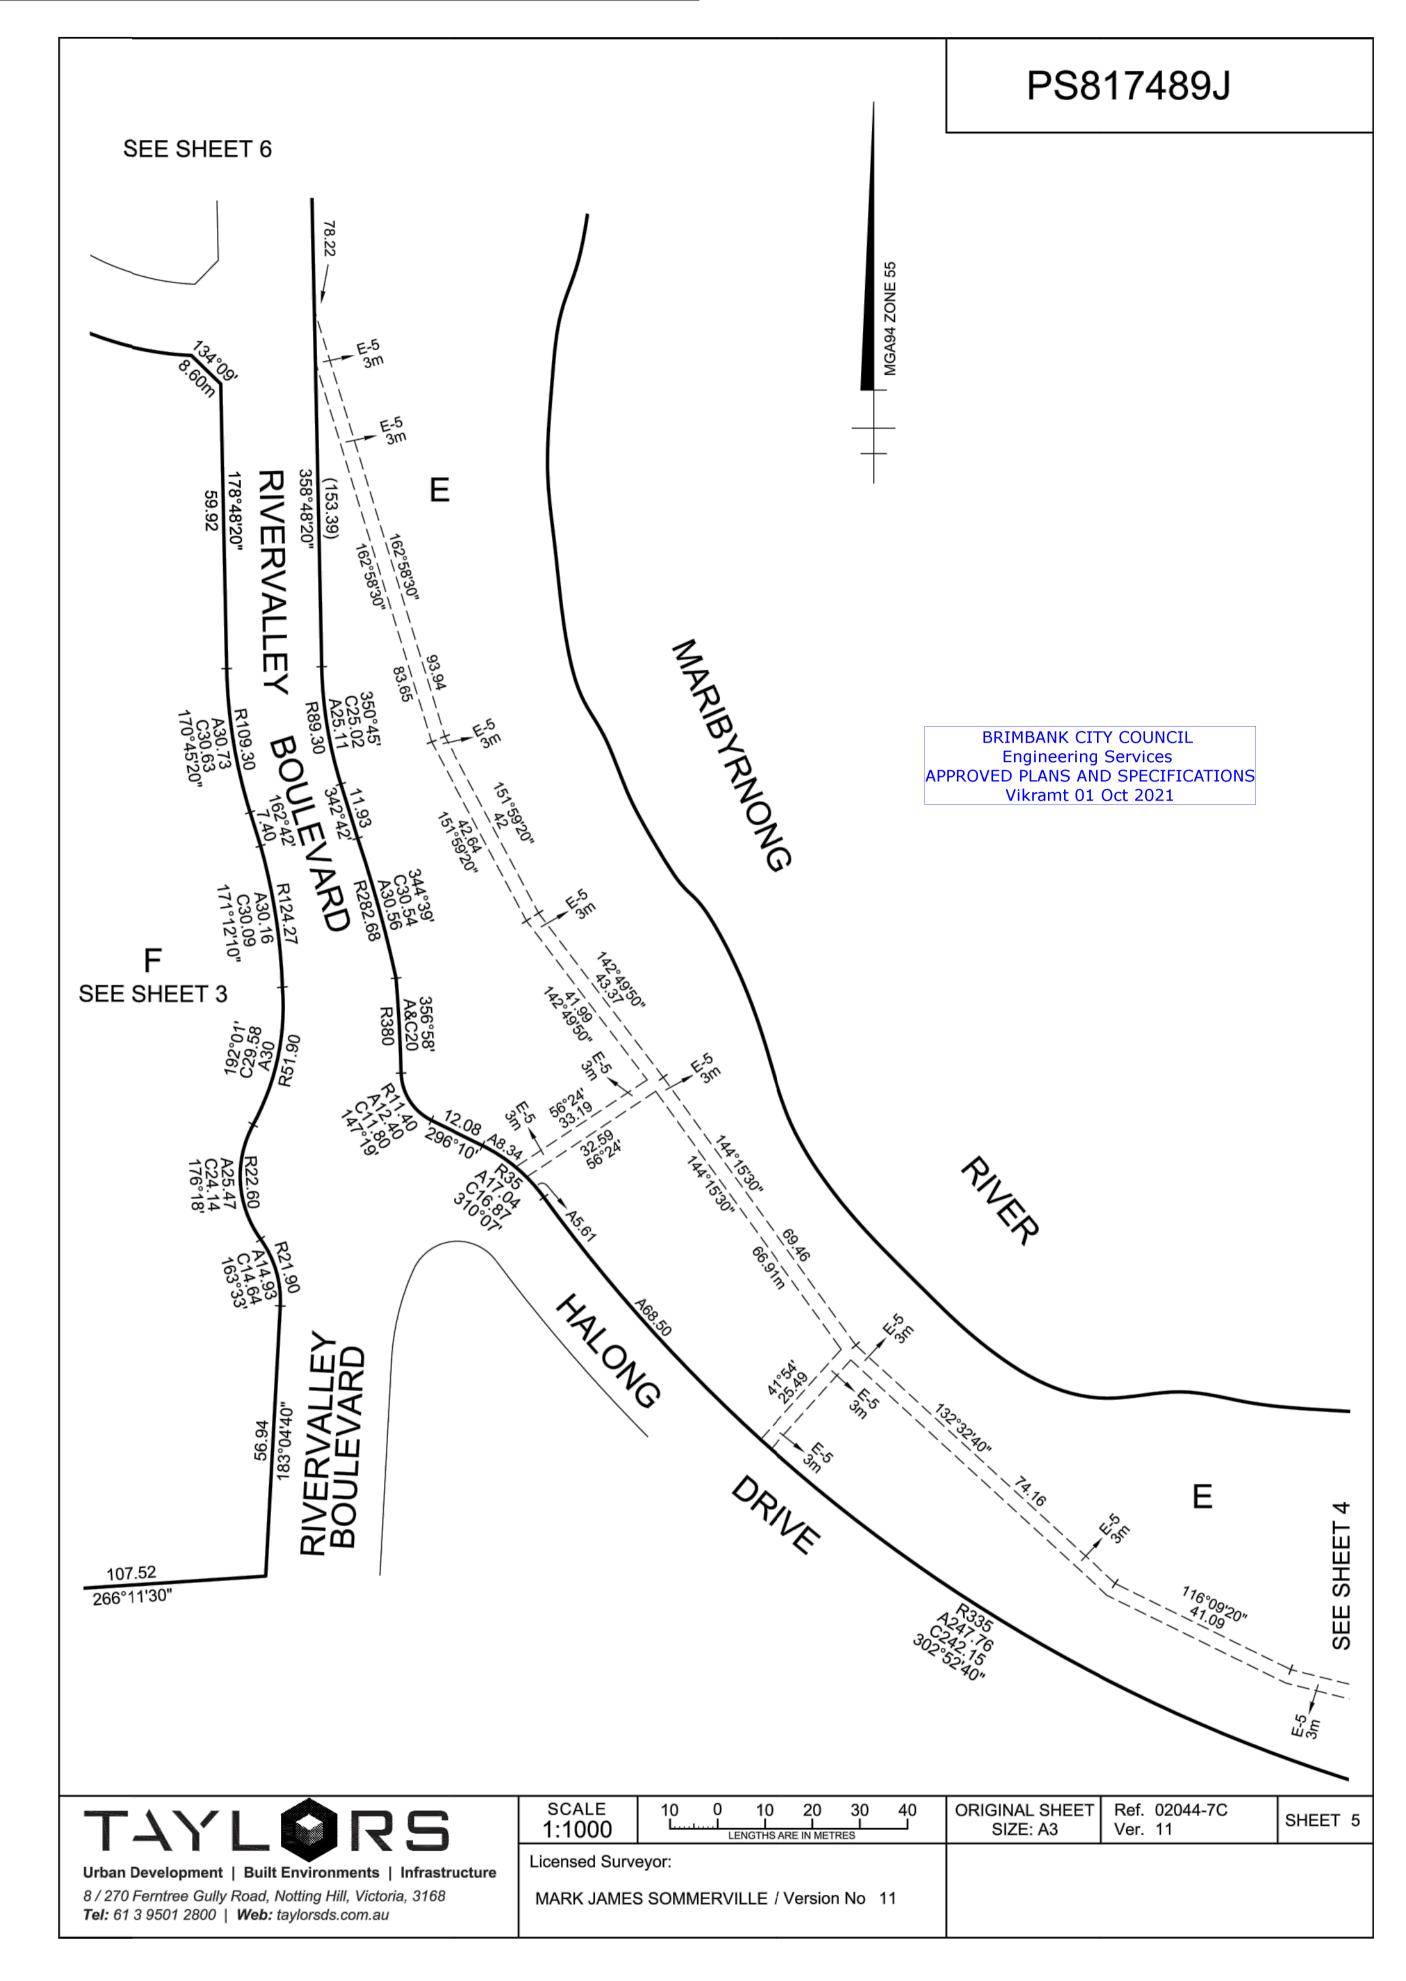





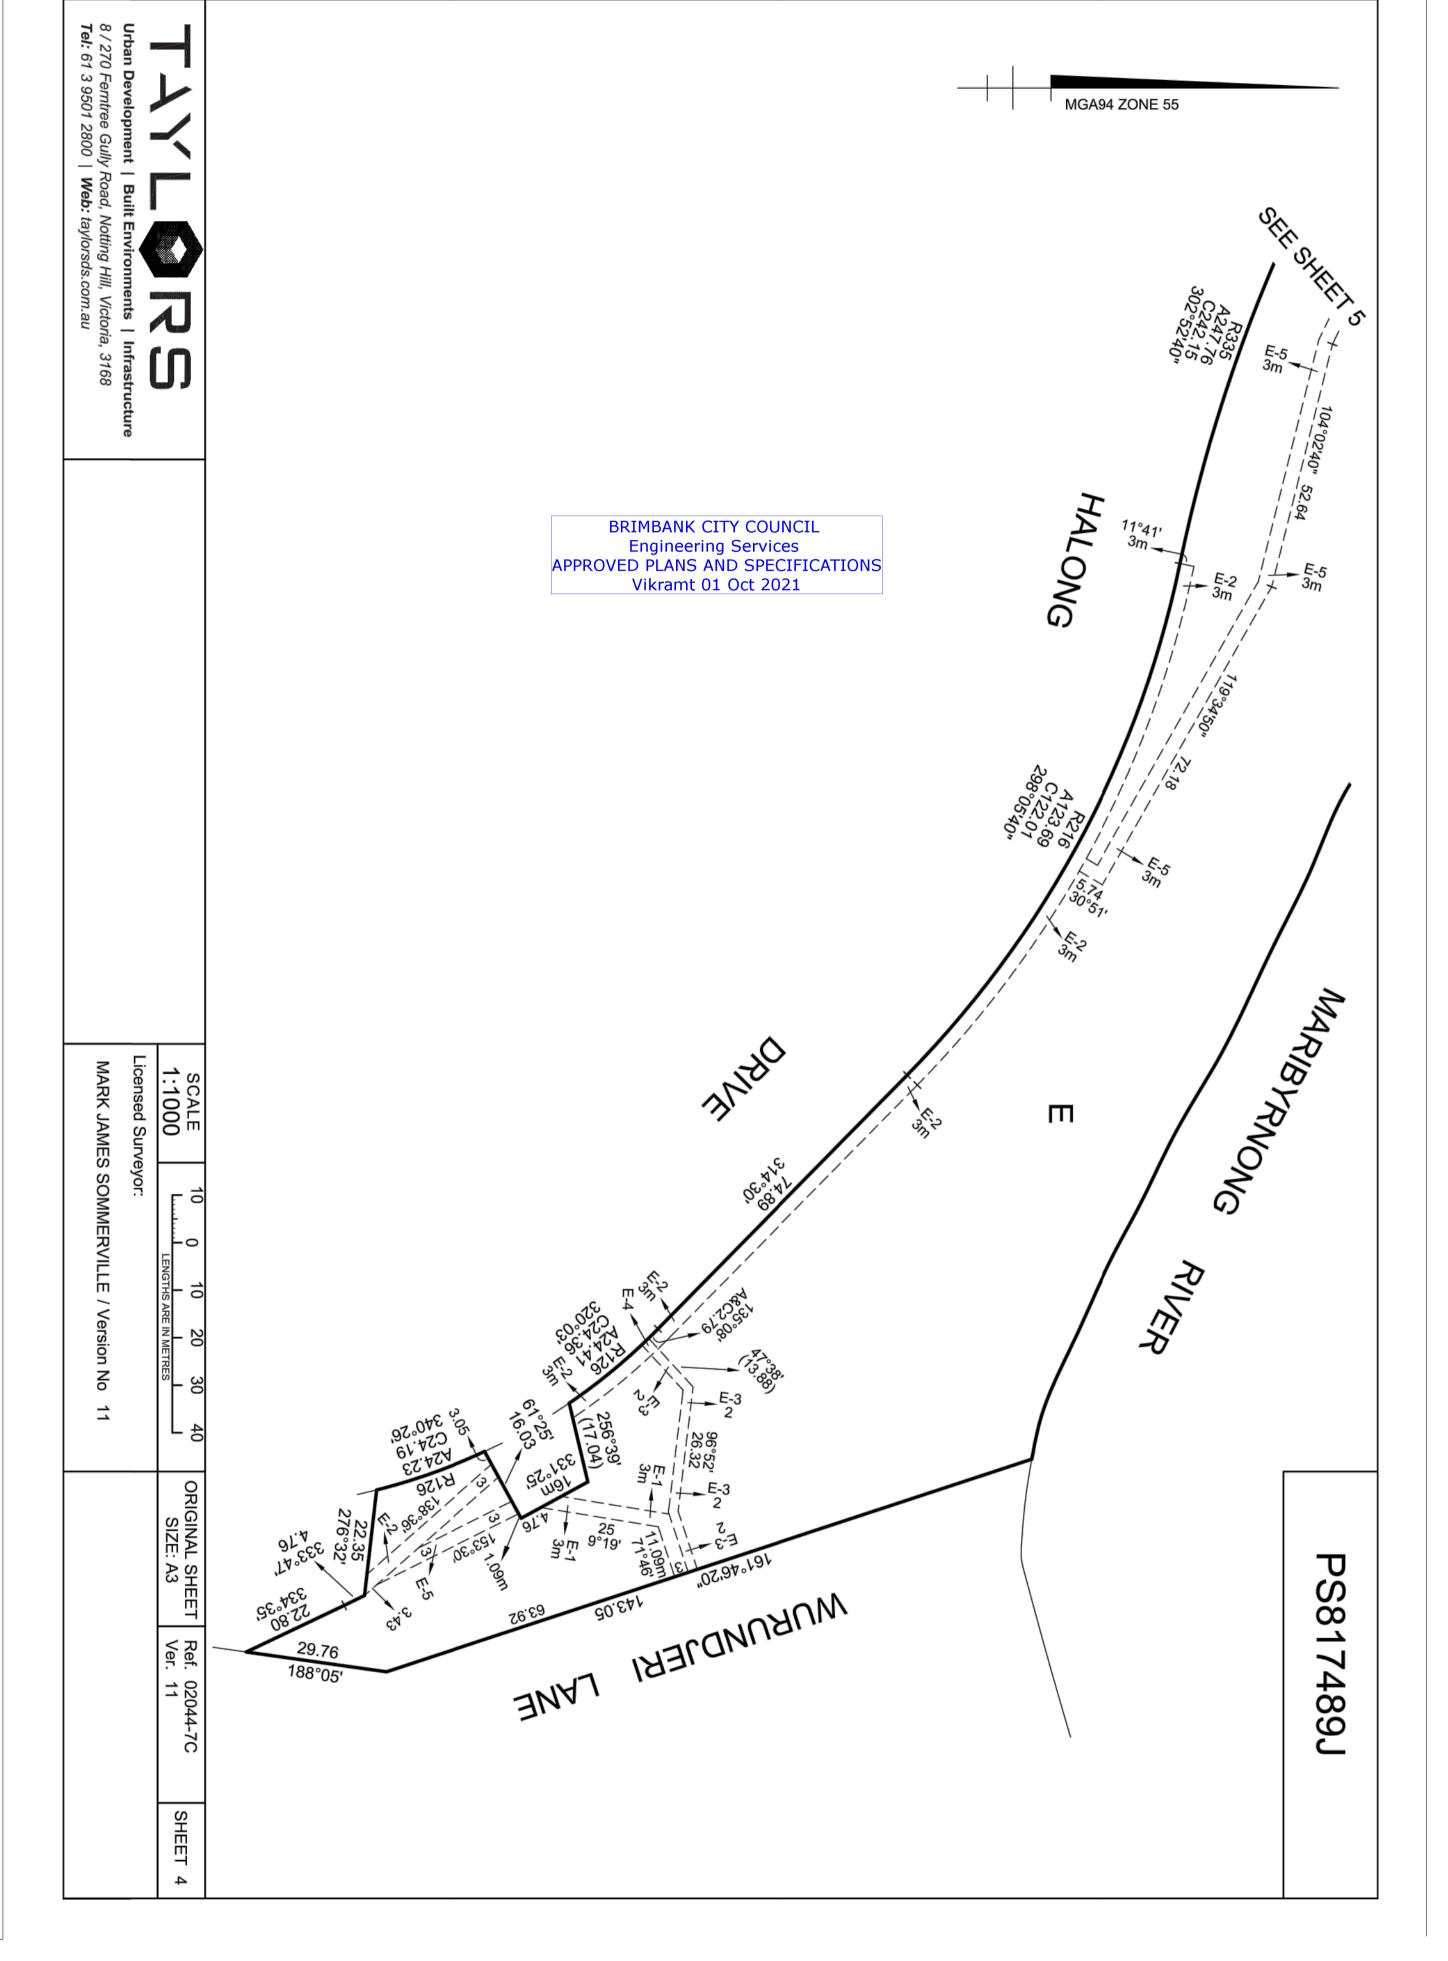

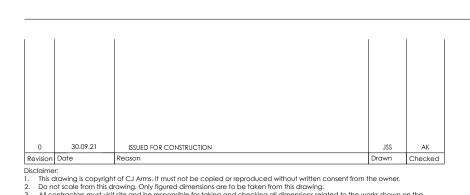
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SUB-DIVISION PLANS SHEET (2 OF 4)

Client YOURLAND ISSUED FOR CONSTRUCTION N/A @ A1 31.03.21 15019 CJA 7C DR 9201



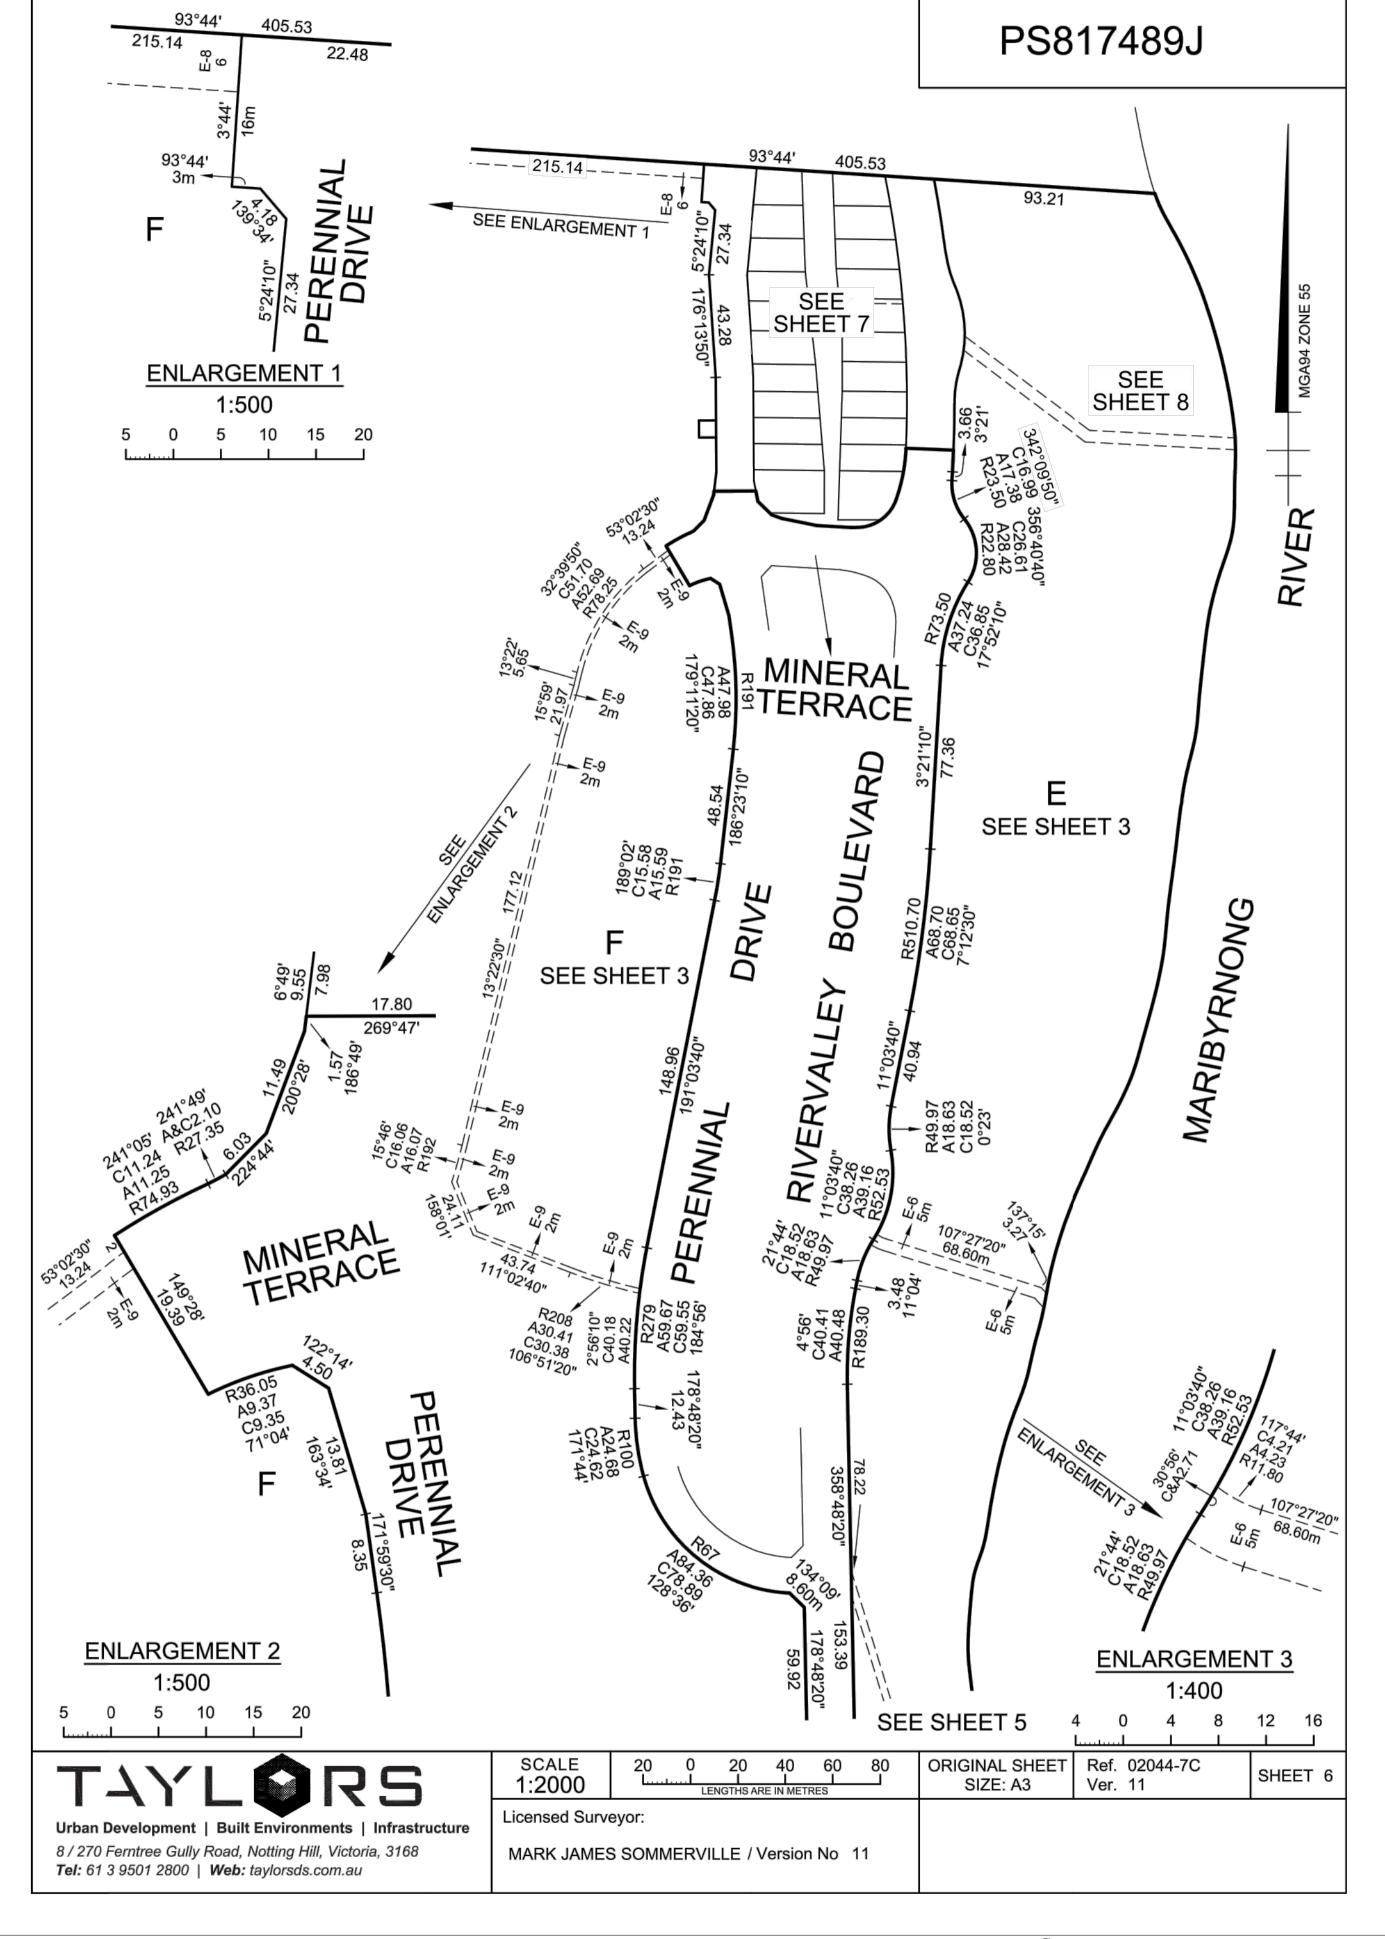

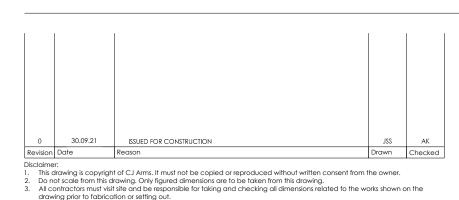

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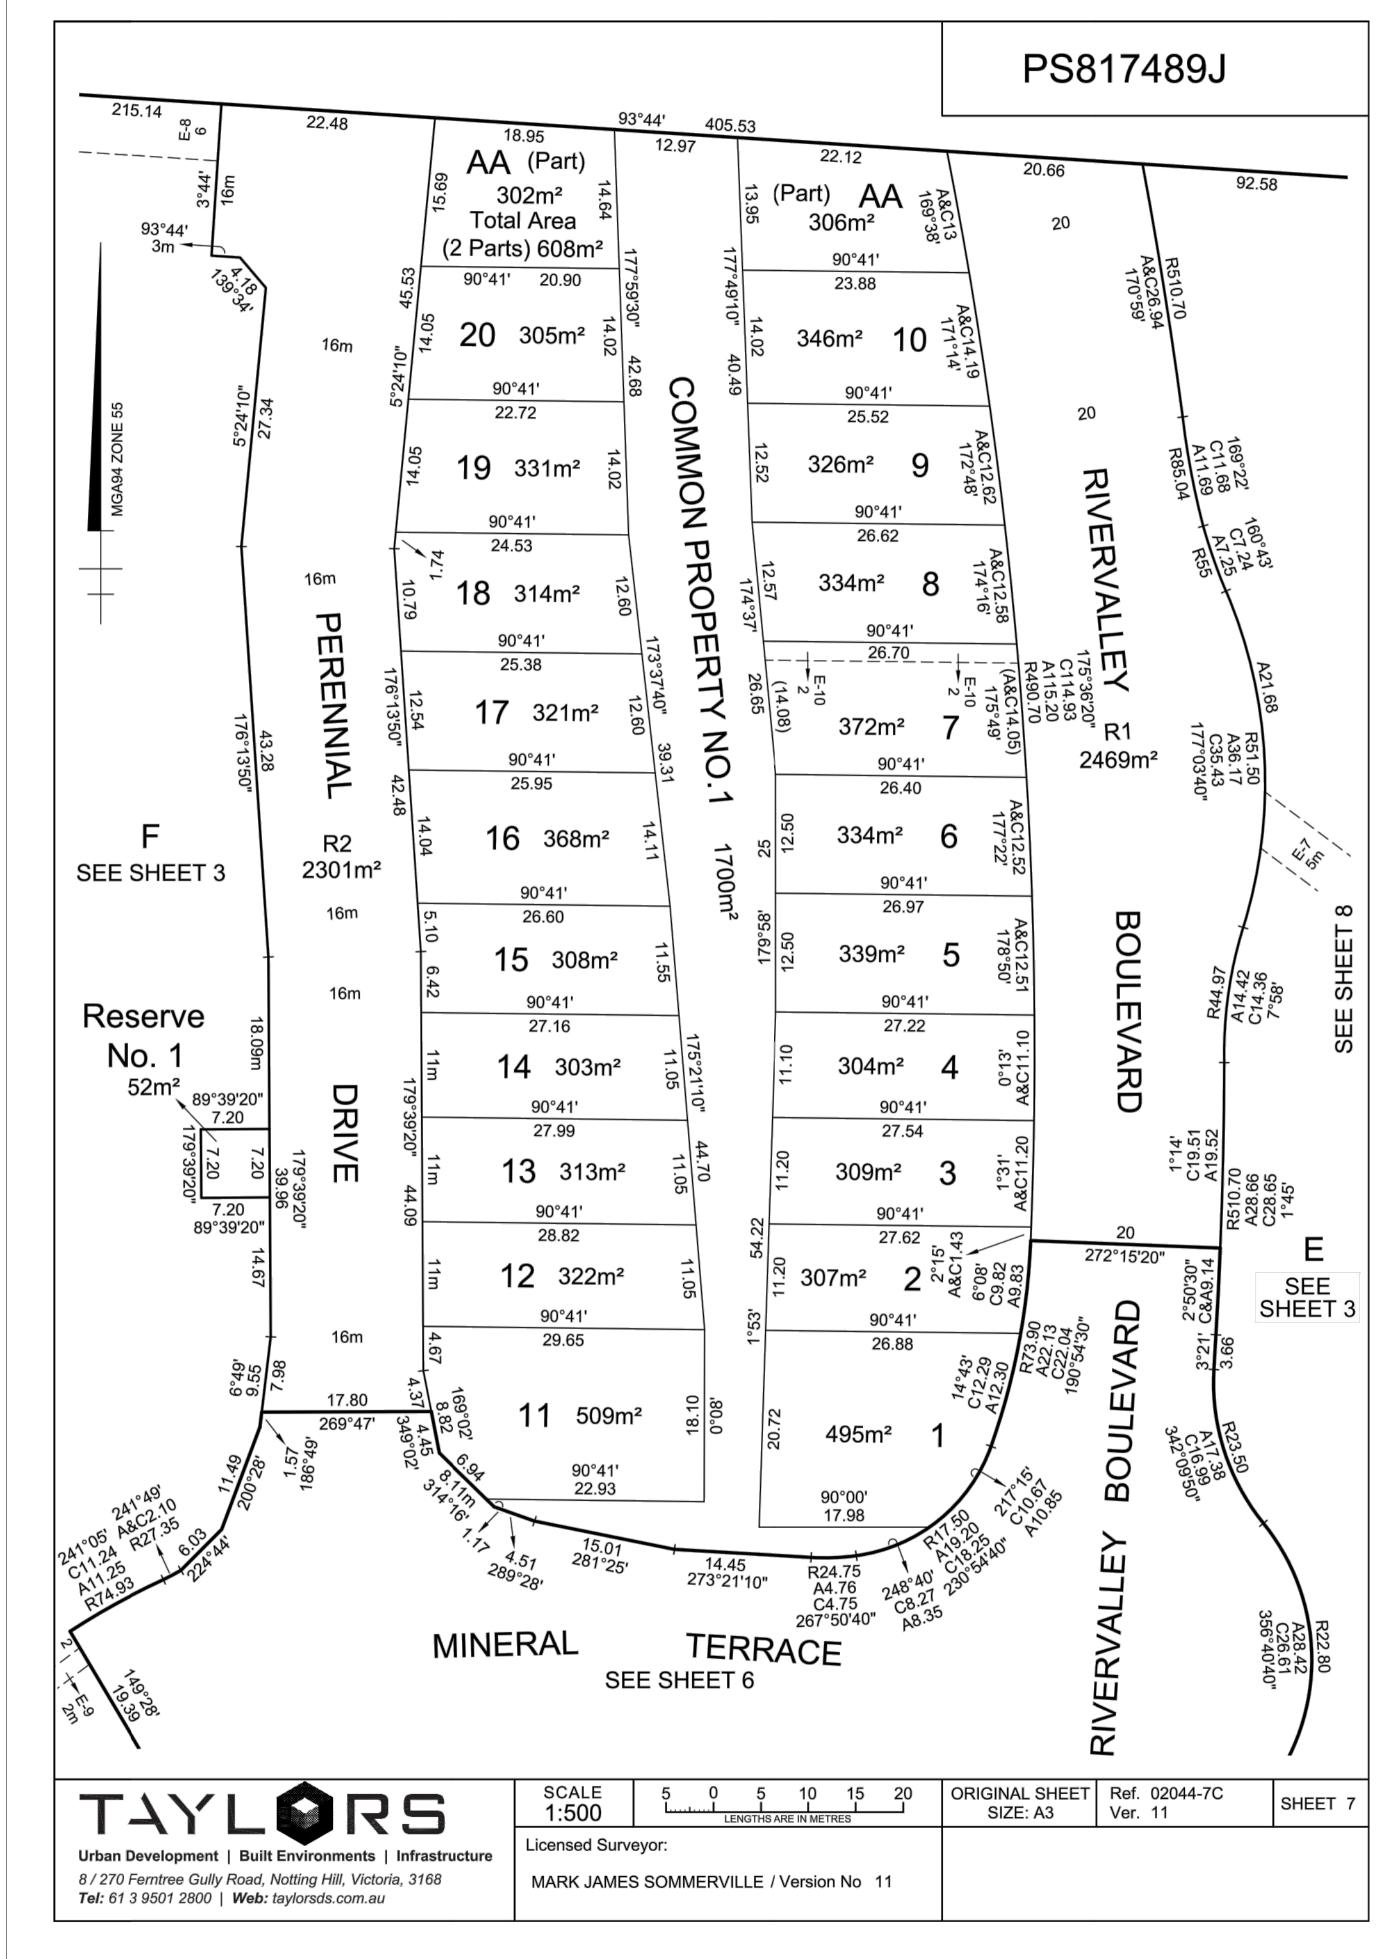
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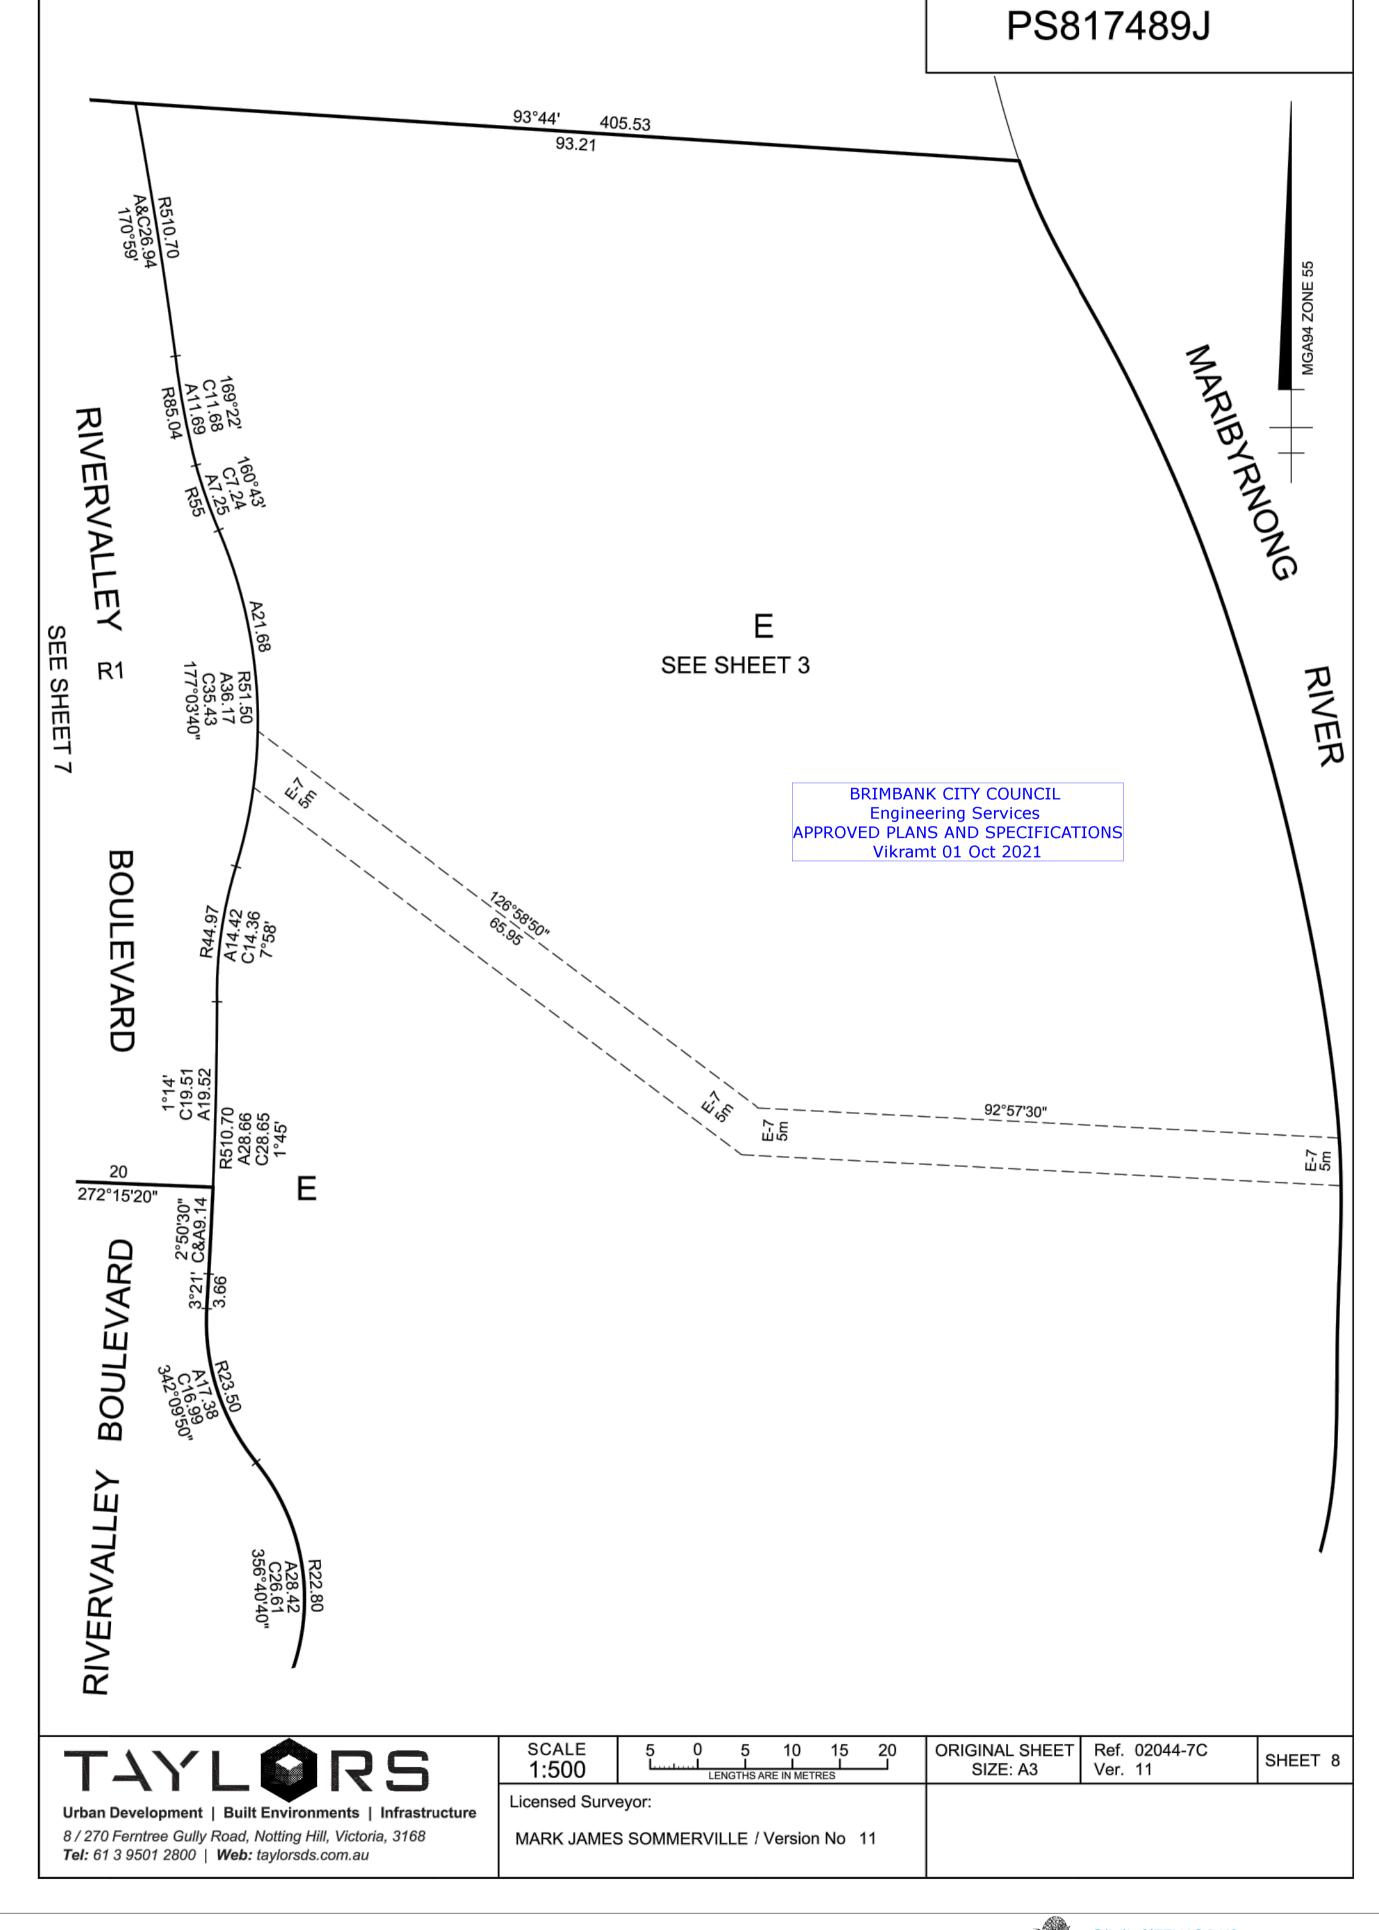







Project RIVER VALLEY - STAGE 7C Drawing Title
SUB-DIVISION PLANS SHEET (3 OF 4) YOURLAND ISSUED FOR CONSTRUCTION 15019 CJA 7C DR 9202





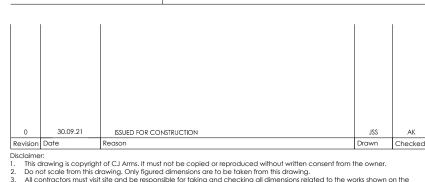

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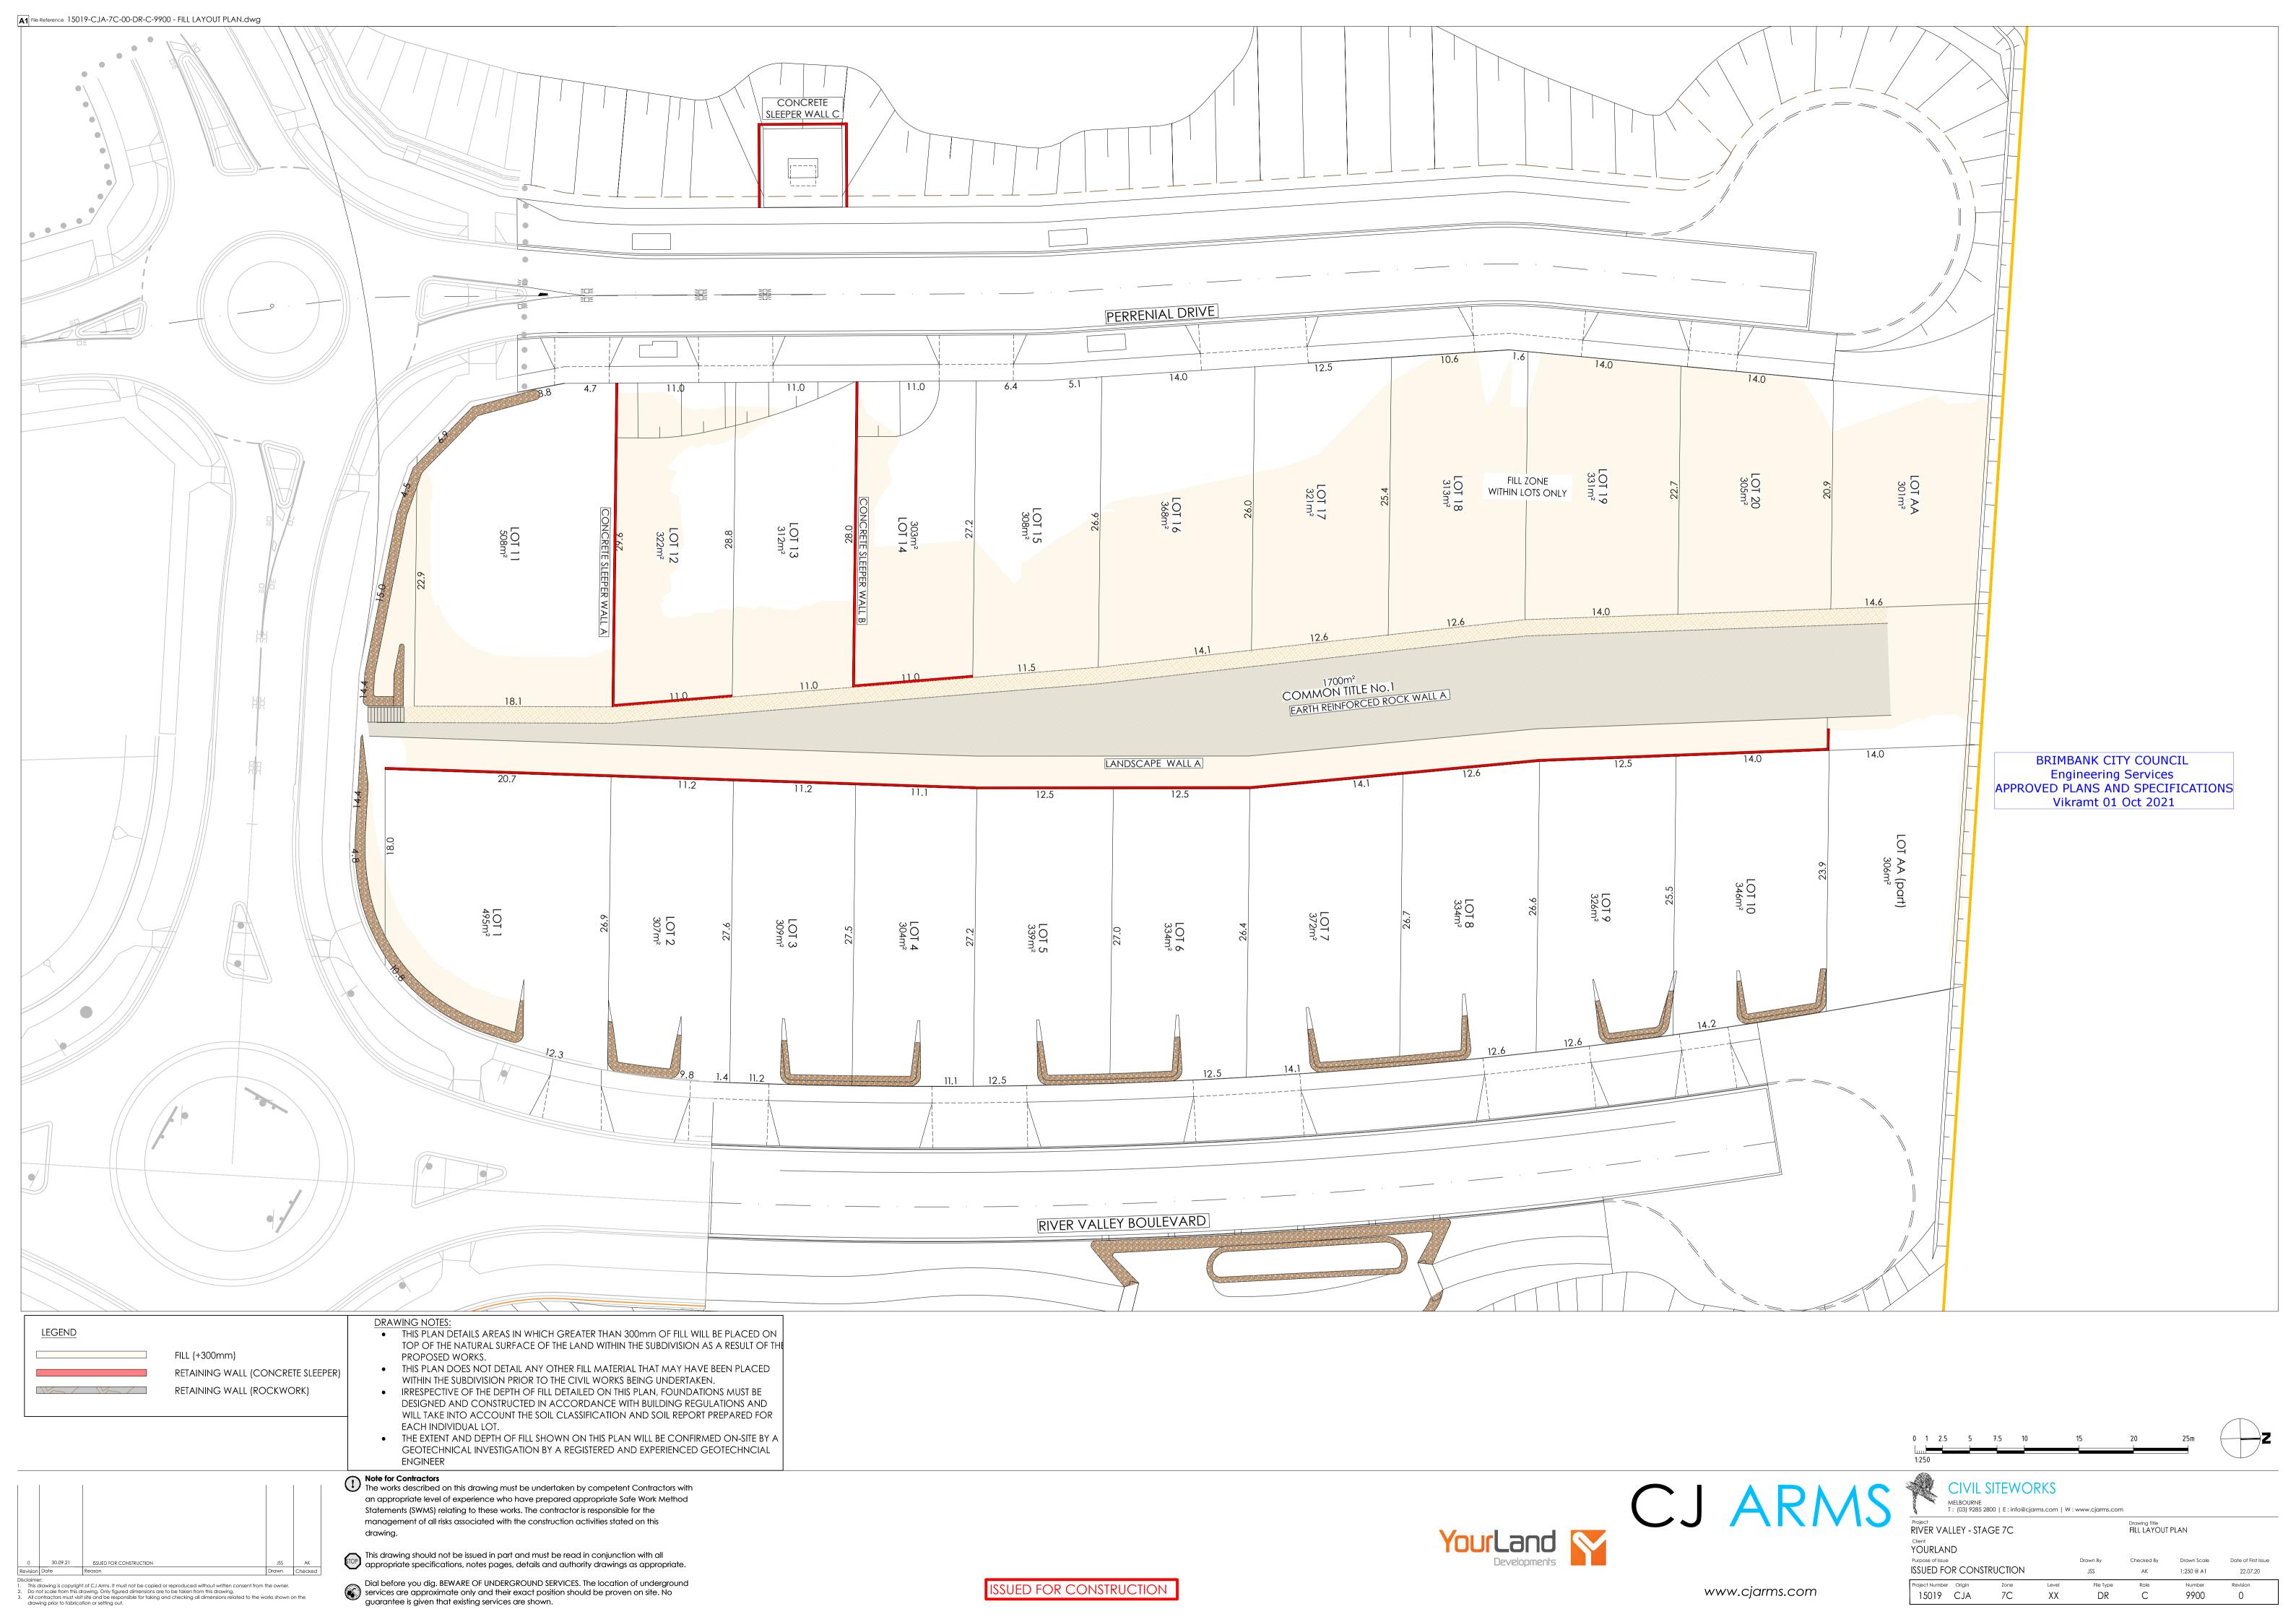
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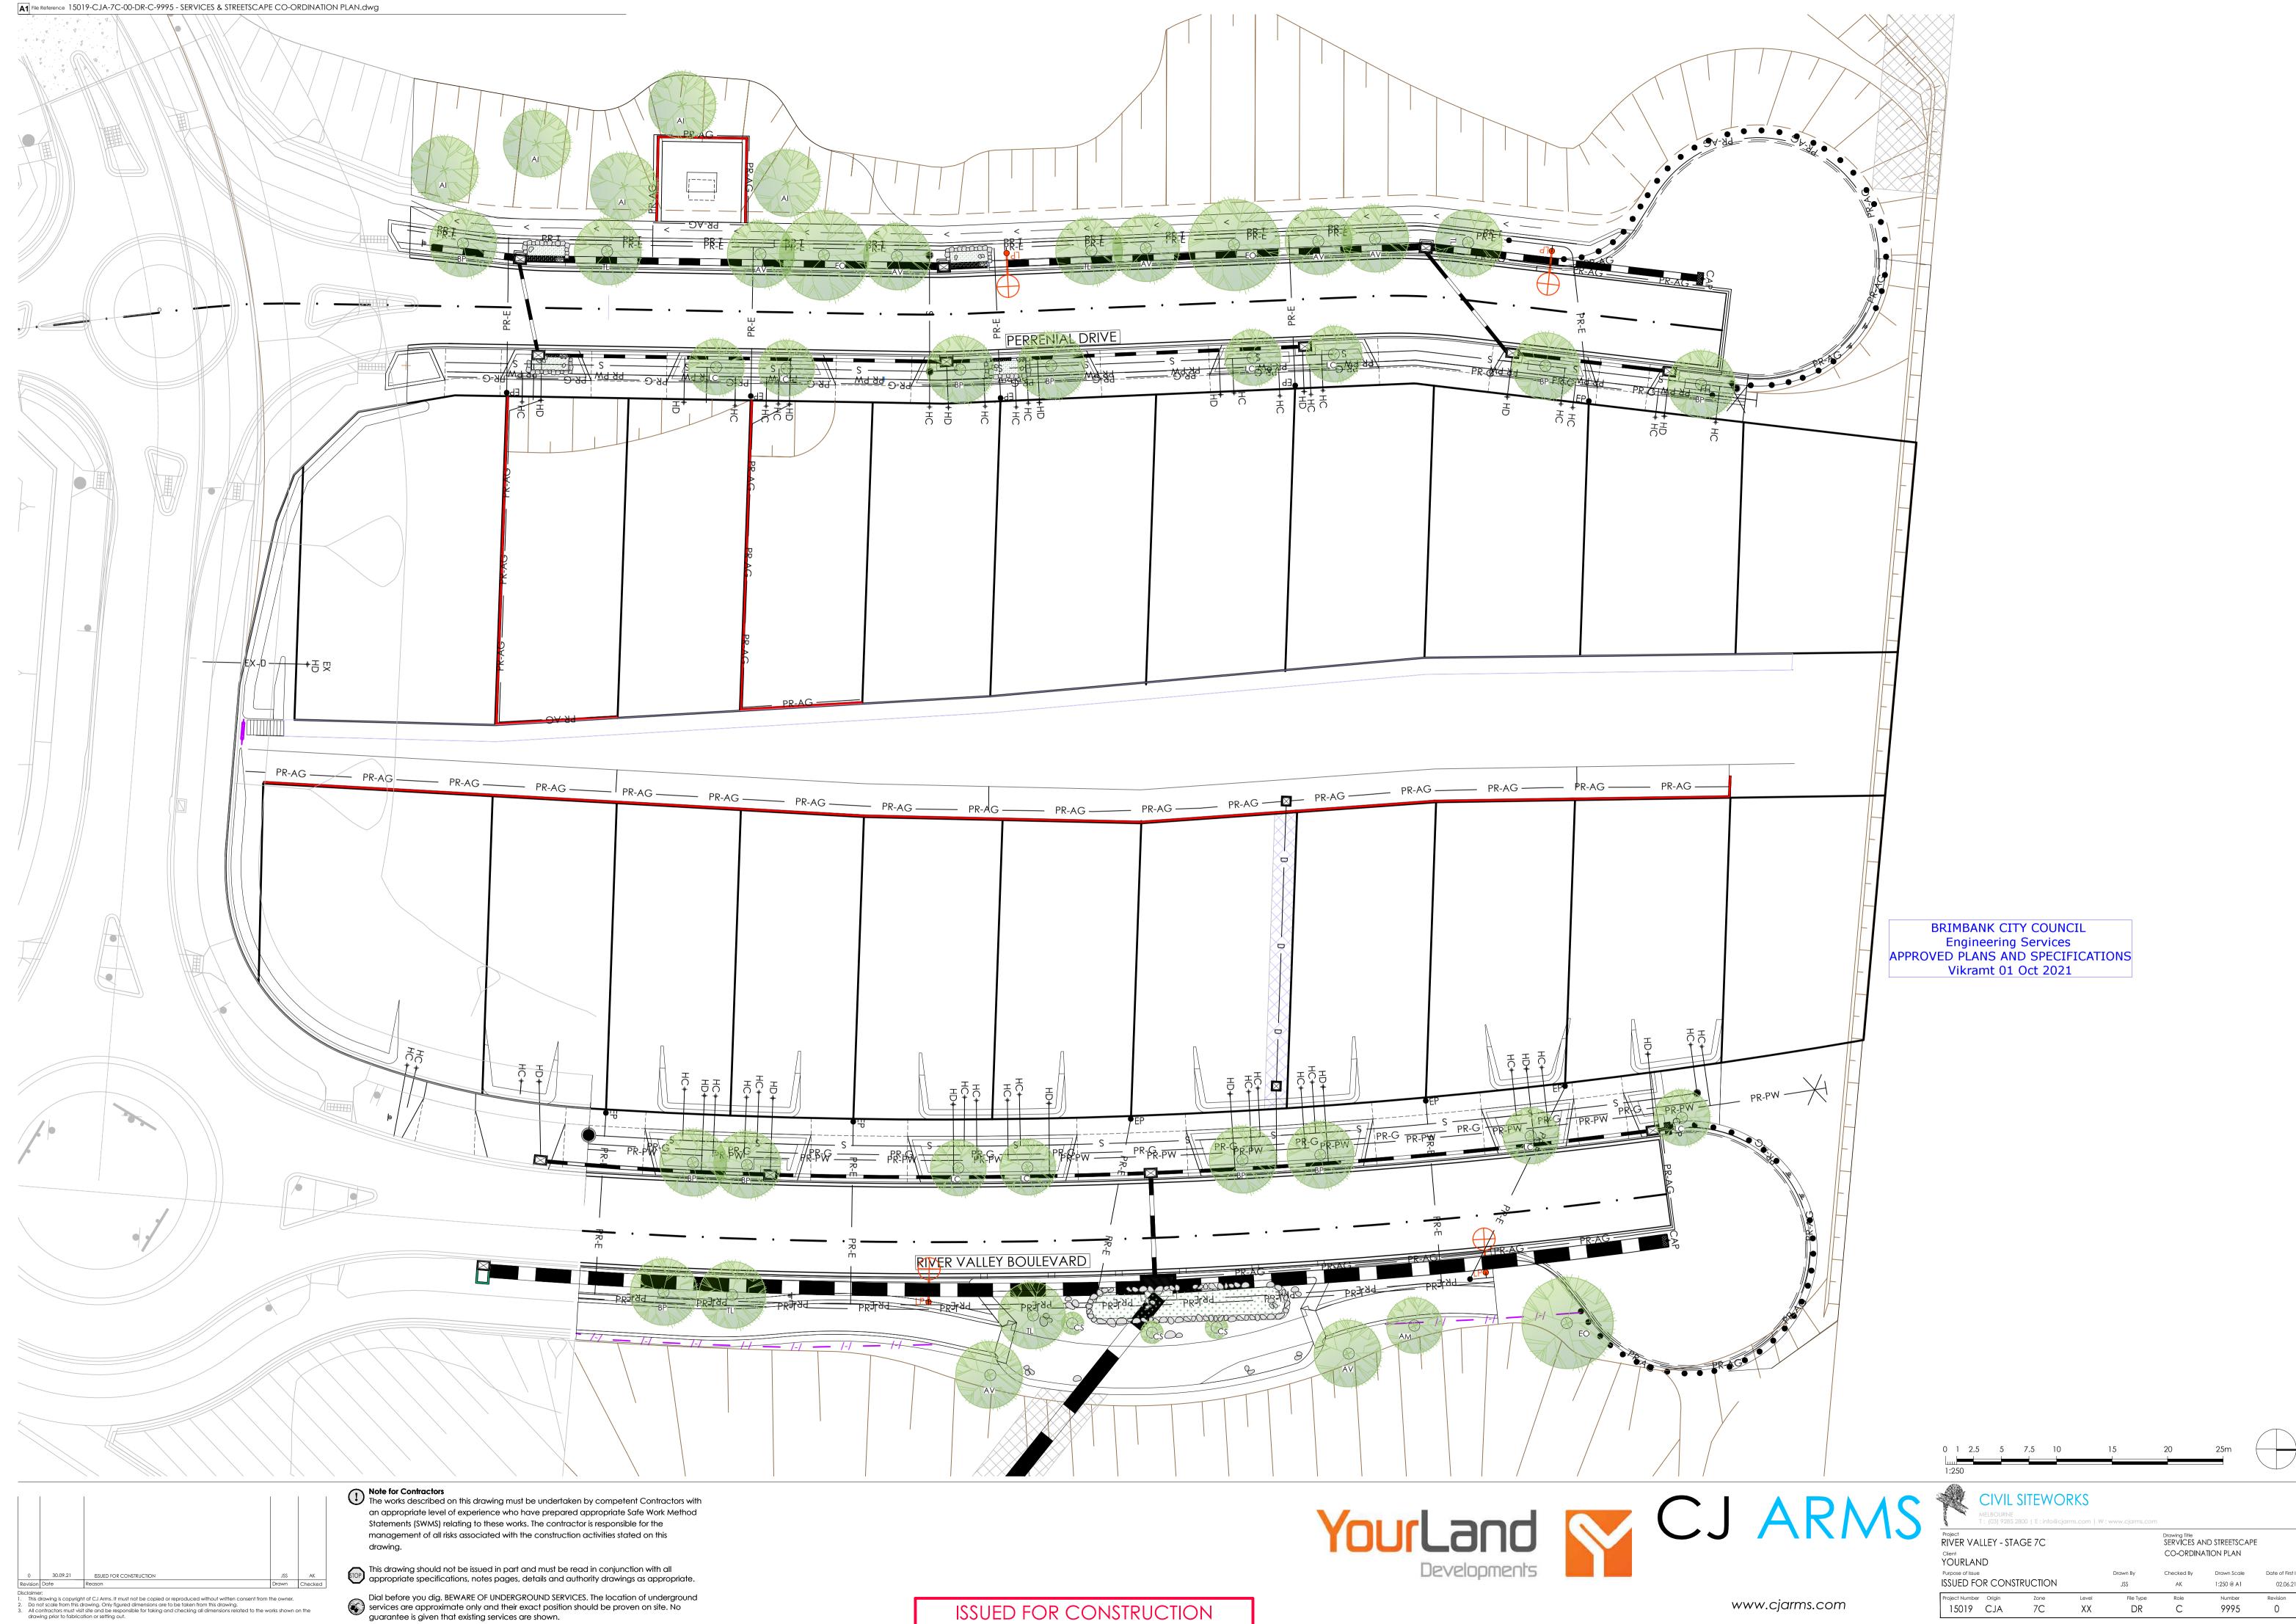







Project RIVER VALLEY - STAGE 7C Drawing Title
SUB-DIVISION PLANS SHEET (4 OF 4) ISSUED FOR CONSTRUCTION 15019 CJA DR 9203





ISSUED FOR CONSTRUCTION

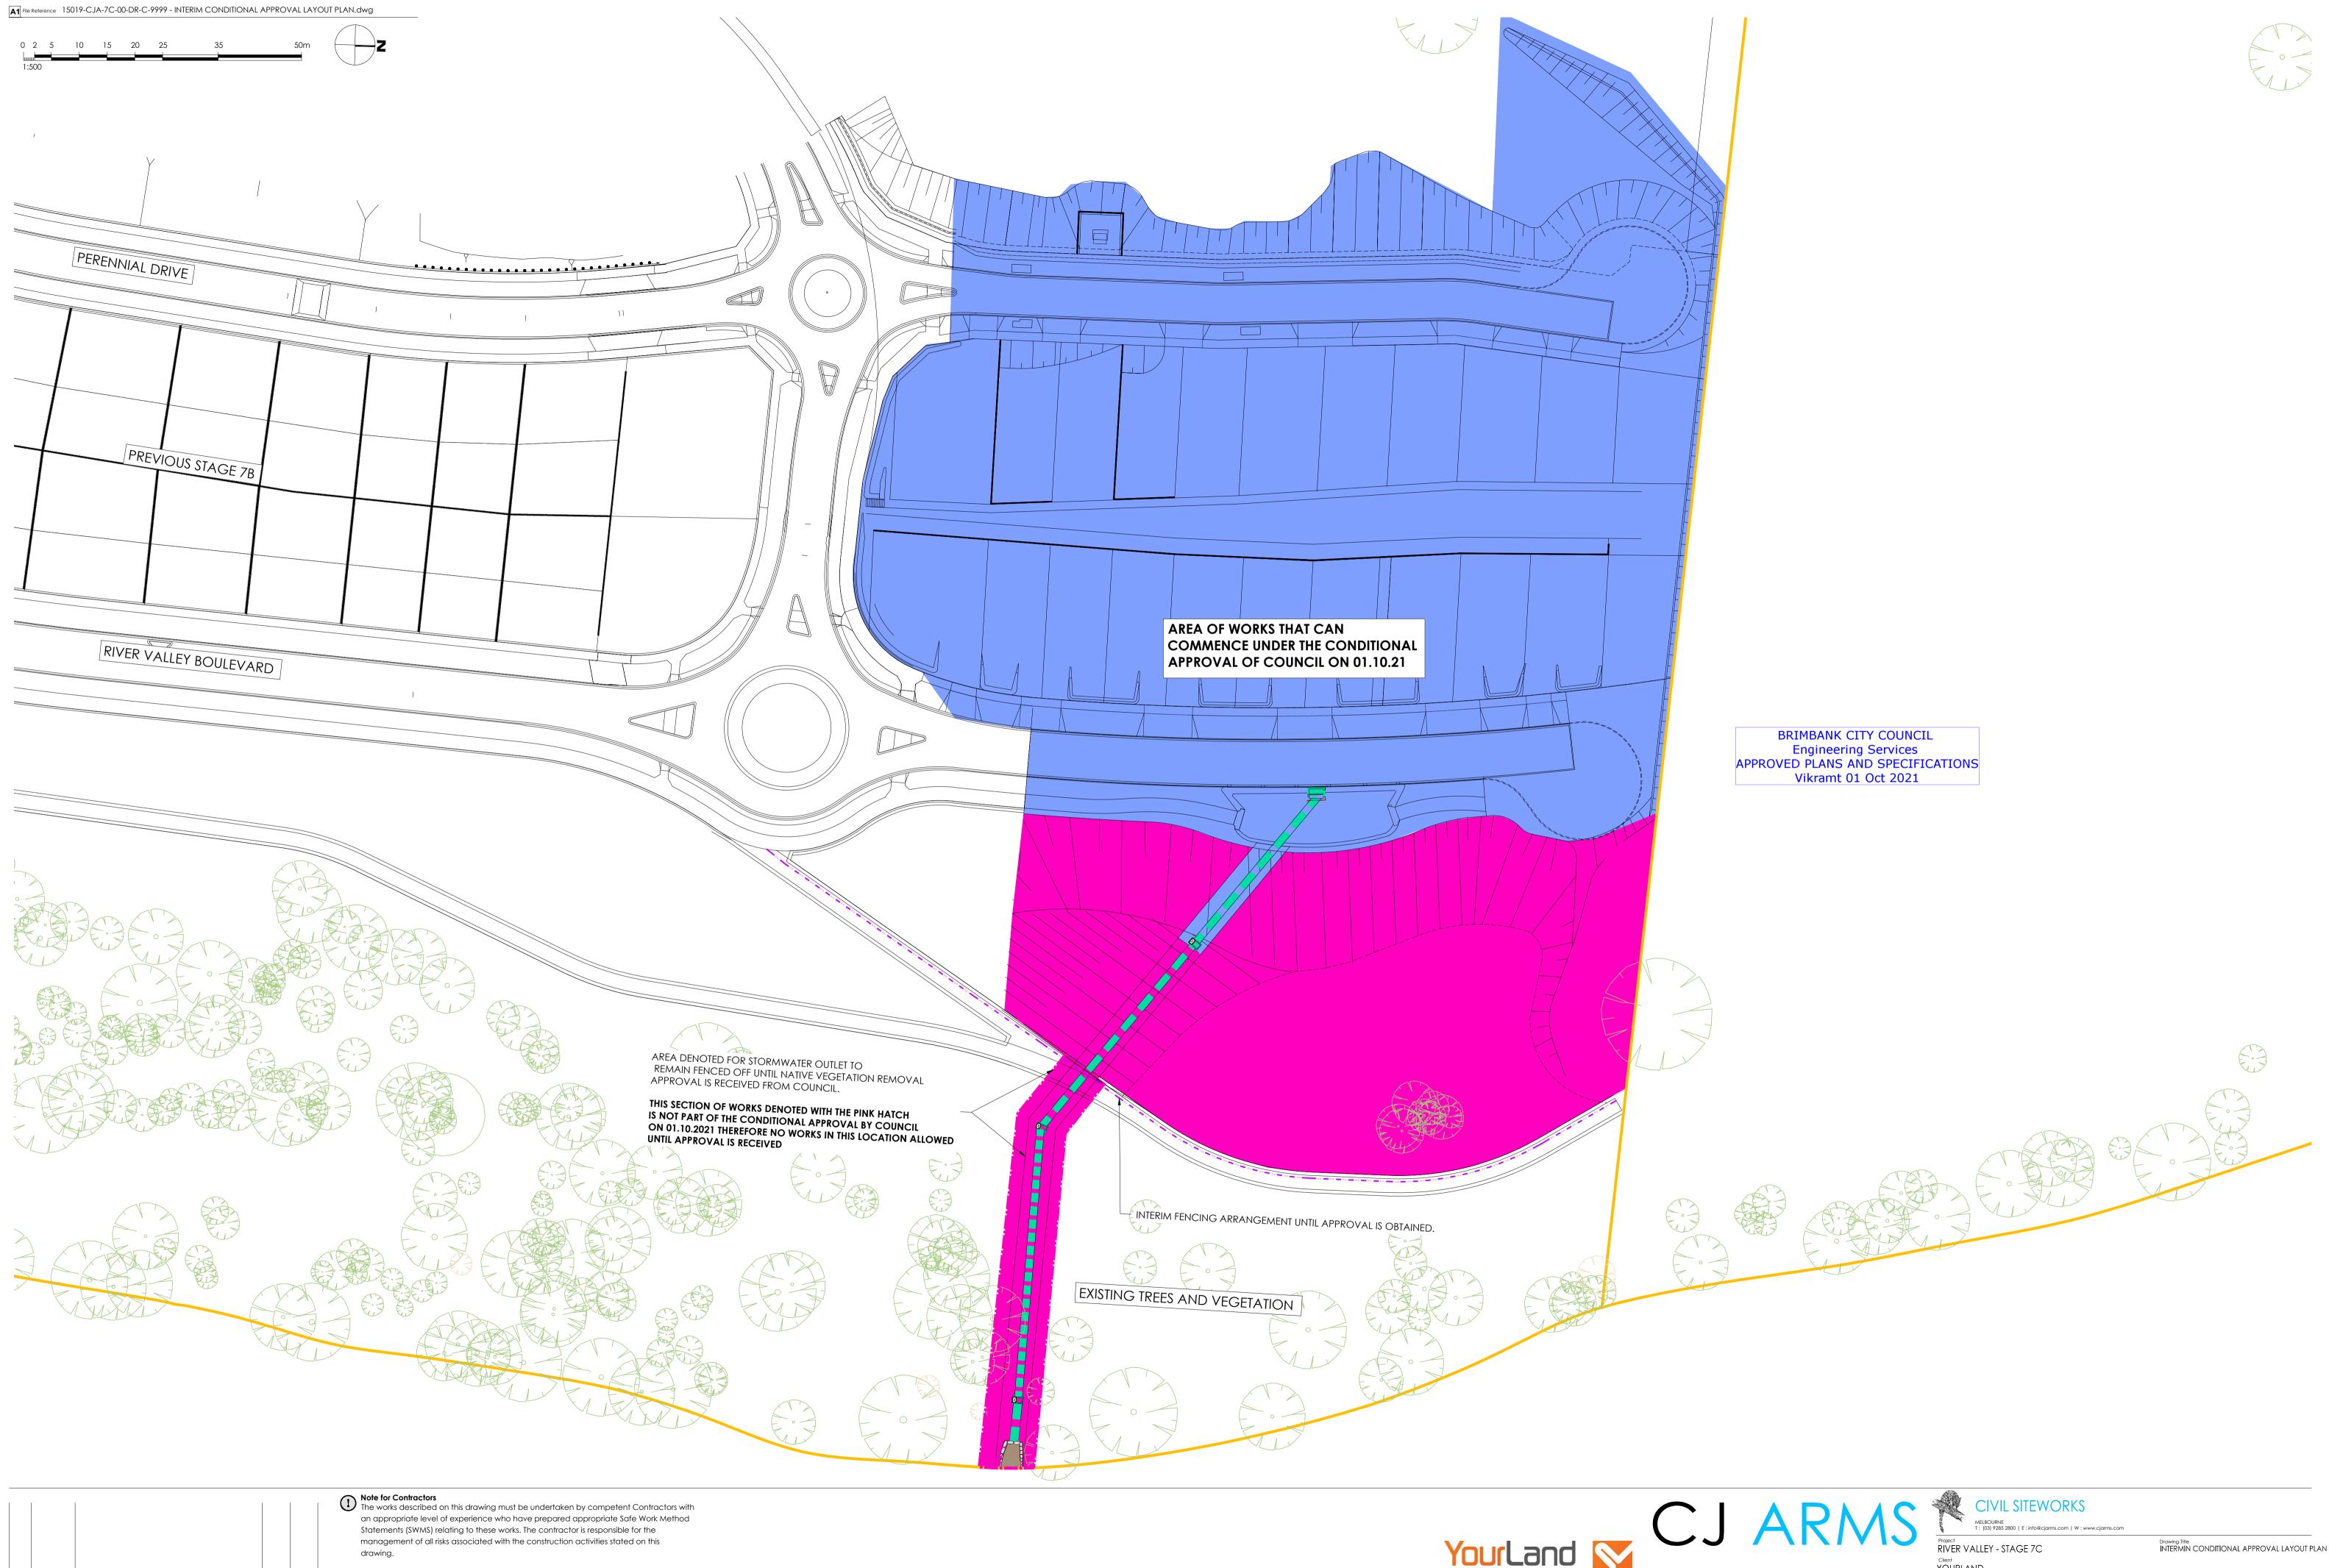

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Client YOURLAND Purpose of Issue
ISSUED FOR CONSTRUCTION

15019 CJA 7C

PROVIDE CATCH DRAIN AT TOE OF 1V:2H CUT BATTER. OVIDE 100mm THICK CRUSHED ROCK FINISH WITH SEDIMENT

FILTER SOCKS WITHIN INVERT AT 50m CTS. CONNECT

FUTURE STAGE 7D

STAGE 7B

PROVIDE TEMPORARY BATTER TO MATCH EXISTING

FOOTHPATH/PAVEMENT LEVELS (TYPICAL)

RIVER VALLEY BOULEVARD

ALLOW TO MATCH EARTHWORKS

INTO EXISTING BATTER (TYPICAL)

TO 7B DRAINAGE SYSTEM

CONTRACTOR SHALL ALLOW TO MANAGE

INTERFACE WITH ROUND-ABOUT CONSTRUCTION WORKS. WORKS ESTIMATED COMPLETION JUNE 2021.

PROVIDE 1V:2H TEMPORARY BATTER TO


EXISTING. PROVIDE JUTEMESH OVER

EXPOSED CUT.

-2.88

-0.76

VOLUMETRIC ANALYSIS							
NUMBER	COLOUR	MIN ELEVATION (m)	MAX ELEVATION (m)	2D AREA (m²)			
1		-6.000	-5.000	125.6			
2		-5.000	-4.000	540.1			
3		-4.000	-3.000	1686.6			
4		-3.000	-2.000	2519.1			
5		-2.000	-1.000	3980.5			
6		-1.000	0.000	5204.8			
7		0.000	1.000	4635.5			
8		1.000	2.000	1749.4			
9		2.000	3.000	763.6			
10		3.000	4.000	305.1			
11		4.000	5.000	284.0			
12		5.000	6.000	283.4			
13		6.000	7.000	125.3			

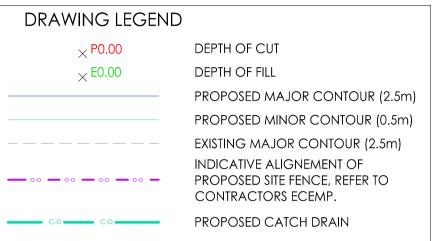

#### **BULK EARTHWORKS NOTES**

- REFER TO DRAWING EW-1001 & TONKIN + TALOR REPORT 100780.R02.V2 FOR EARTHWORKS SPECIFICATION.
- 2. THE CONTRACTOR SHALL INSTALL ALL APPROPRIATE SEDIMENT AND EROSION CONTROL MEASURES IN ACCORDANCE WITH THE EPA GUIDELINES PRIOR TO COMMENCING STRIPPING, AND IN ACCORDANCE WITH THE APPROVED ECEMP.
- 3. ALL WORKS SHALL BE IN ACCORDANCE WITH THE ENDORSED/APPROVED MANAGEMENT PLANS AS NOTED.
- 4. BULK EARTHWORKS VOLUMES ARE BASED ON A SITE STRIP OF 200mm. STRIPPING OF ANY ORGANIC OR UNSUITABLE MATERIAL SHALL BE ALLOWED FOR AS DIRECTED BY THE SUPERVISING GEOTECHNICAL AUTHORITY.
- VOLUMES HAVE BEEN CALCULATED ON THE BULKING LEVELS SET BELOW THE FINISHED SURFACE LEVELS BASED ON THE GEOTECHNICAL PAVEMENT DESIGN (TONKIN + TAYLOR #100780.R02.v2) AND AS BELOW:
- MINUS 150mm LANDSCAPE BATTERS AND FOOTPATHS
- MINUS 175mm SHARED FOOTPATHS
- MINUS 370mm PAVEMENT THICKNESS PROFILE FOR PERRNIAL DRIVE WHERE FOUNDED ON ROCK SUBGRADE (inc 400mm HORIZONTAL EXTENSION FOR KERB
- MINUS 715mm PAVEMENT THICKNESS PROFILE FOR PERENNIAL DRIVE, WHERE FOUNDED ON CLAY SUBGRADE (inc 400mm HORIZONTAL EXTENSION FOR KERB
- MINUS AND 825mm RIVER VALLEY BOULEVARD, WHERE FOUNDED ON CLAY
- SUBGRADE. (inc 400mm HORIZONTAL EXTENSION FOR KERB SUBBASE) - MINUS 230mm TEMPORARY TURNING HEADS
- RETAINING WALL THICKNESSES NOMINATED ON THE PLAN
- NO TOPSOIL DRESSING OF LOTS
- ALLOWANCES SHALL BE MADE BY THE CONTRACTOR TO TRANSITION FROM THE BULKING DEPTHS BETWEEN ZONES.
- 6. THE APPROXIMATE SITE EARTHWORKS VOLUMES BASED ON THE BULK EARTHWORKS SURFACE COMPARISON TO THE STRIPPED SITE (MINUS 200mm) ARE:
- CUT: 23 900m³
- FILL: 13 300m³
- NET: 10 600m³ (EXCESS MATERIAL)


EXCESS MATERIAL SHALL BE STOCKPILED ON SITE IN ACCORDANCE WITH THE APPROVED

WHERE DIRECTED BY THE SUPERINTENDENT - EXPORT MATERIAL TO THE BORAL DEER PARK

FACILITY VIA THE ACCESS ROUTES NOTED ON THE ENDORSED ECEMP. THE RESPONSIBLE AUTHORITY SHALL BE NOTIFIED SHOULD THE DISPOSAL SITE VARY TO THAT APPROVED.

NOTE: THE ABOVE VOLUMES DO NOT TAKE INTO ACCOUNT RECTIFICATION OF UNSUITABLE SUBGRADE ETC. THE CONTRACTOR SHALL MAKE APPROPRIATE ALLOWANCES FOR MANAGEMENT OF ADDITIONAL SPOIL.

THE ABOVE VOLUMES ARE APPROXIMATE ONLY AND THE CONTRACTOR SHALL SATISFY

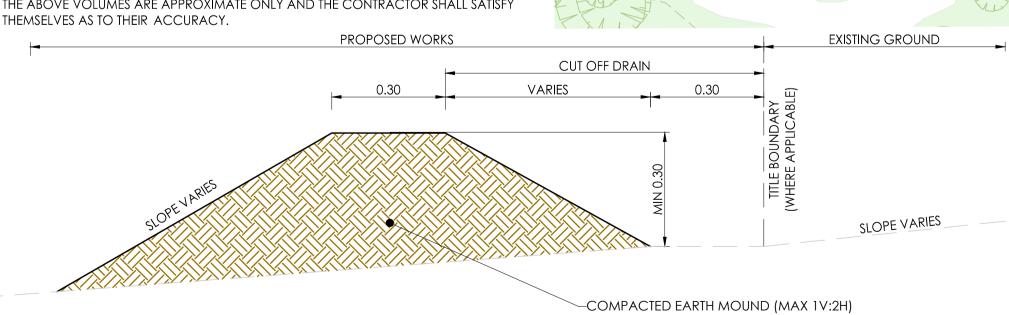

BOUNDARY BUND DETAIL - TYPICAL DETAIL **SCALE 1:10** 

28.04.21 10.03.21 CONSTRUCTION ISSUE - WALL OFFSET AMENDED CONSTRUCTION ISSUE 30.09.20 TENDER ISSUE

## DRAFT ISSUE

- BCC ENVIRONMENTAL TEAM TO BE NOTIFIED 7 DAYS- PRIOR TO COMMENCEMENT OF WORKS. ALL RUBBISH STOCKPILES TO BE DISPOSED OF IN ACCORDANCE WITH EPA REQUIREMENTS.
- TEMPORARY SLOPE PROTECTION OF PRIVATE PROPERTIES AND RESERVE AREA TO BE PROVIDED TO COUNCILS SATISFACTION PRIOR TO PC/SofC, WHICHEVER IS EARLIER.
- ALL CONTRACTORS AND SUBCONTRACTORS SHALL BE INDUCTED INTO THE REQUIREMENTS OF THIS PLAN AND THE ASSOCIATED REFERENCED MANAGEMENT PLANS.

₹ 062

ILL WORKS SHALL BE UNDERTAKEN IN ACCORDANCE WITH THE ENDORSED PLANS AND REPORTS UNDER PLANNING PERMIT P0186/2017, INCLUDING BUT NOT LIMITED TO:

REF: FROG SALVAGE PLAN - 8135 (30.1) [ENDORSED 25/01/2021 BY SUKH KAUR] REF: BL&A WEED MANAGEMENT PLAN - 8135 (28.1) [ENDORSED 25/01/2021 BY SUKH KAUR]

4.00

2.61

REF: GOLDERS ENDORSED EMP SOIL MANAGEMENT PLAN - 1528405-011-R (Rev 3) [ENDORSED 03/02/2021 BY SUKH KAUR]

FUTURE STAGE 7E

-2.48 -3.59 -2.52

1.26

4.58

-2.81

- 002

OFFSET OF BASE OF WALL AMENDED

-2.45 b

-1.13

-0.20

-2.85

4.77

1.58

0.74

0.16

NO WORKS WITHIN THIS ZONE

REF: ENDORSED ECEMP - DEC 2020 (Rev 5) [ENDORSED 10/12/2020 BY SUKH KAUR] REF: EXTENT CULTURAL HERITAGE MANAGEMENT PLAN - AV #14285



www.cjarms.com

PROVIDE 300mm HIGH BUND TO RE-DIRECT RUNOFF AROUND TO

ALLOW TO PROVIDE PLATFORM AT VARYING

WIDTHS (AS SHOWN) FOR FUTURE GEOGRID INSTALLATION

MATCH EXISTING LEVELS AT SITE BOUNDARY AND PROVIDE

TREE TO BE PROTECTED THROUGHOUT

ALONG EXTENT OF TPZ.

WORKS. SITE FENCING TO BE PROVIDED

300mm HIGH BUND AT 1M OFFSET FROM BOUNDARY. REFER TO DETAIL D.01.

(TO BE COMPLETED AS PART OF CIVIL WORKS APPROVAL & CONTRACT)

FUTURE STAGE 9

PROPOSED WORK SITE. MIN 1% LONGITUDINAL GRADE.

YOURLAND

**BRIMBANK CITY COUNCIL** Engineering Services

APPROVED PLANS AND SPECIFICATIONS

Vikramt 01 Oct 2021

EARLY WORKS PACKAGE

ROUGH THE EXCAVATION OF THE SITE

OTE: FILL IS DEFINED AS ANY SOIL, ROCK, SUBSTRATE, CLAT, SAND OR OTHER NATURAL MATERIAL GENERATED

Drawing Title
BULK EARTHWORKS LAYOUT RIVER VALLEY - STAGE 7C SHEET (1 OF 2) FOR CONSTRUCTION 1:250 @ A1 15019 CJA 3000 C03 XX XX DWG EW